

Ordinance No. 124289

Council Bill No. 117855

AN ORDINANCE related to the Central Puget Sound Regional Transit Authority ("Sound Transit") authorizing the Director of the Seattle Department of Transportation to execute an amendment to the Agreement between the City of Seattle and Sound Transit for Grant of Non-Exclusive Use of a Light Rail Transit Way as related to the Central Link Light Rail Transit Project to reflect the approved alignment for the Link Light Rail Transit Project, including the revised Northgate Link Extension and portion of the East Link segment located within the City of Seattle.

Related Legislation File:

Date Introduced and Referred:	To: (committee): <i>Transportation Committee</i>
Date Re-referred:	To: (committee):
Date Re-referred:	To: (committee):
Date of Final Action:	Date Presented to Mayor: <i>9/16/13</i>
Date Signed by Mayor:	Date Returned to City Clerk: <i>9/27/13</i>
Published by Title Only	Date Vetoed by Mayor:
Published in Full Text	
Date Veto Published:	Date Passed Over Veto:
Date Veto Sustained:	Date Returned Without Signature:

The City of Seattle - Legislative Department

Council Bill/Ordinance sponsored by: Dean Rasmussen

Committee Action:

Date	Recommendation	Vote
<i>9-10-13</i>	<i>Pass</i>	<i>TR J & BH 3-0</i>

This file is complete and ready for presentation to Full Council.

Full Council Action:

Date	Decision	Vote
<i>Sept. 16, 2013</i>	<i>Passed</i>	<i>9-0</i>

Legislative Department

Ethan Melone
SDOT City of Seattle Alignment ORD
May 21, 2013
Version #1a

CITY OF SEATTLE
ORDINANCE 124289
COUNCIL BILL 117855

AN ORDINANCE related to the Central Puget Sound Regional Transit Authority (“Sound Transit”) authorizing the Director of the Seattle Department of Transportation to execute an amendment to the Agreement between the City of Seattle and Sound Transit for Grant of Non-Exclusive Use of a Light Rail Transit Way as related to the Central Link Light Rail Transit Project to reflect the approved alignment for the Link Light Rail Transit Project, including the revised Northgate Link Extension and portion of the East Link segment located within the City of Seattle.

WHEREAS, Sound Transit (formerly known as the Central Puget Sound Regional Transit Authority, or RTA) is proceeding to implement the Sound Move Plan approved by the voters in November 1996 and the Sound Transit 2 Plan (ST2) approved by the voters in November 2008 for a high-capacity regional transit system for the Central Puget Sound region; and

WHEREAS, on April 10, 2000, the Seattle City Council adopted Resolution 30128, which approved the alignment, station locations, and maintenance base location for the Central Link Light Rail Transit Project; and

WHEREAS, in July 2000, pursuant to Ordinance 119975, the City and Sound Transit executed the original Agreement Between the City of Seattle and Sound Transit for Grant of Non-Exclusive Use of a Light Rail Transit Way as Related to the Central Link Light Rail Transit Project (the “Original Agreement”); and

WHEREAS, in August 2002, pursuant to Ordinance 120788, the City and Sound Transit made technical corrections to the Original Agreement and entered into an Agreement dated August 29, 2002 and effective September 4, 2002 for Grant of Non-Exclusive Use of a Light Rail Transit Way as related to the Central Link Light Rail Transit Project (the "Agreement"); and

WHEREAS, on April 27, 2006, the Sound Transit Board adopted Resolution No. R2006-07, selecting the North Link light rail alignment, profile and station locations and identifying the Capitol Hill to University of Washington (University Link) portion of North Link as the next part of the Link Light Rail System to be constructed; and

WHEREAS, on September 24, 2007, the Seattle City Council adopted Resolution 30993, approving a revised alignment of the Sound Transit Central Link light rail line, the



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1 location of the light rail stations, and the location of the maintenance base in the City of
Seattle; and

2 WHEREAS, in October 2007, pursuant to Ordinance 122504, the City and Sound Transit entered
3 into Amendment No. 1 to the Agreement to reflect the revised alignment for the Central
Link Light Rail Project; and

4 WHEREAS, on July 28, 2011, the Sound Transit Board adopted Resolution No. R2011-10
5 selecting the light rail alignment and profiles for East Link, which extends east from
6 downtown Seattle along I-90 and includes a station in Seattle provisionally called the
Rainier Station; and

7 WHEREAS, on June 28, 2012, the Sound Transit Board adopted Resolution No. R2012-13,
8 selecting the final light rail alignment profiles for the Northgate Link Extension from the
9 University of Washington Station to the Northgate Station; and

10 WHEREAS, Resolution 31465 is being considered by the Seattle City Council along with this
11 ordinance, and that resolution would approve the revised alignment, station locations, and
12 maintenance base location for the Link Light Rail System in the City of Seattle, including
the Northgate Link Extension and East Link segments; NOW, THEREFORE,

13 **BE IT ORDAINED BY THE CITY OF SEATTLE AS FOLLOWS:**

14
15 Section 1. The Director of the Seattle Department of Transportation is hereby authorized
16 to execute an amendment to the August 29, 2002 Agreement (effective September 4, 2002)
17 between the City of Seattle and Sound Transit for Grant of Non-Exclusive Use of a Light Rail
18 Transit Way as related to the Central Link Light Rail Transit Project, substantially in the form
19 attached as Attachment 1 to this ordinance, acknowledging the revised alignment for the Link
20 Light Rail Project.


21
22 Section 2. This ordinance shall take effect and be in force thirty (30) days from and after
23 its approval by the Mayor, but if not approved and returned by the Mayor within ten (10) days
24 after presentation, it shall take effect as provided by Municipal Code Section 1.04.020.
25
26
27



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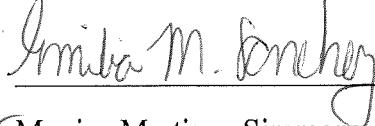
1 Passed by the City Council the 16th day of September, 2013, and signed by
2 me in open session in authentication of its passage this
3 16th day of September, 2013.

4
5 
6 President _____ of the City Council

7
8 Approved by me this 27th day of September, 2013.
9
10 

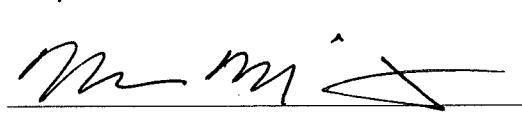11 Michael McGinn, Mayor

12 Filed by me this 27th day of September, 2013.

13
14 
15 for Monica Martinez Simmons, City Clerk
16

17 (Seal)

18 Attachments:

19 Attachment 1: Amendment No. 1 to the Agreement Between the City of Seattle and Sound
20 Transit for Grant of Non-Exclusive Use of a Light Rail Transit Way as Related to the
21 Central Link Light Rail Transit Project

22 Exhibit A to Attachment 1: General Description of Light Rail Alignment, Station Locations
23 Maintenance Facility Location

24 Exhibit B to Attachment 1: Light Rail Alignment, Station Locations, and Maintenance Facility
25 Location (Maps 1-20)

26 Exhibit C to Attachment 1: Plans and Profile Drawings



Ethan Melone
SDOT City of Seattle Alignment ATT 1
May 7, 2013
Version #1

ATTACHMENT 1

AMENDMENT NO. 2 TO THE AGREEMENT BETWEEN THE CITY OF SEATTLE AND SOUND TRANSIT FOR GRANT OF NON-EXCLUSIVE USE OF A LIGHT RAIL TRANSIT WAY AS RELATED TO THE LINK LIGHT RAIL TRANSIT PROJECT

This Amendment No. 2 (this "Amendment") to the August 29, 2002 Agreement (effective September 4, 2002) for grant of non-exclusive use of a light rail transit way as related to the Link Light Rail Transit Project is entered into by and between the City of Seattle (the "City") and the Central Puget Sound Regional Transit Authority ("Sound Transit") and is effective when signed by both parties.

RECITALS

WHEREAS, on April 10, 2000, the Seattle City Council adopted Resolution 30128, which approved the alignment, station locations, and maintenance base location for the Central Link Light Rail Transit Project that was referenced in the agreement described below; and

WHEREAS, in July 2000, pursuant to Ordinance 119975, the City and Sound Transit executed the original Agreement Between the City of Seattle and Sound Transit for Grant of Non-Exclusive Use of a Light Rail Transit Way as Related to the Central Link Light Rail Transit Project (the "Original Agreement"); and

WHEREAS, in August 2002, pursuant to Ordinance 120788, the City and Sound Transit made technical corrections to the Original Agreement and executed that corrected agreement on September 4, 2002 (the "Agreement"); and

WHEREAS, on April 27, 2006, the Sound Transit Board approved Resolution No. R2006-07, selecting a revised light rail alignment for the North Link portion of the Central Link Light Rail Transit Project between downtown Seattle and Northgate; and

WHEREAS, on September 24, 2007, the Seattle City Council adopted Resolution 30993, approving a revised alignment of the Sound Transit Central Link Light Rail line, the location of the light rail stations, and the location of the maintenance base in the City; and

WHEREAS, in October 2007, pursuant to Ordinance 122504, the City and Sound Transit executed Amendment No. 1 to the Agreement to reflect the revised North Link alignment and allow Sound Transit to proceed with the University Link project; and

WHEREAS, on July 15, 2011, Sound Transit, the Federal Transit Administration (FTA), and the Washington State Department of Transportation (WSDOT) issued a Final Environmental Impact Statement (FEIS) for the East Link light rail project to satisfy the requirements of the National Environmental Policy Act (NEPA) and the State Environmental Policy Act (SEPA); and



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May 7, 2013
Version #1

WHEREAS, on July 28, 2011, the Sound Transit Board adopted Resolution No. R2011-10 selecting the light rail alignment for the East Link Light Rail line, which extends east from downtown Seattle along I-90 and includes a station in Seattle provisionally called the Rainier Station; and

WHEREAS, after consideration of the FEIS for East Link, in November 2011, the FTA issued a Record of Decision, which finds that the federal environmental process is complete for East Link; and

WHEREAS, on June 28, 2012, the Sound Transit Board adopted Resolution R2012-13, selecting the final light rail alignment for the Northgate Link Extension from the University of Washington Station to the Northgate Station; and

WHEREAS, on _____, 20____, the Seattle City Council adopted Resolution _____, approving the revised alignment, station locations, and maintenance base location in the City of Seattle, including the Northgate Link Extension and East Link projects; and

WHEREAS, an amendment to the Agreement is required to reflect the revised Northgate Link Extension alignment and the alignment of the East Link line in the City of Seattle and allow Sound Transit to proceed with the Northgate Link Extension and East Link projects;

NOW, THEREFORE, in consideration of the mutual promises contained herein, the parties hereby agree to amend the Agreement as follows:

Section 1. The name of the Agreement is hereby changed from "Agreement Between the City of Seattle and Sound Transit for Grant of Non-Exclusive Use of a Light Rail Transit Way as Related to the Central Link Light Rail Transit Project" to "Agreement Between the City of Seattle and Sound Transit for Grant of Non-Exclusive Use of a Light Rail Transit Way as Related to the Link Light Rail Transit Project" to reflect the fact that the project includes the Northgate Link Extension and East Link segments in addition to the original Central Link portion of the project.

Section 2. Exhibit A to the Agreement, as referenced in Section 2.1 of the Agreement, is hereby replaced with Exhibit A of this Amendment.

Section 3. Exhibit B to the Agreement, as referenced in Section 2.1 of the Agreement, is hereby replaced with Exhibit B of this Amendment.

Section 4. The plans and profile drawings attached as Exhibit C of this Amendment are hereby incorporated as additional drawings into Exhibit C, replacing the corresponding Northgate Link Extension drawings of the Agreement, as referenced in Section 2.1 of the Agreement.



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SDOT City of Seattle Alignment ORD
May 21, 2013
Version #1

1 Passed by the City Council the _____ day of _____, 2013, and signed by
2 me in open session in authentication of its passage this
3 _____ day of _____, 2013.

4
5 President _____ of the City Council
6

7
8 Approved by me this _____ day of _____, 2013.
9

10
11 Michael McGinn, Mayor
12

13 Filed by me this _____ day of _____, 2013.
14

15
16 Monica Martinez Simmons, City Clerk
17 (Seal)

18 Attachments:
19 Attachment 1: Amendment No. 1 to the Agreement Between the City of Seattle and Sound
20 Transit for Grant of Non-Exclusive Use of a Light Rail Transit Way as Related to the
21 Central Link Light Rail Transit Project

22 Exhibit A to Attachment 1: General Description of Light Rail Alignment, Station Locations
23 Maintenance Facility Location

24 Exhibit B to Attachment 1: Light Rail Alignment, Station Locations, and Maintenance Facility
25 Location (Maps 1-20)

26 Exhibit C to Attachment 1: Plans and Profile Drawings



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SDOT City of Seattle Alignment EXH A
May 7, 2013
Version #1

Exhibit A:

General Description of Light Rail Alignment, Station Locations, and Maintenance Facility Location

Northgate Link Extension (Northgate to University of Washington)

Route: Elevated structure at Northgate, tunnel begins south of the Maple Leaf Portal at 94th Street.

Stations:

Northgate Station – East side of 1st Avenue NE, spanning NE 103rd Street, elevated (includes tail track)

Roosevelt Station – West side of 12th Avenue NE, north of NE 65th St, tunnel

U District Station – Brooklyn Ave NE, south of NE 45th Street, tunnel

University Link (University of Washington to Pine Street Stub Tunnel)

Route: Tunnel under University of Washington, Montlake Cut, and Capitol Hill

Stations:

University of Washington Station – East side of Montlake Boulevard NE, near Husky Stadium, tunnel (includes crossover)

Capitol Hill Station – East side of Broadway E, south of E John Street, tunnel

Initial Segment (Pine Street Stub Tunnel to S. McClellan Street)

Route: Use existing Downtown Seattle Transit Tunnel (DSTT). South of downtown, use E-3 Busway rising to elevated structure turning east along south side of S. Forest Street, and then to tunnel under Beacon Hill.

Stations:

Westlake - Tunnel

University Street - Tunnel

Pioneer Square - Tunnel

International District/Chinatown - Tunnel

Stadium – E-3 Busway at S Royal Brougham Way, at-grade

SODO – E-3 Busway, north of S Lander Street, at-grade

Beacon Hill – Beacon Avenue S at S Lander Street, tunnel

Initial Segment (S. McClellan Street to Boeing Access Road)

Route: Elevated out of Beacon Hill tunnel, then turning south on Martin Luther King, Jr. Way S, at-grade in median

Stations:

Mount Baker – S McClellan Street, elevated

Columbia City – S Edmunds Street, at-grade

Othello – S Othello Street, at-grade

Rainier Beach – S Henderson Street, at-grade

Maintenance Facility Maintenance Facility site – extends from 7th Avenue S to Airport Way S, and from S Forest Street to south of S Hinds Street.



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East Link (International District/Chinatown Station to the west edge of Lake Washington along I-90)

Route: From the International District/Chinatown Station in the Downtown Seattle Transit Tunnel coming up at grade onto the Interstate 90 Express Lanes

Stations:

Rainier Station – on I-90 center roadway east of Rainier Avenue S, at-grade



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SDOT City of Seattle Alignment EXH B
May 7, 2013
Version #1


Exhibit B

Light Rail Alignment, Station Locations, and Maintenance Facility Location

(Maps 1-20)

Northgate Link (Northgate Station to University of Washington Station).....	1-5
U-Link (University of Washington Station to Pine St.).....	6-7
Initial Segment (Pine St. to City Limit – Boeing Access Road).....	8-17
East Link (International District Tunnel Station to Lake Washington, via I-90).....	18-20



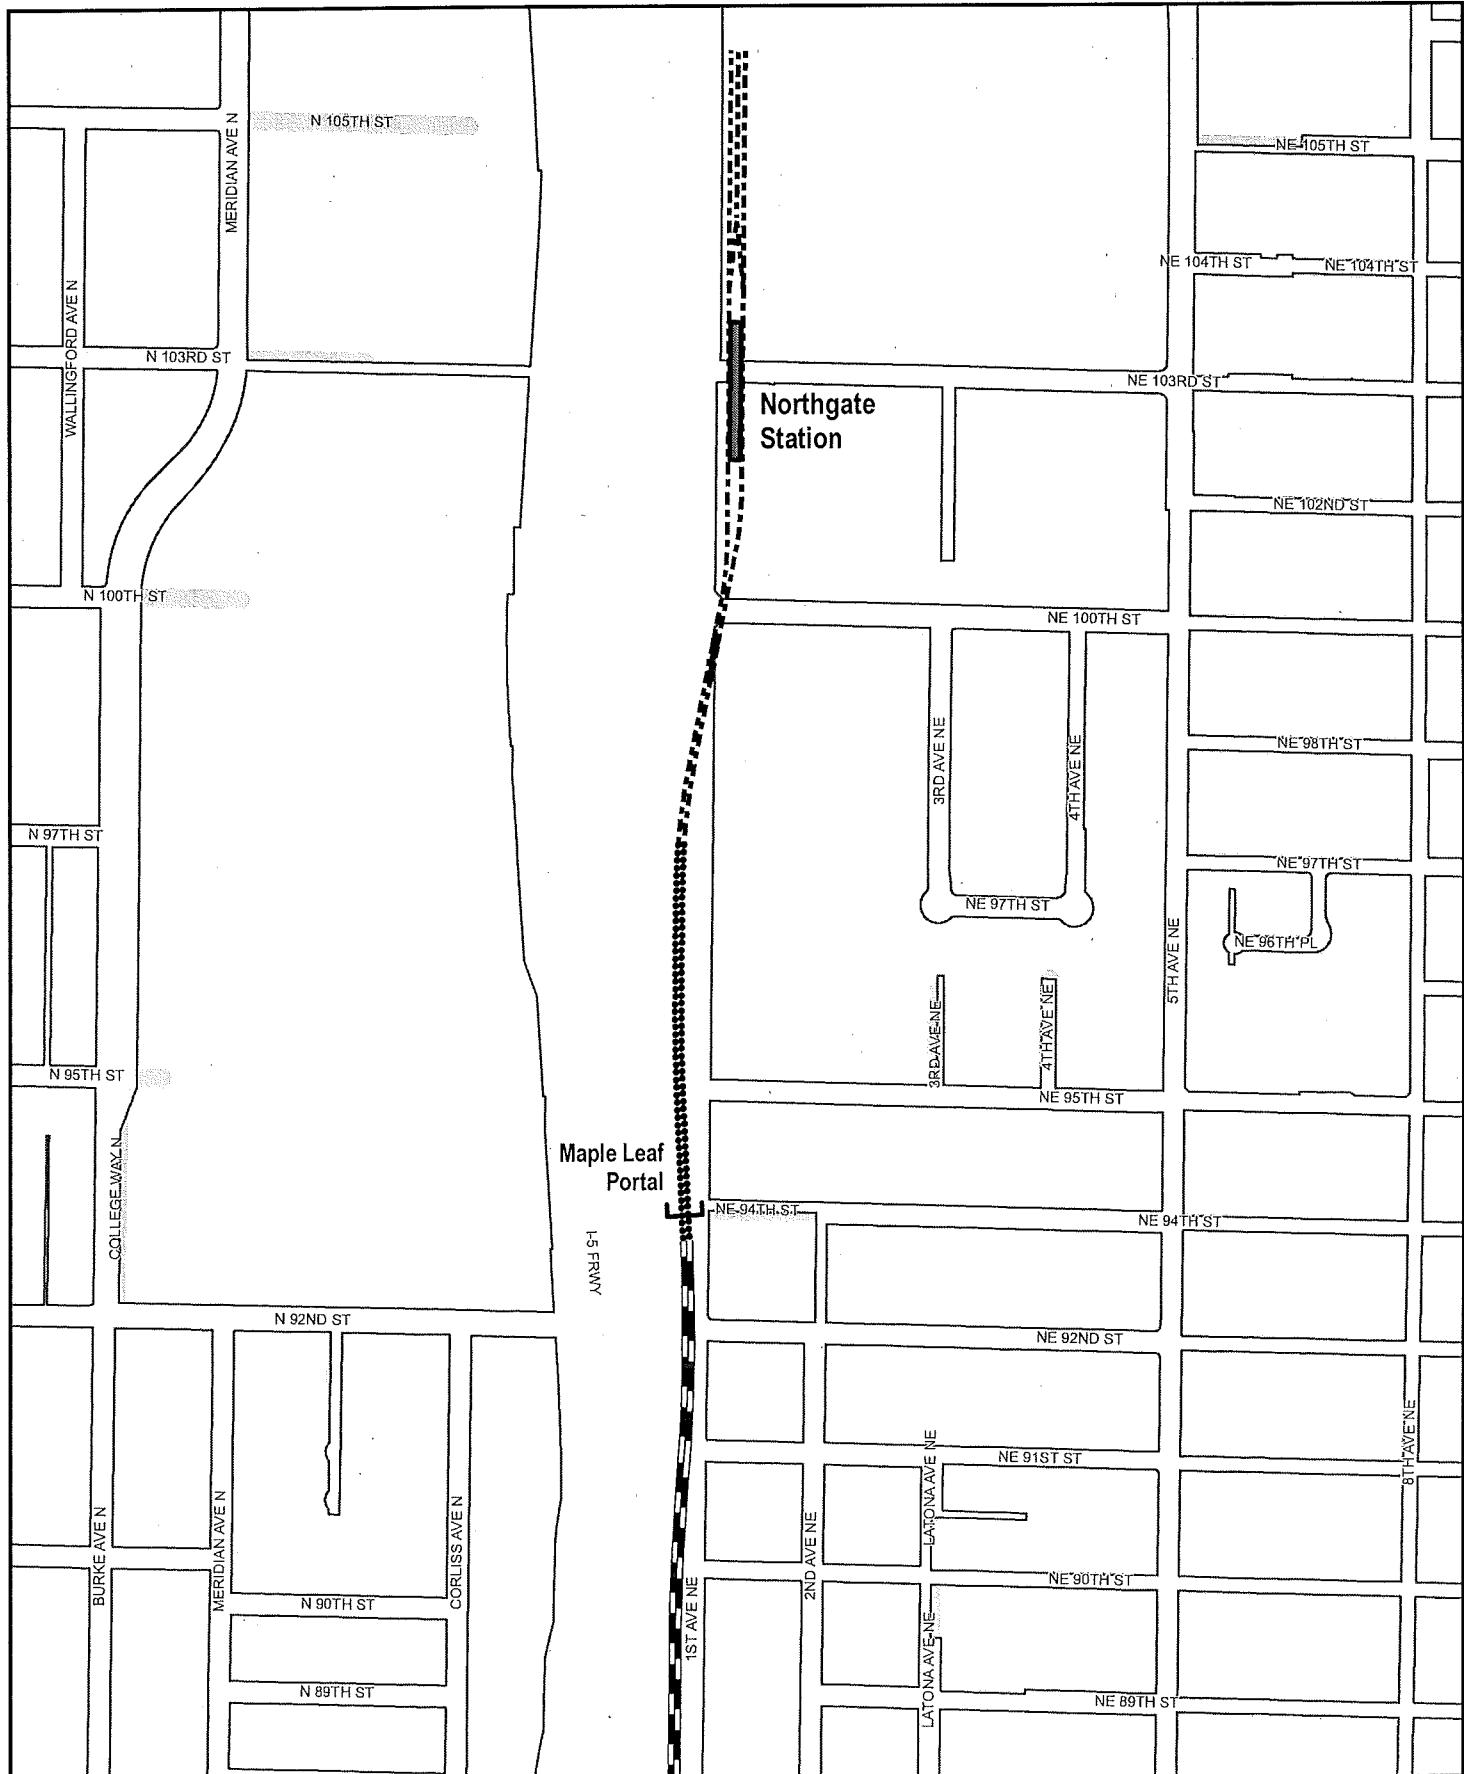

Legend

LIGHT RAIL ALIGNMENT	
— Aerial	— Cut and Cover
— At Grade	●●●● Retained Cut / Fill
— Subway	
	■ Light rail station platform
	■ Maintenance facility
	□ Right-of-way

Exhibit B: Light Rail Alignment, Station Locations, and Maintenance Facility Location
Map 1 of 20




SOUND TRANSIT
TODAY'S TRANSIT

0 250 500
Feet



Data source: King County GIS, City of Seattle, Sound Transit GIS
PROJECTSAGOLINK/Seattle/RTW/EB/Portal/2012
No guarantee of any port implied, including accuracy, completeness, or fitness for use.



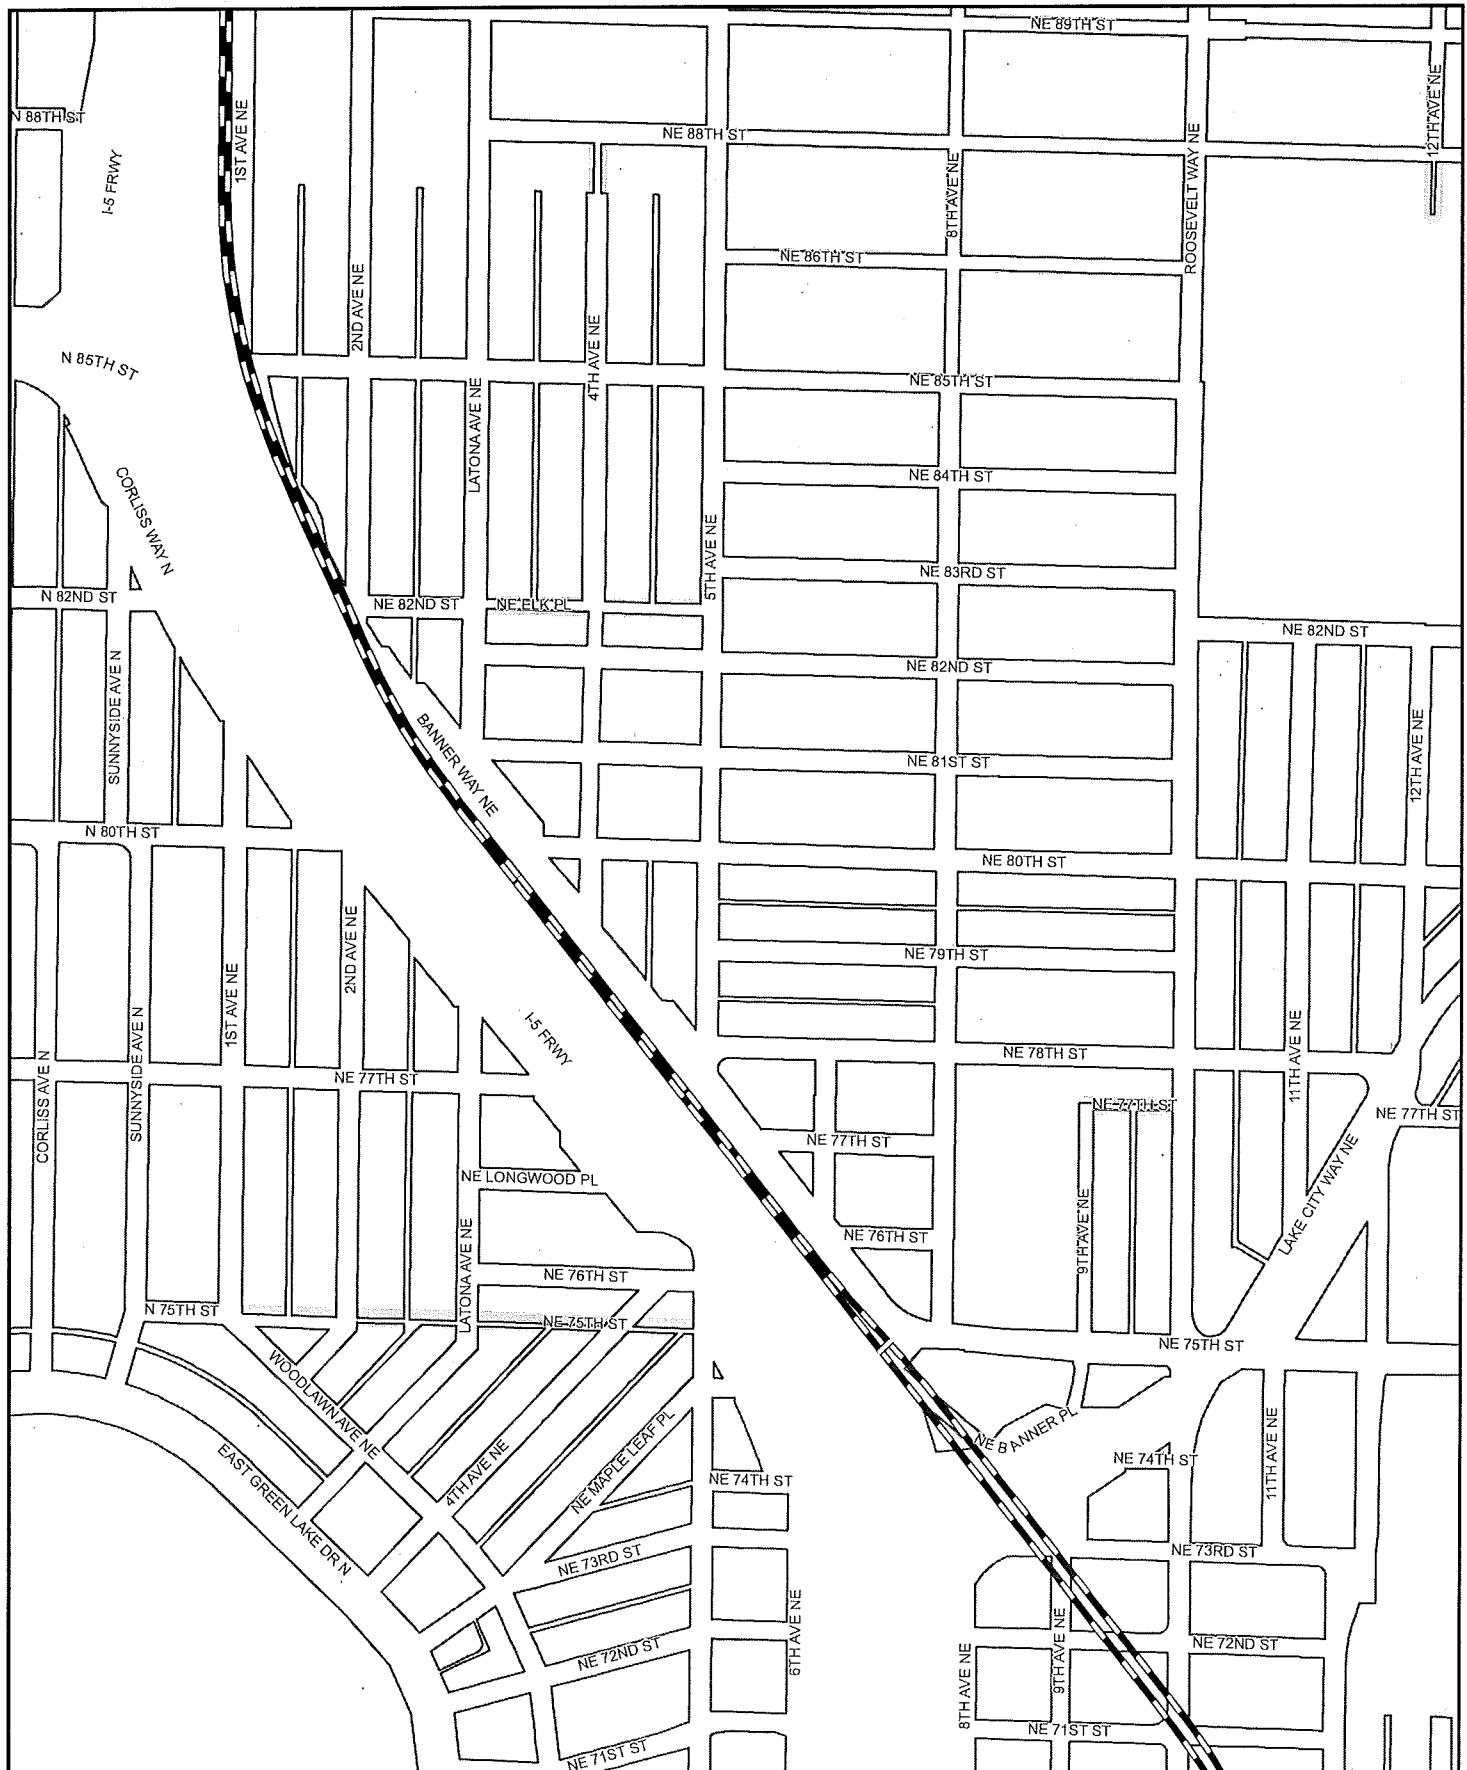

**Exhibit B: Light Rail Alignment,
Station Locations, and
Maintenance Facility Location**
Map 2 of 20

Legend

LIGHT RAIL ALIGNMENT

MENT

Cut and Cover

● Retained Cut / Fill

 light rail station platform

— 1 —


Maintenance facil

Right-of-way



A horizontal scale bar with tick marks at 0, 250, and 500. Below it is the label "Feet".

Data source: King County CIS, City of Seattle, Sound Transit 3D
G:\PROJECTS\9002\LINK\NorthSeattleROW\Exhibit\Map\j2012
No guarantee of any sort implied, including accuracy, consistency, or fitness for use

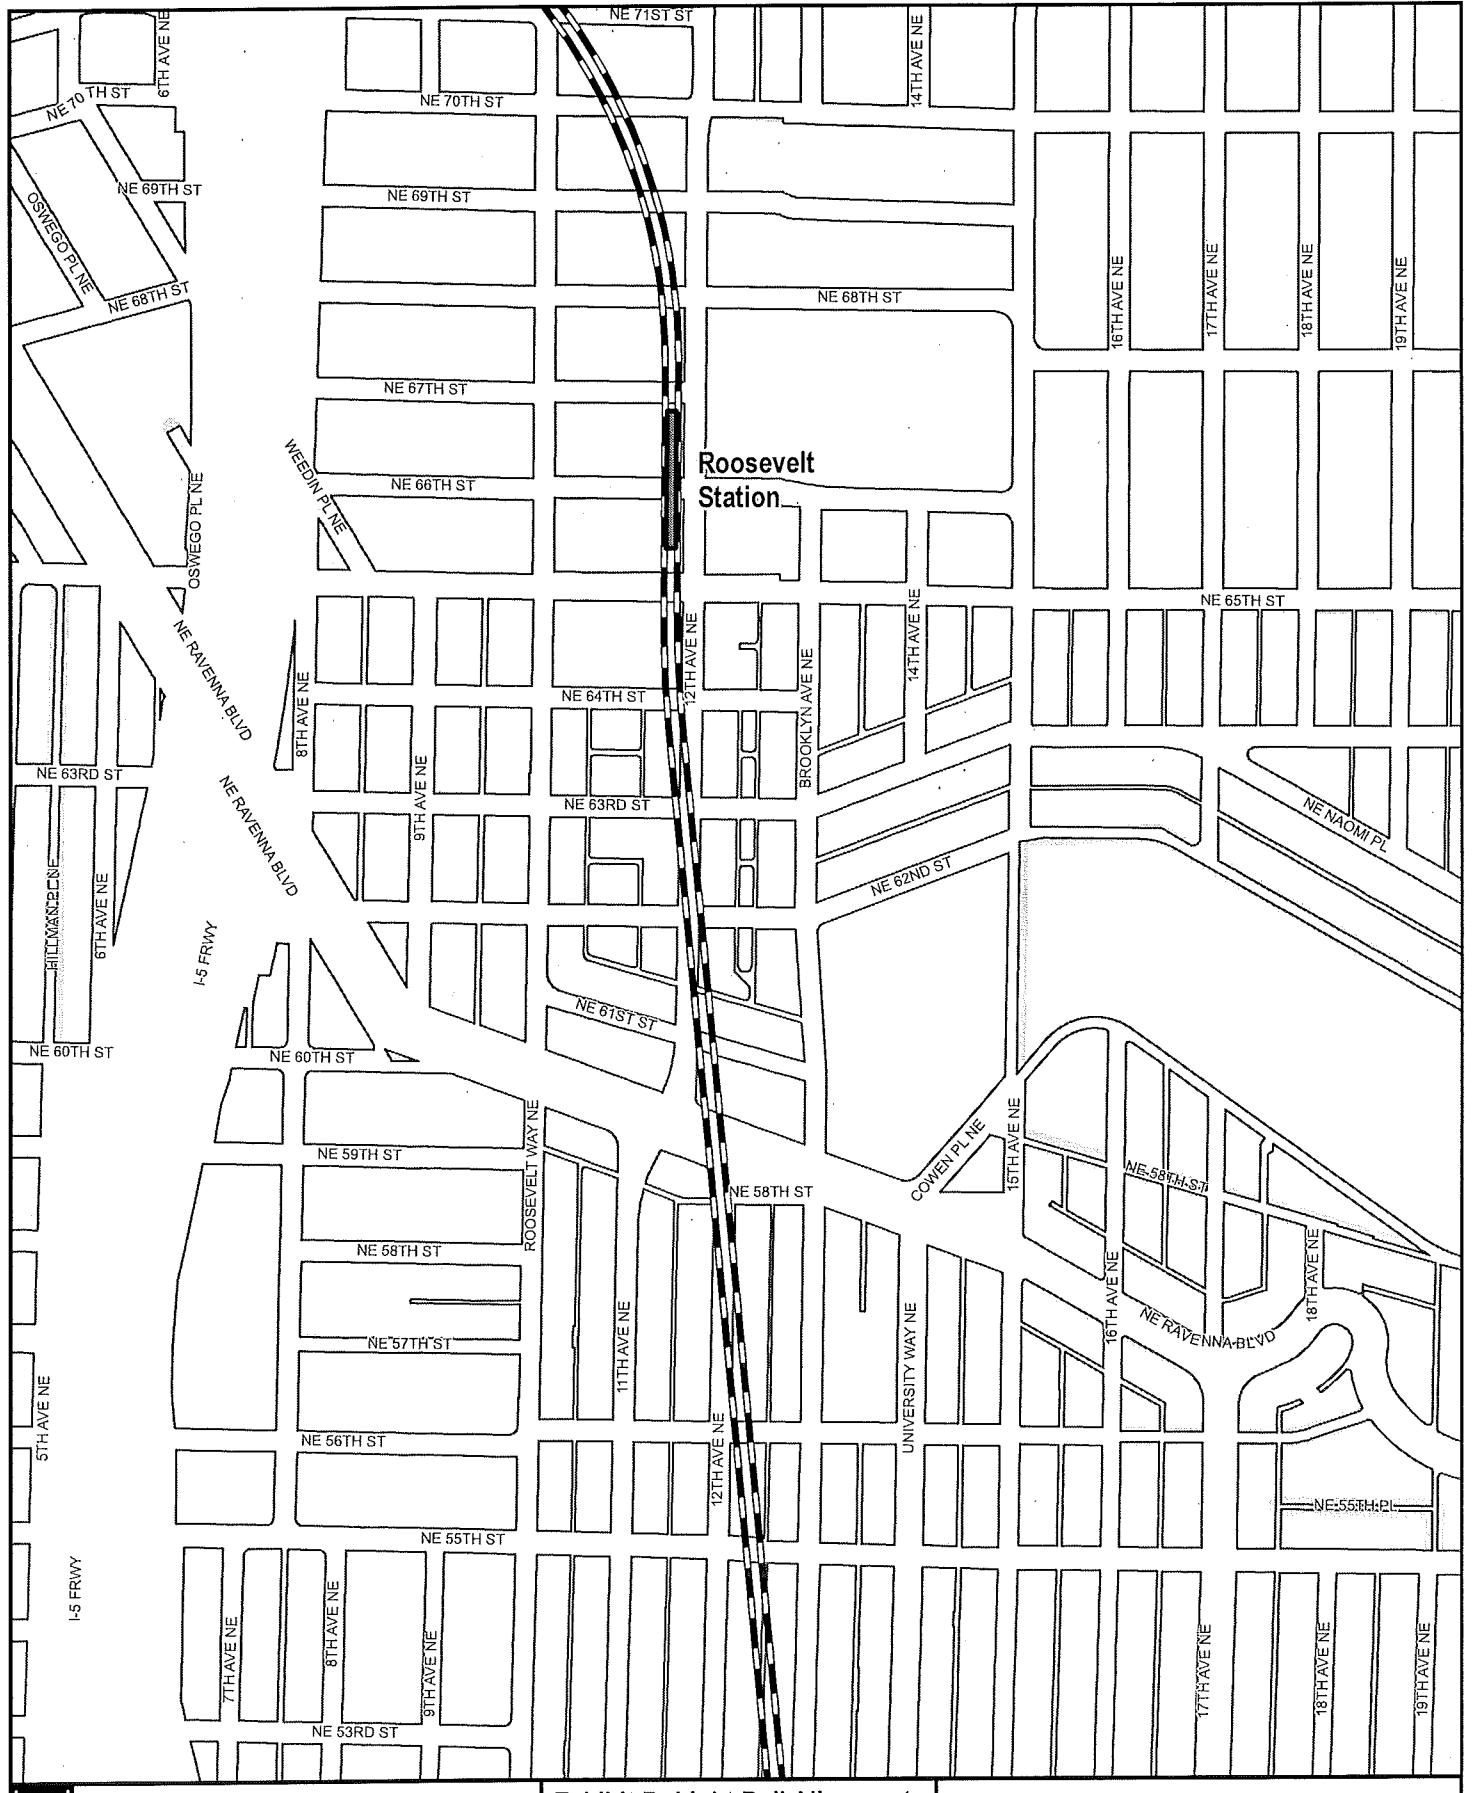

**Exhibit B: Light Rail Alignment,
Station Locations, and
Maintenance Facility Location**
Map 3 of 20



A horizontal scale bar with three numerical markings: 0, 250, and 500. Below the scale bar, the word "Feet" is centered.

Dale Connor King County GIS, City of Seattle, State Transit GIS
PROJECTS@G2LINKNorthSeattleRCGExhibitW@G2LINK

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Legend

LIGHT RAIL ALIGNMENT

Aerial Cut and Cover
 At Grade Retained Cut / Fill
 Subway

 Light rail station platform
 Maintenance facility
 Right-of-way

**Exhibit B: Light Rail Alignment,
Station Locations, and
Maintenance Facility Location
Map 4 of 20**




SoundTransit

0 250 500
Feet

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Data source: King County GIS, City of Seattle, Sound Transit GIS
GPRCONNECTS@2021NWS-NorthwestPOWERdashmap2021
No guarantee of any sort implied, including accuracy, completeness, or fitness for use.



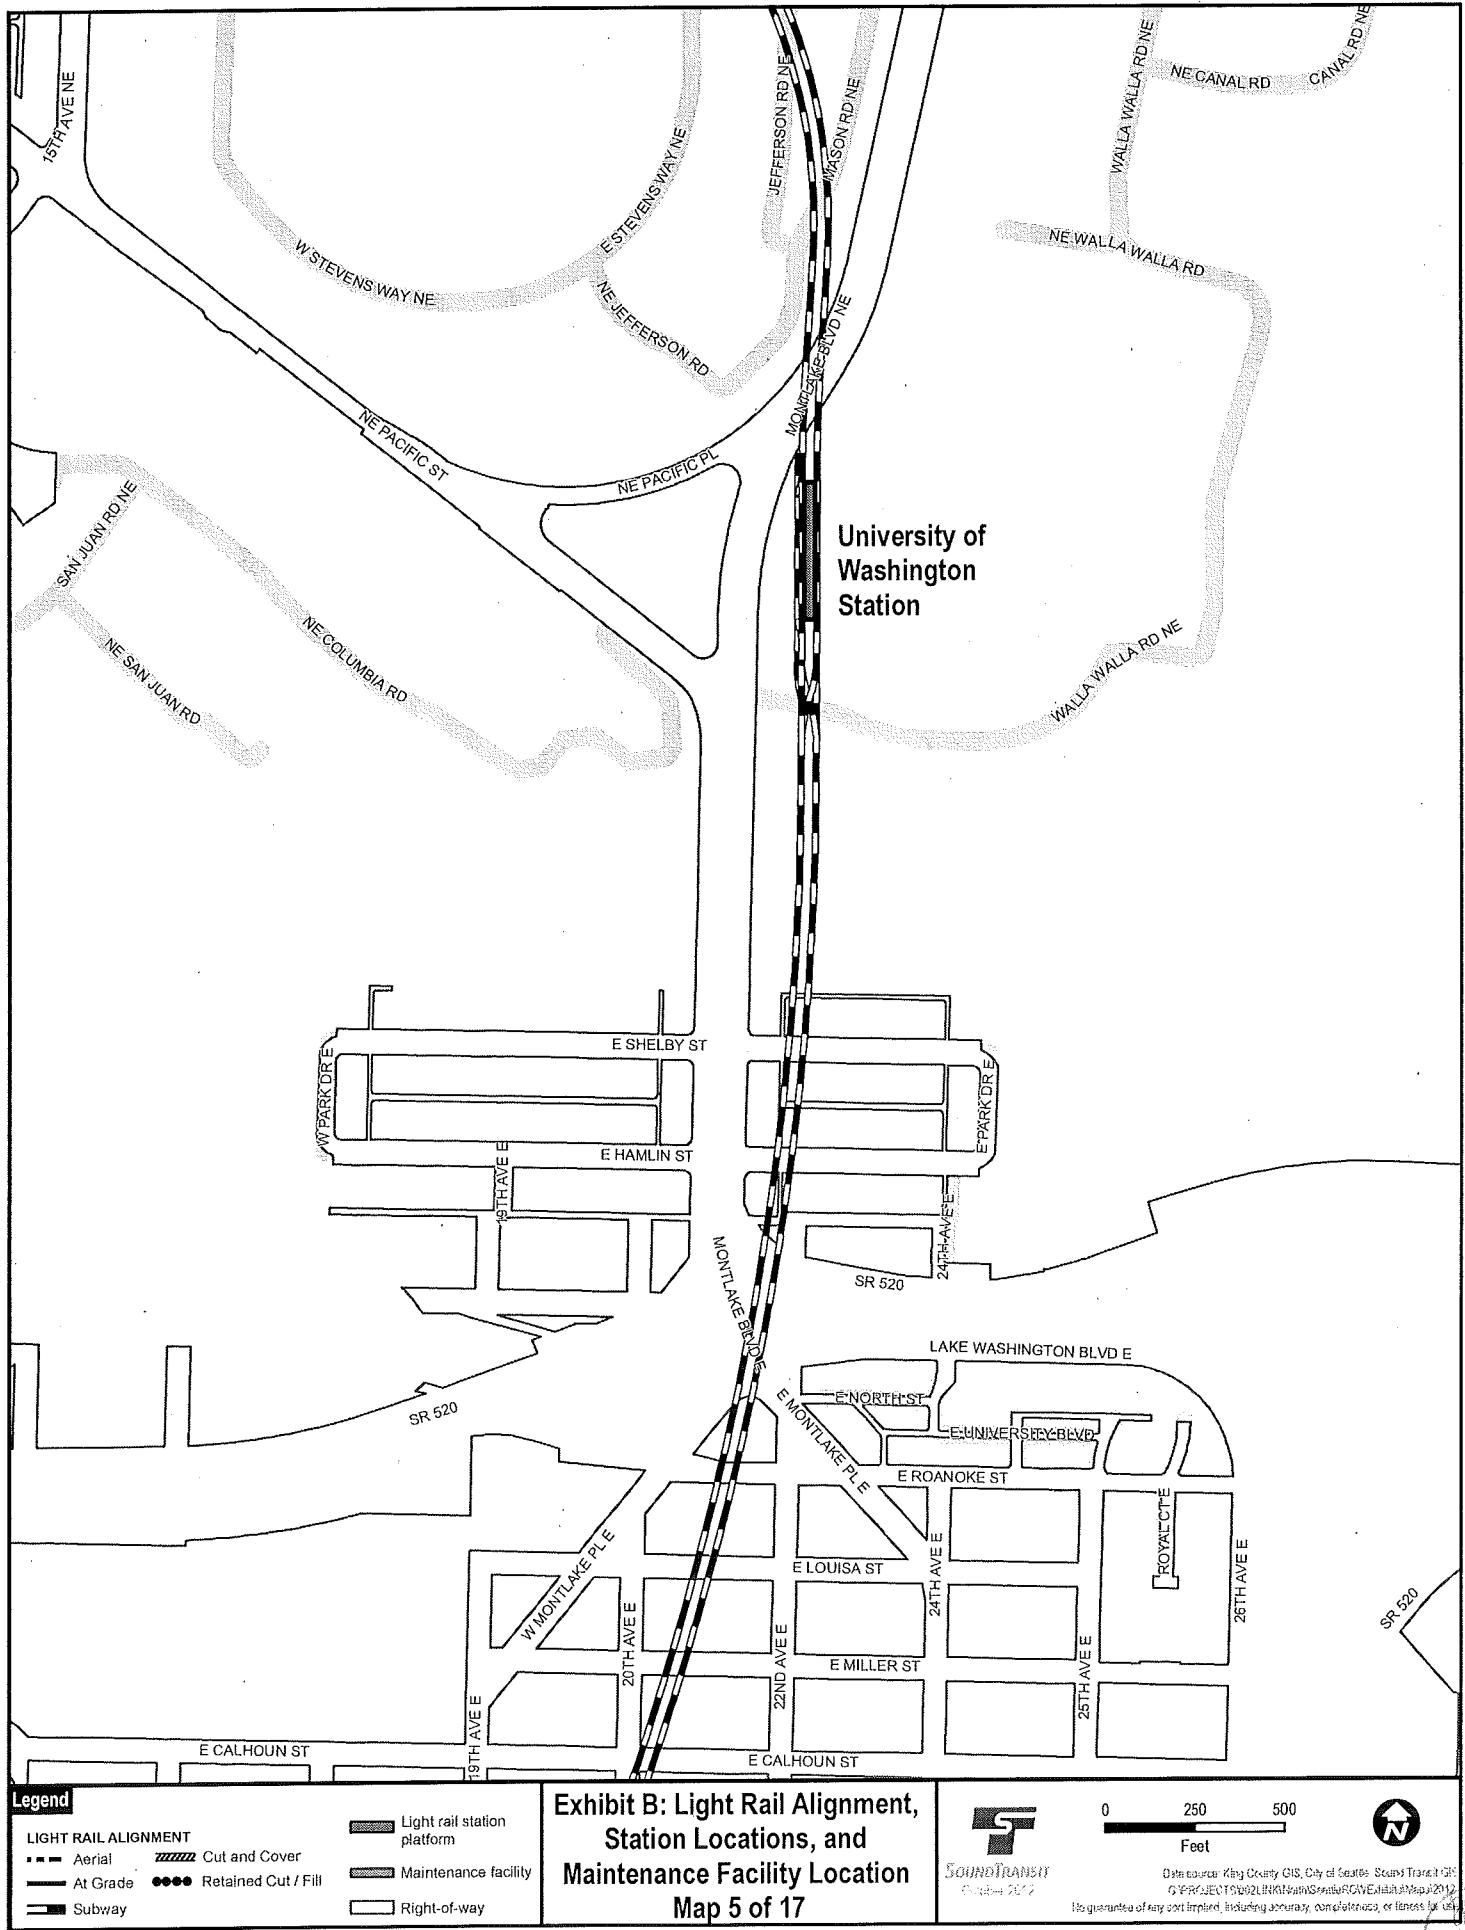

Legend

LIGHT RAIL ALIGNMENT

 Aerial  Cut and Cover
 At Grade Retained Cut / Fill

 Subway

 Light rail station platform

Maintenance facility


Maintenance Right-of-way

**Exhibit B: Light Rail Alignment,
Station Locations, and
Maintenance Facility Location
Map 6 of 20**



SoundTransit
October 2014

Data source: King County GIS, City of Seattle. Sound Transit 505
G PROJECT DECLARATION OF INVESTMENT ROW Exhibit Map 1012
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Legend

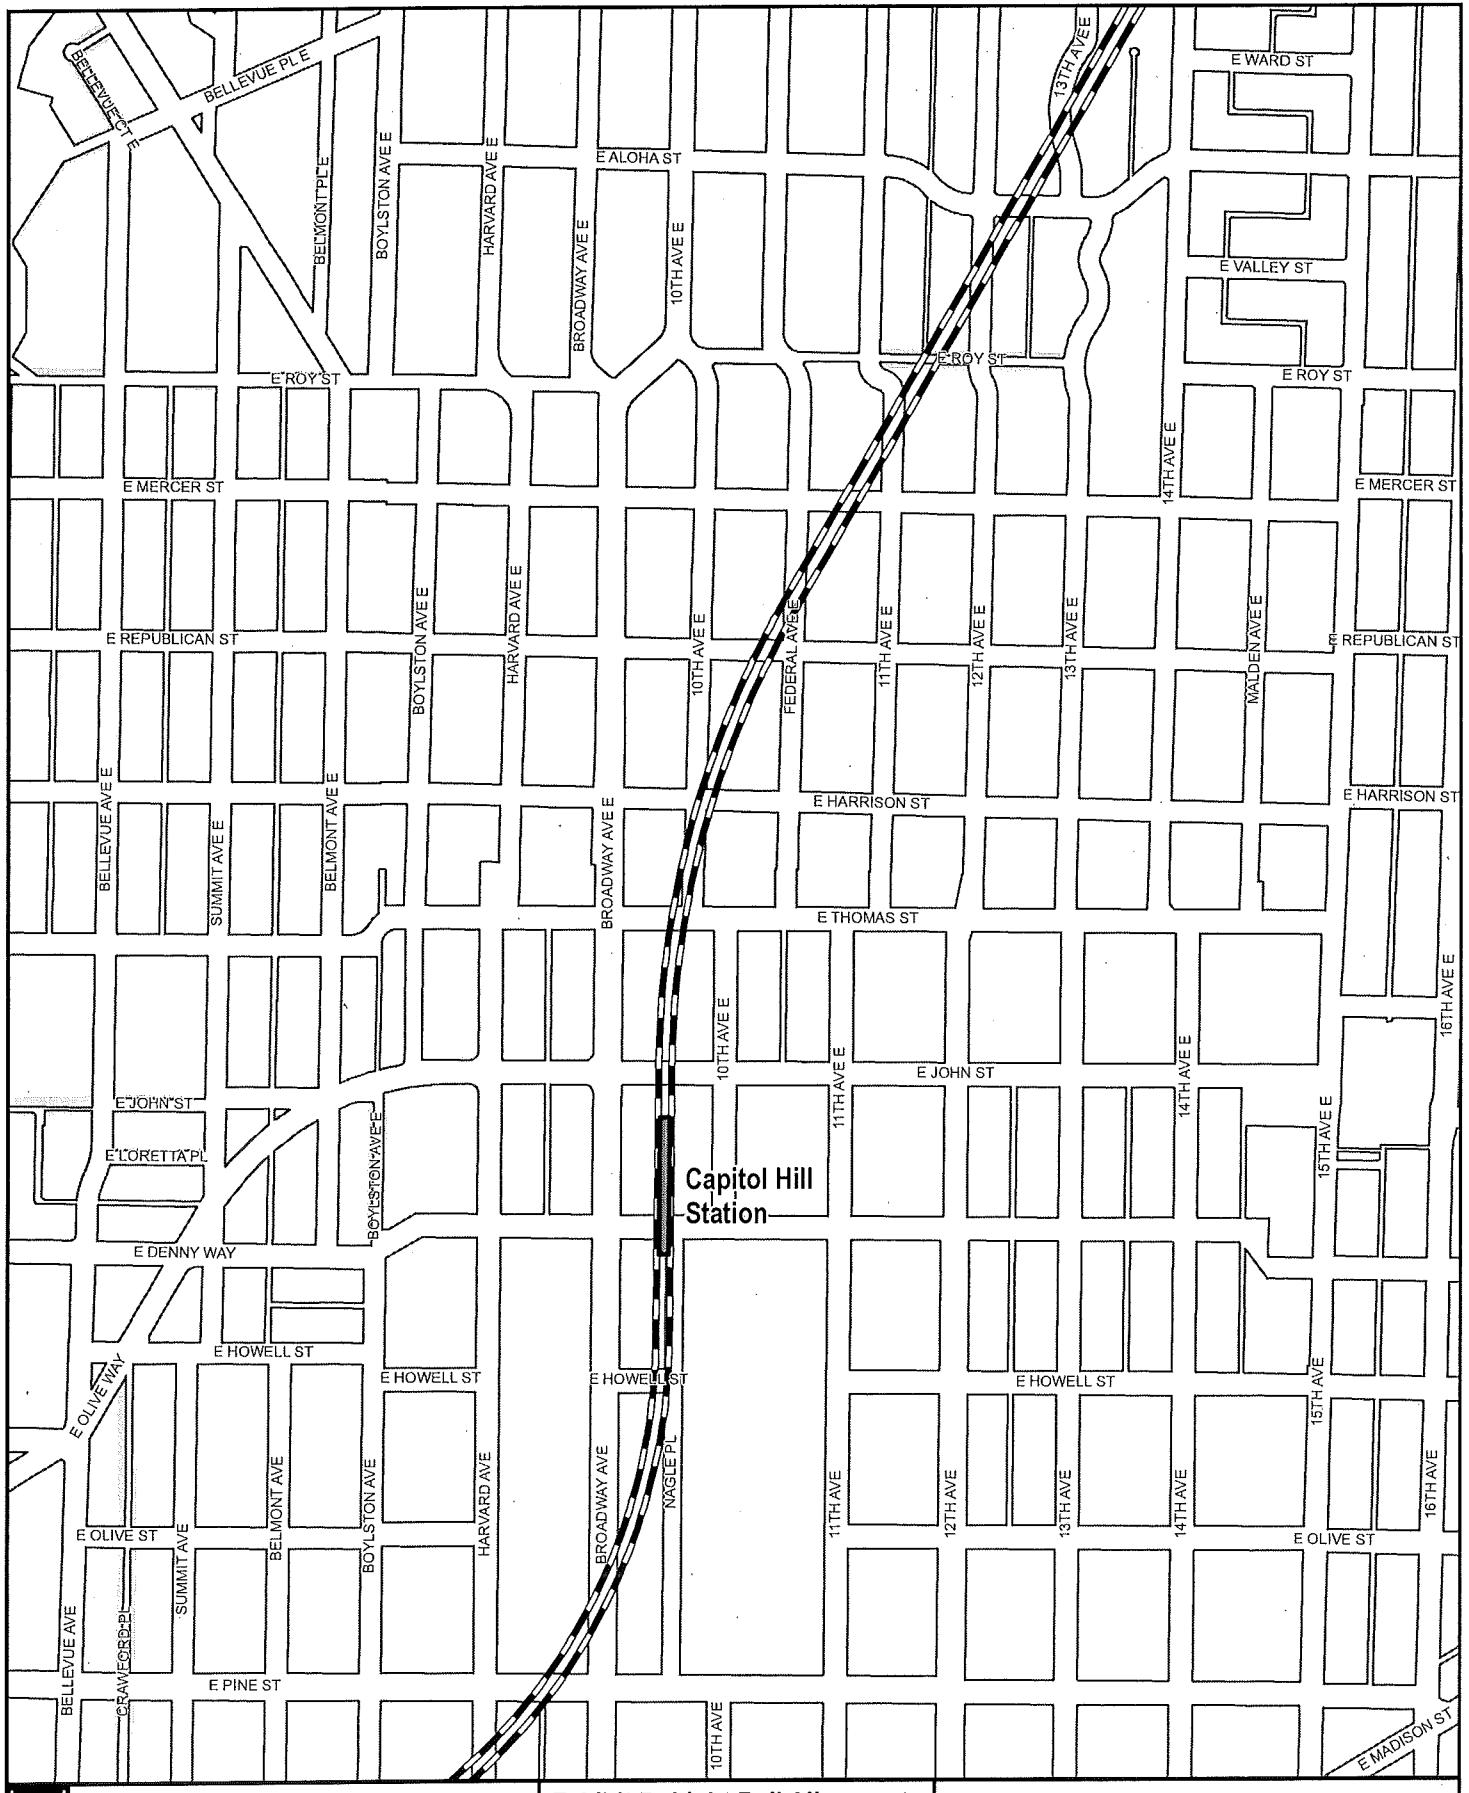LIGHT RAIL ALIGNMENT

- Aerial
- At Grade
- Subway
- Cut and Cover
- Retained Cut / Fill

Light rail station platform

Maintenance facility

Right-of-way

**Exhibit B: Light Rail Alignment,
Station Locations, and
Maintenance Facility Location
Map 7 of 20**

Sound Transit
Project 2012


0 250 500
Feet



Open access King County GIS, City of Seattle Sound Transit GIS
PROJECT 2012 LINK Northgate ROW Site Map 2012

No guarantee of any sort implied, including accuracy, completeness, or fitness for purpose.



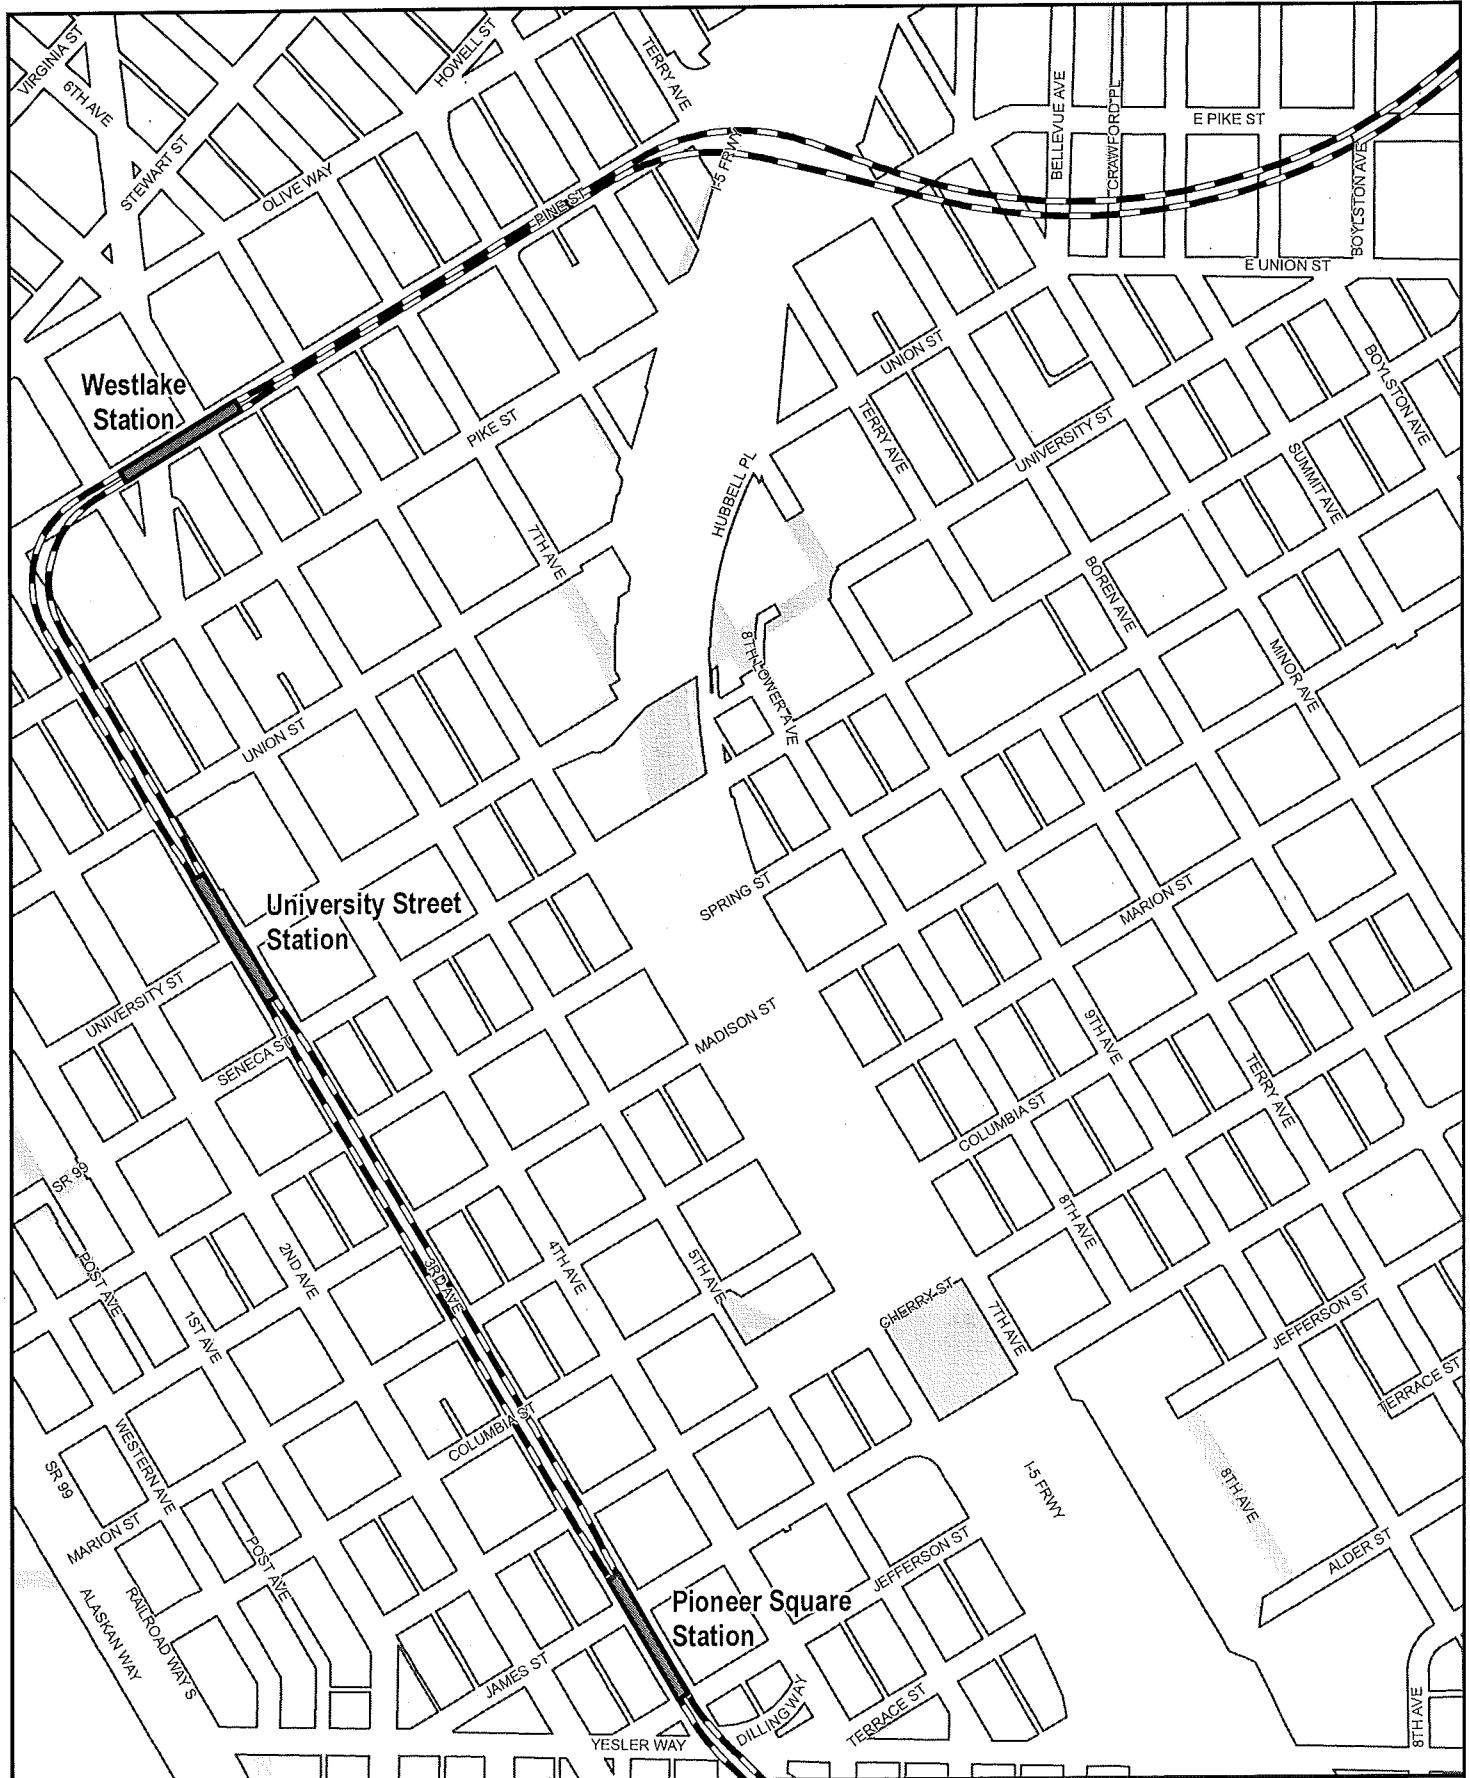

Legend

- LIGHT RAIL ALIGNMENT
 - Aerial
 - At Grade
 - Subway
- Cut and Cover
- Retained Cut / Fill
- Right-of-way

- Light rail station platform
- Maintenance facility
- Right-of-way

**Exhibit B: Light Rail Alignment,
Station Locations, and
Maintenance Facility Location**
Map 8 of 20


SOUNDTRANSIT
October 2012

Disclaimer: King County GIS, City of Seattle, Sound Transit GIS,
PROJECTS 102111-KT-NS-0001-GWE, valid through 8/2012
No guarantee of any content implied, including accuracy, completeness, or fitness for use.

0 250 500
Feet



SEATTLE
CITY
CLERK

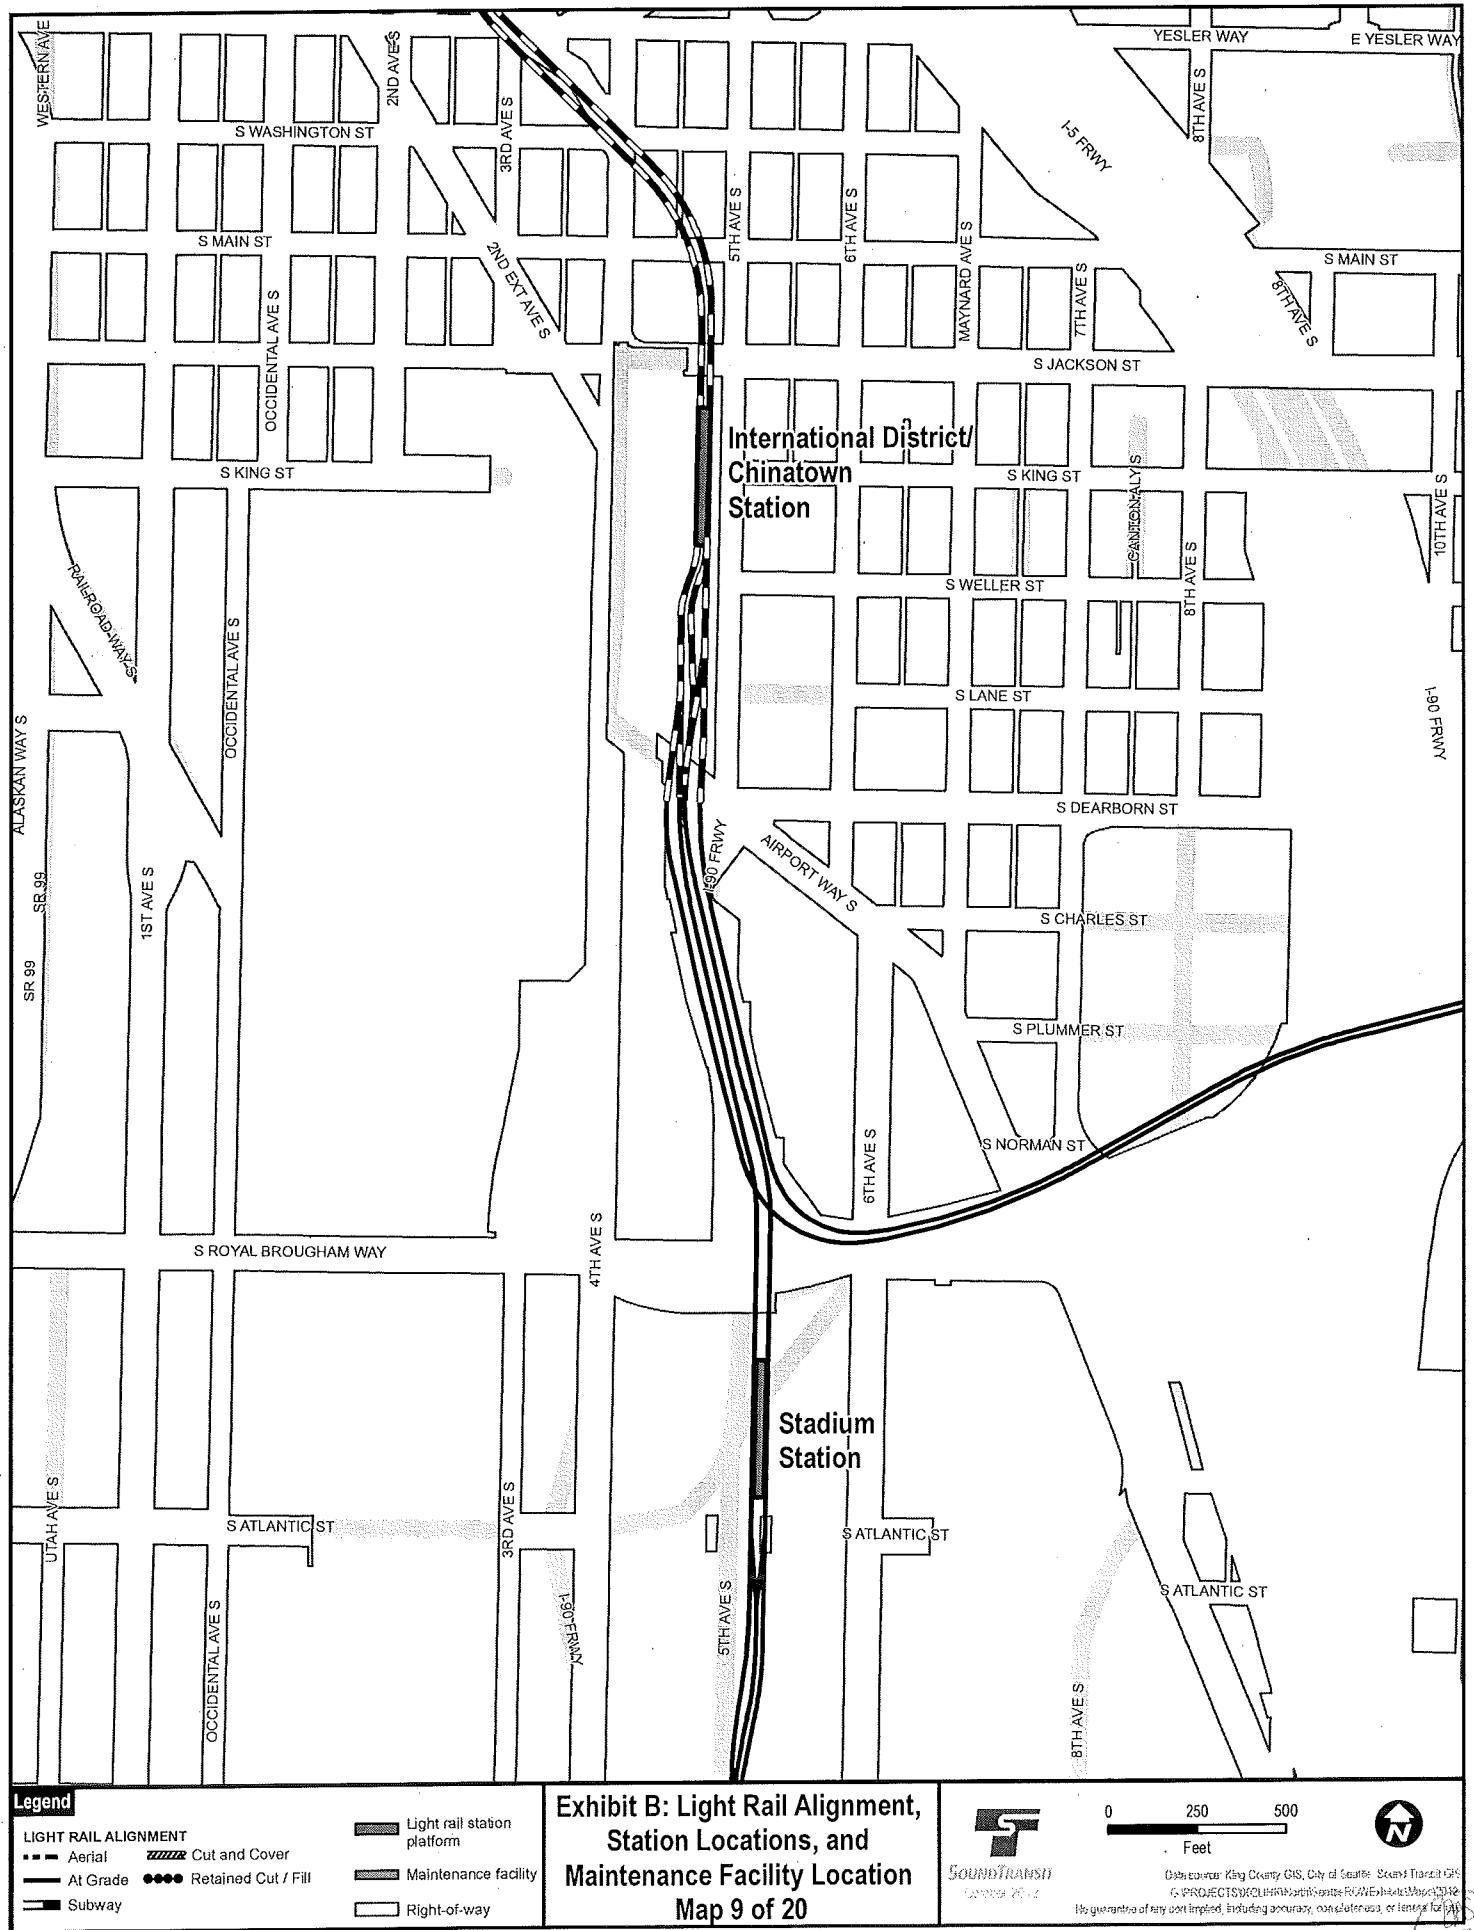

**Exhibit B: Light Rail Alignment,
Station Locations, and
Maintenance Facility Location
Map 9 of 20**


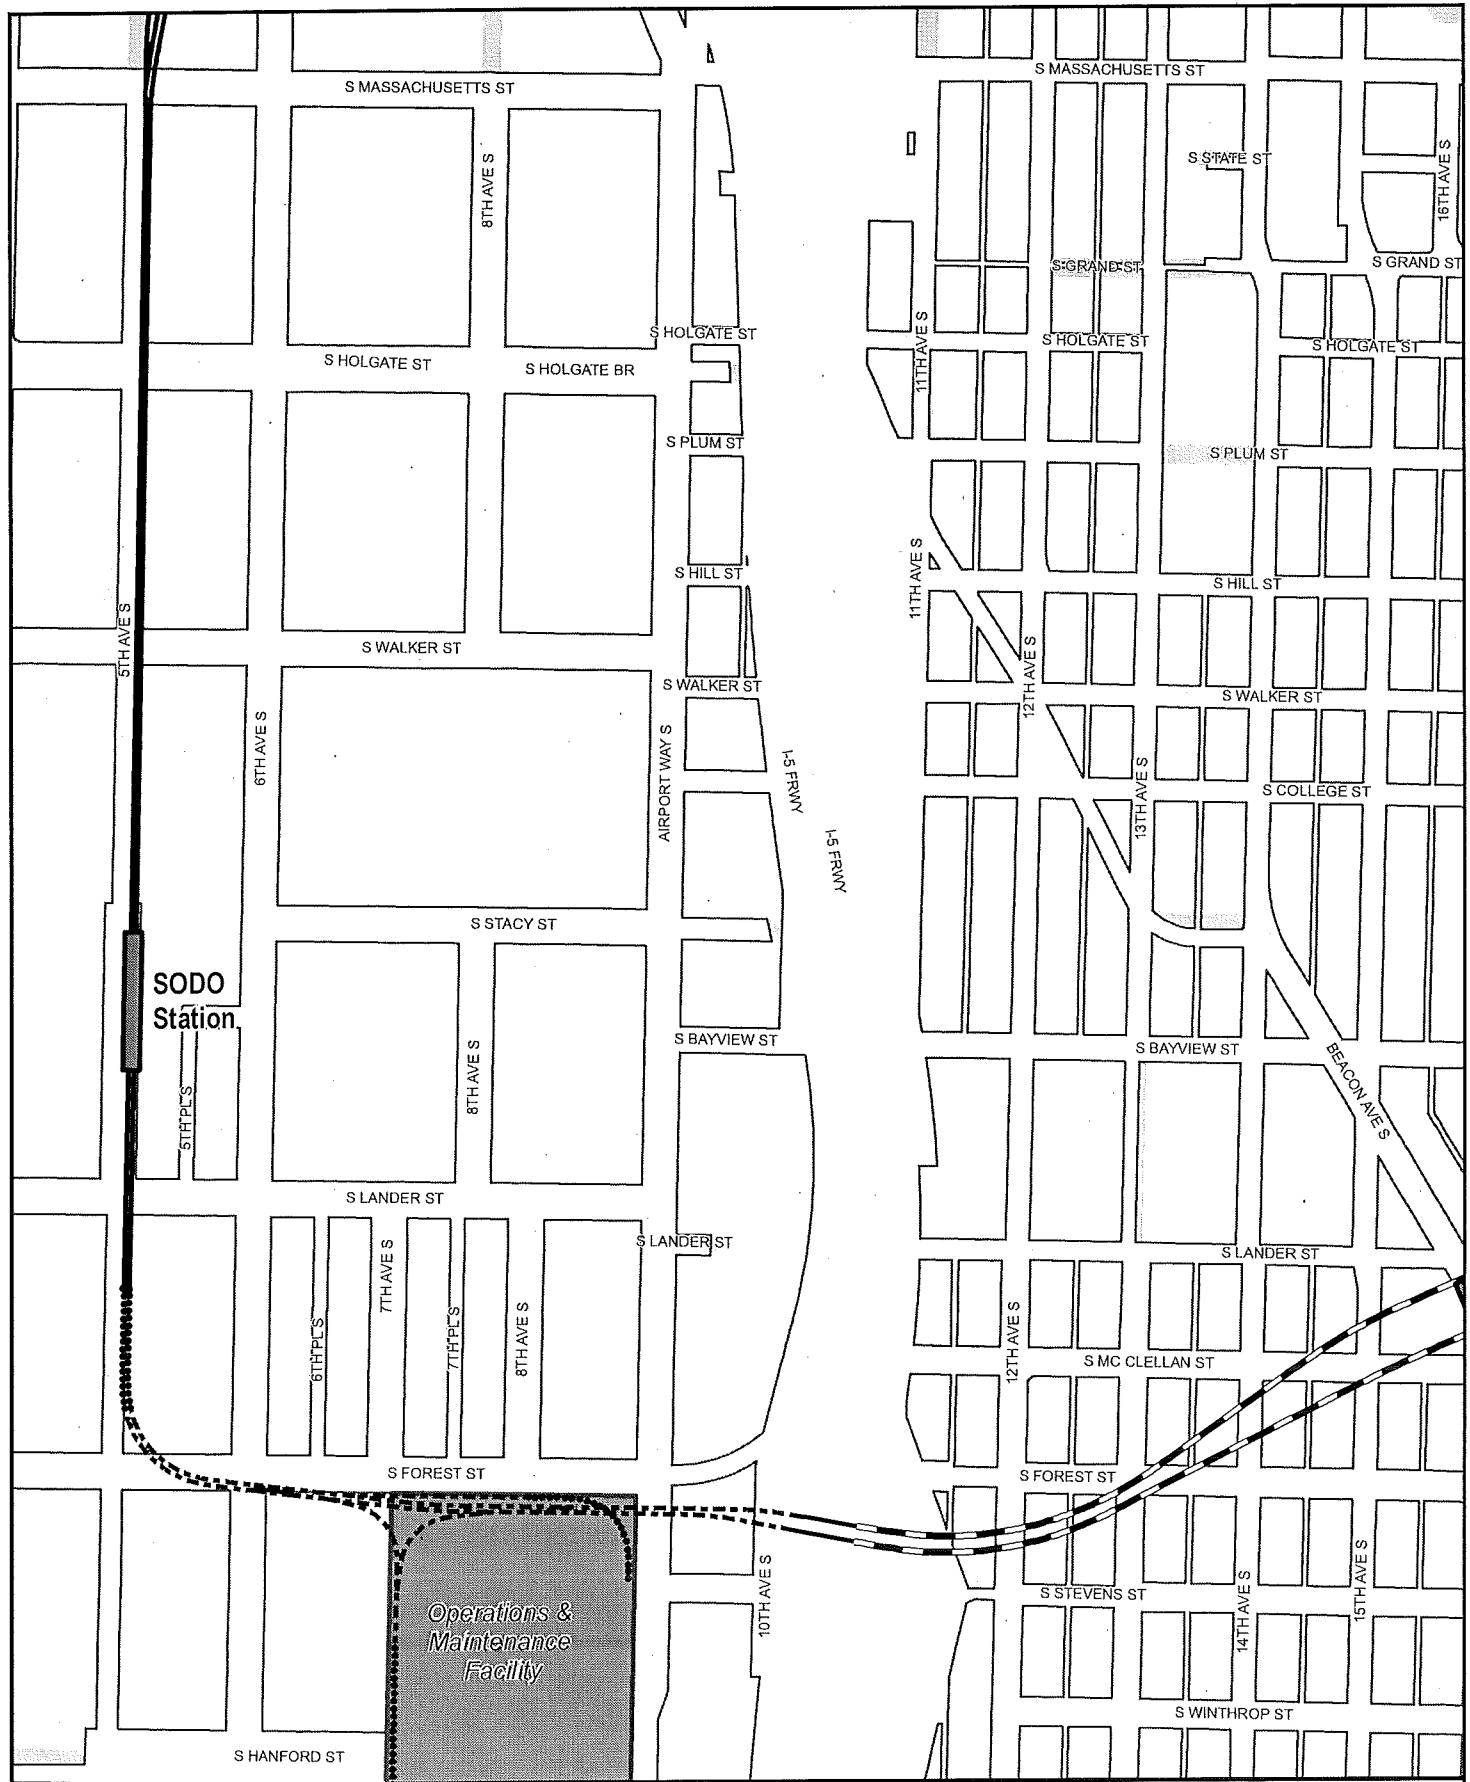


Exhibit B: Light Rail Alignment, Station Locations, and Maintenance Facility Location
Map 10 of 20

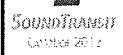

SOUND TRANSIT
CARTOGRAPHY 2012

0 250 500
Feet
 N
Source: King County GIS, City of Seattle Sound Transit GIS
PROJECTS\021\Infrastructure\Final\Ward\Map2012
No guarantee of any sort implied, including accuracy, completeness, or fitness for purpose.




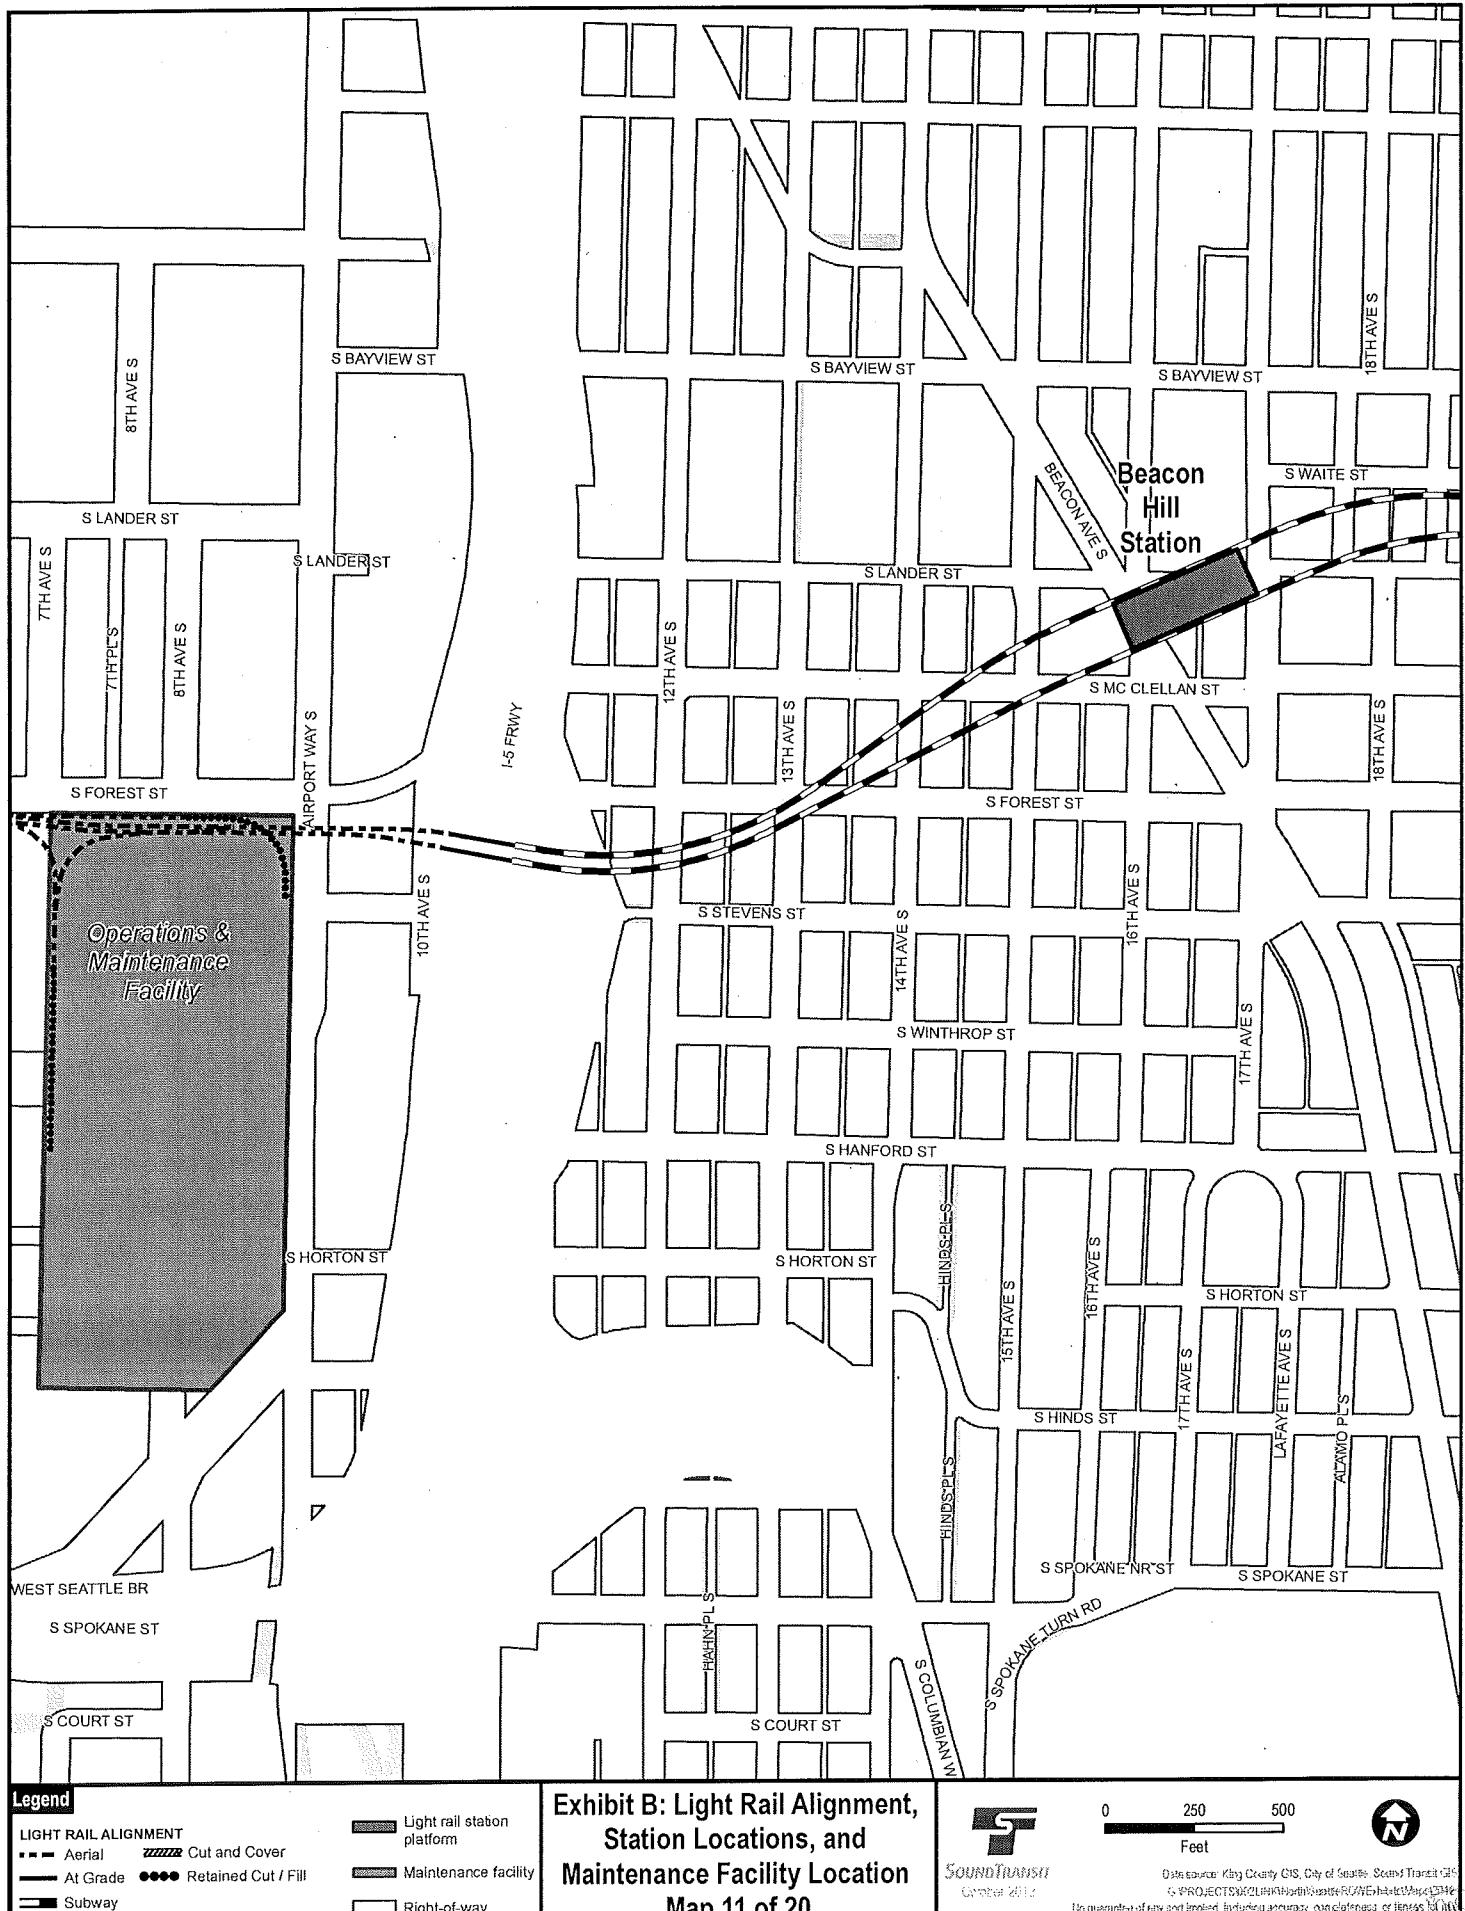


Exhibit B: Light Rail Alignment, Station Locations, and Maintenance Facility Location Map 11 of 20

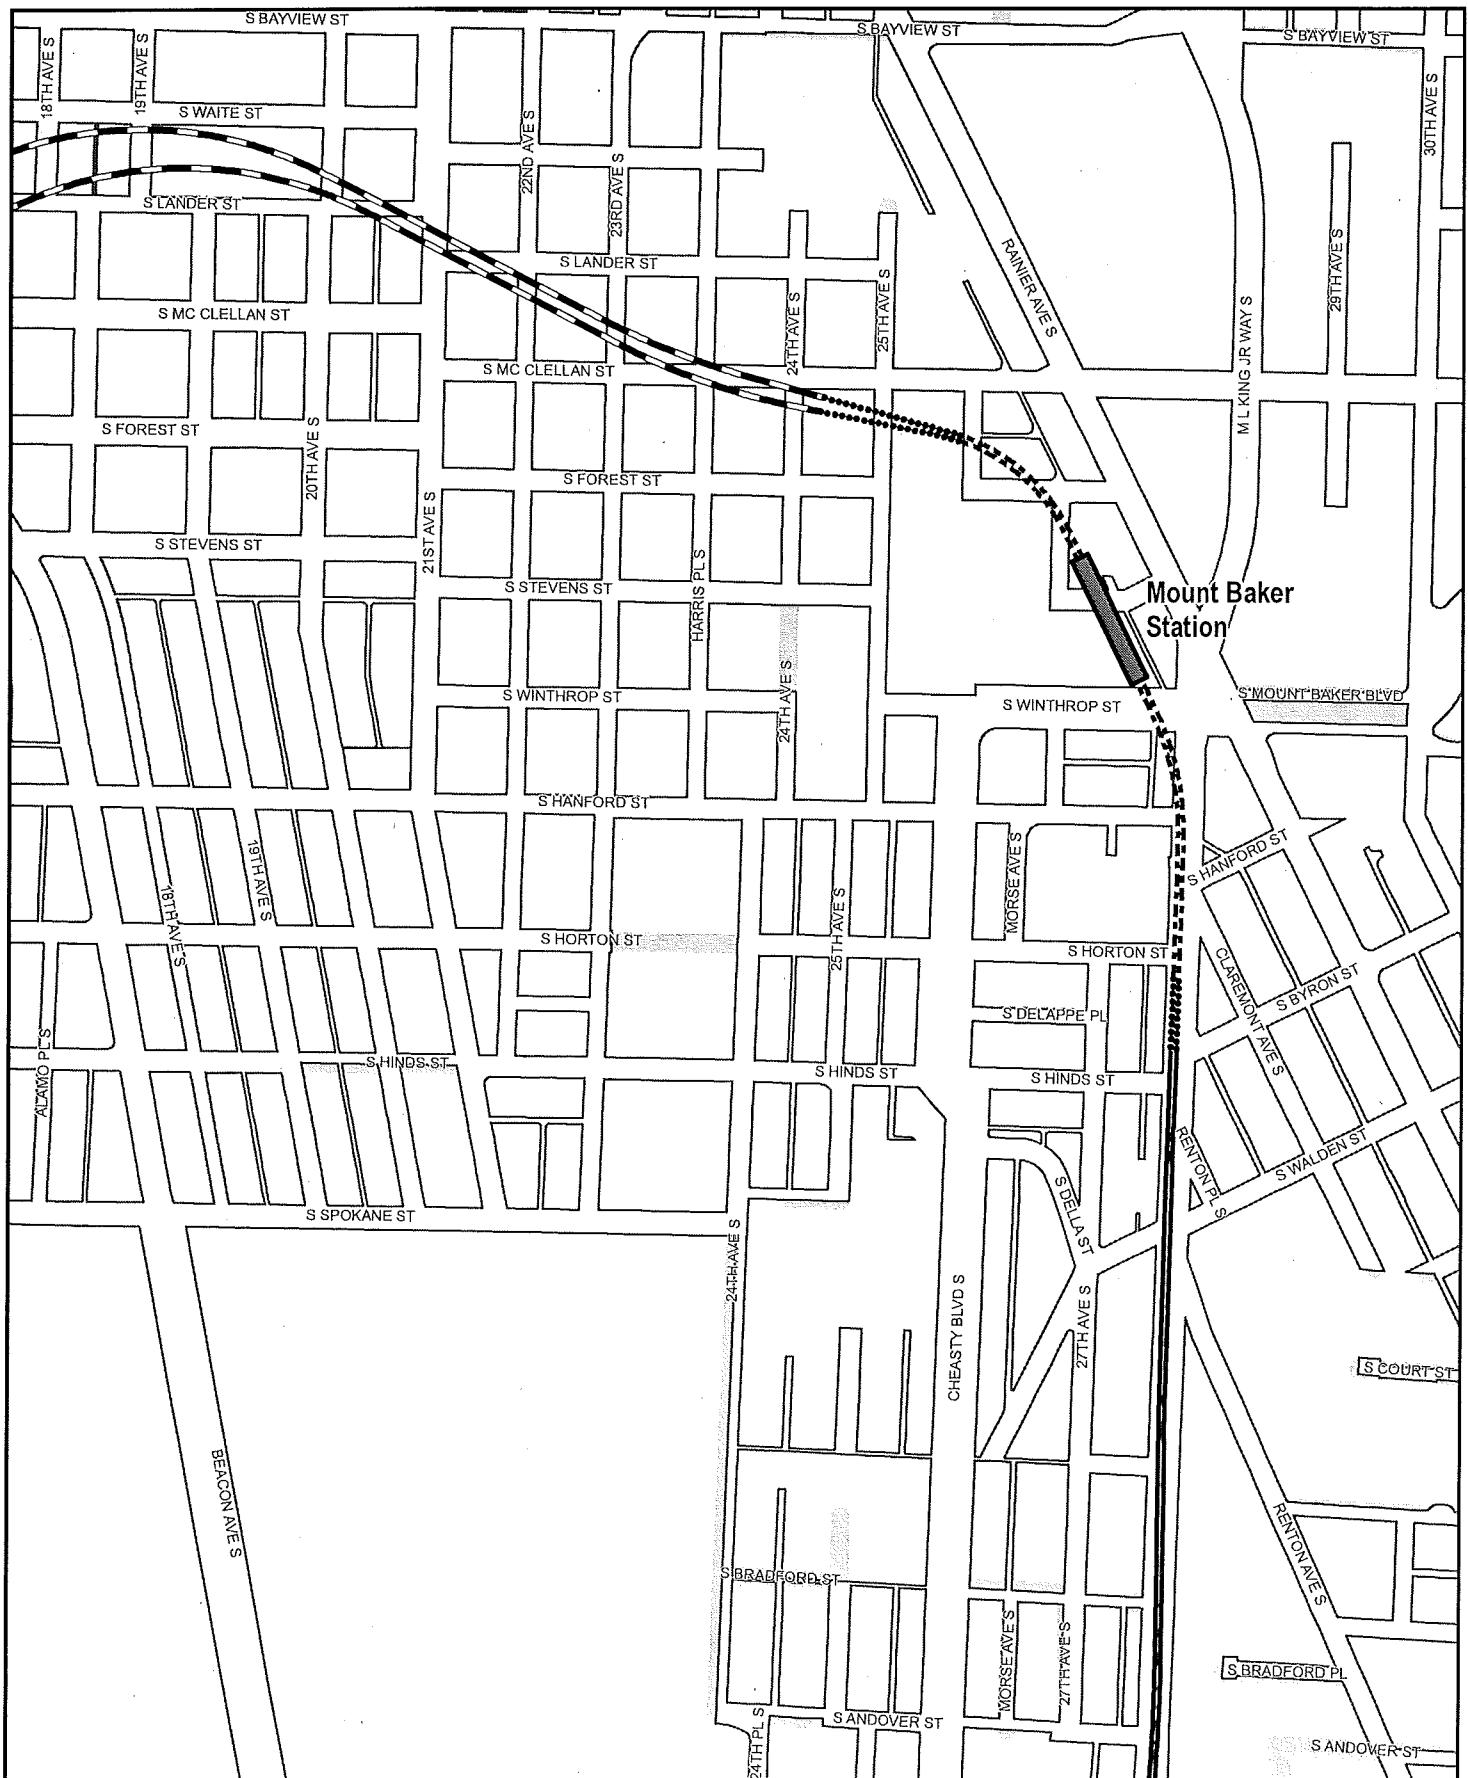

Legend

- LIGHT RAIL ALIGNMENT**
- Aerial
- At Grade
- Subway
- Cut and Cover
- Retained Cut / Fill

- Light rail station platform
- Maintenance facility
- Right-of-way

**Exhibit B: Light Rail Alignment,
Station Locations, and
Maintenance Facility Location
Map 12 of 20**

SOUNDTRANSIT
October 2012


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Data source: King County GIS, City of Seattle Sound Transit GIS
PROJECTS & LOCATIONS BOUNDARY RELEASE DATE MAY 2012

No guarantee of any sort implied, including accuracy, completeness, or fitness for use.





Legend

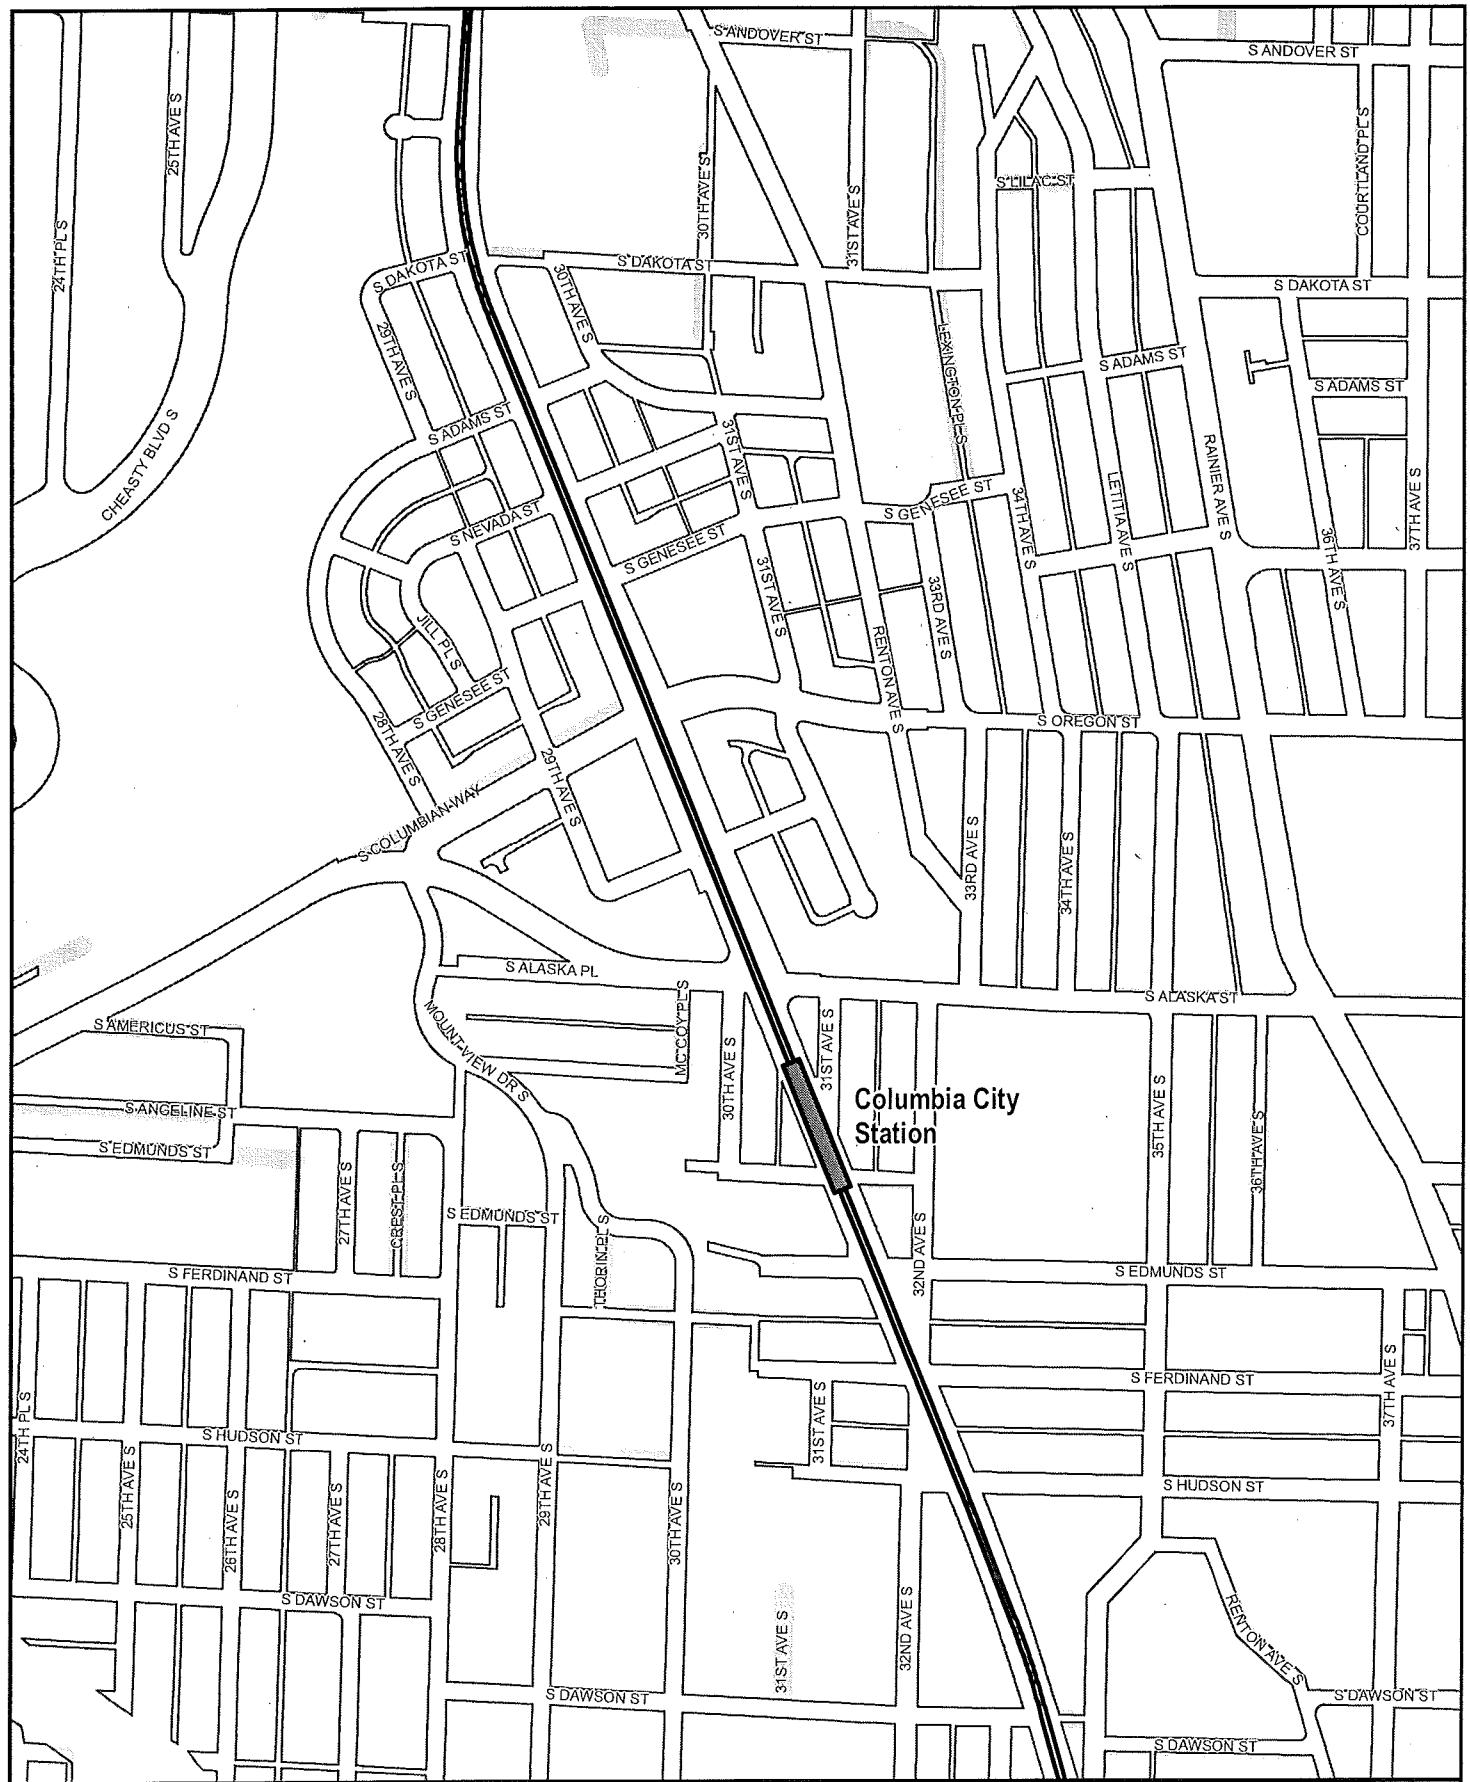- LIGHT RAIL ALIGNMENT**
- Aerial
- At Grade
- Subway
- Cut and Cover
- Retained Cut / Fill

- Light rail station platform
- Maintenance facility
- Right-of-way

Exhibit B: Light Rail Alignment, Station Locations, and Maintenance Facility Location Map 13 of 20


SOUNDTRANSIT
LAMPAGE 20-12

0 250 500
Feet



Data source: King County GIS, City of Seattle, Sound Transit GIS
G PROJECTS\2011\LightRail\Seattle\RAV\Initial\Map13\2012
No guarantee of accuracy implied, including accuracy, completeness, or fitness for use.

CITY CLERK

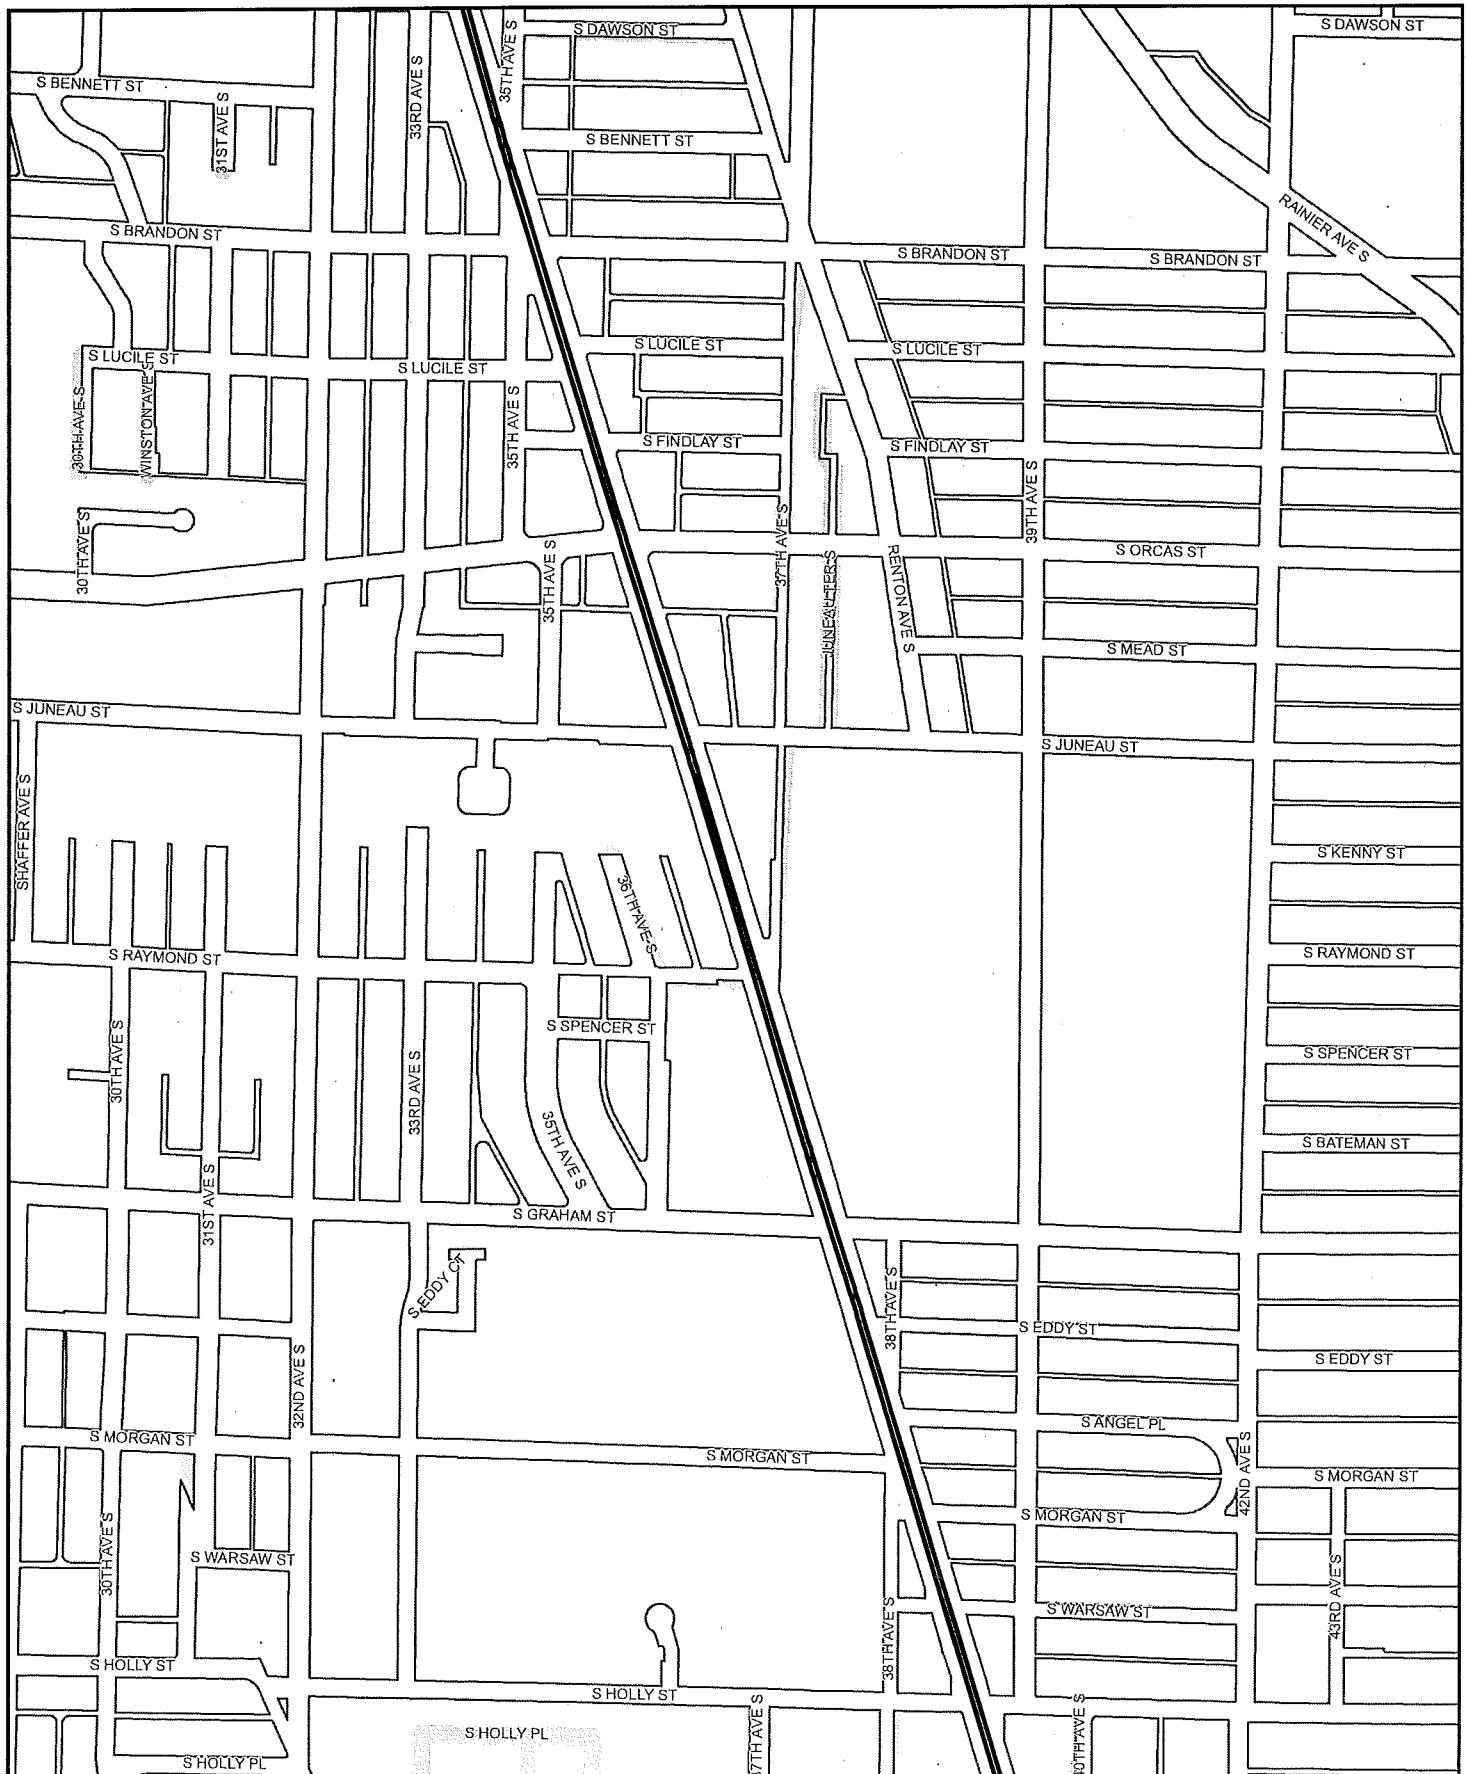

Legend

- LIGHT RAIL ALIGNMENT**
 - Aerial
 - Cut and Cover
 - At Grade
 - Retained Cut / Fill
 - Subway

- Light rail station platform
- Maintenance facility
- Right-of-way

Exhibit B: Light Rail Alignment, Station Locations, and Maintenance Facility Location
Map 14 of 20

SOUNDTRANSIT
October 2012


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Data source: King County GIS, City of Seattle, Sound Transit GIS
PROJECTS/2011/Interim/SeattleForAll/InitialMaps2012

No guarantee of any sort implied, including accuracy, completeness, or fitness for any purpose.

City Clerk



**Exhibit B: Light Rail Alignment,
Station Locations, and
Maintenance Facility Location
Map 15 of 20**

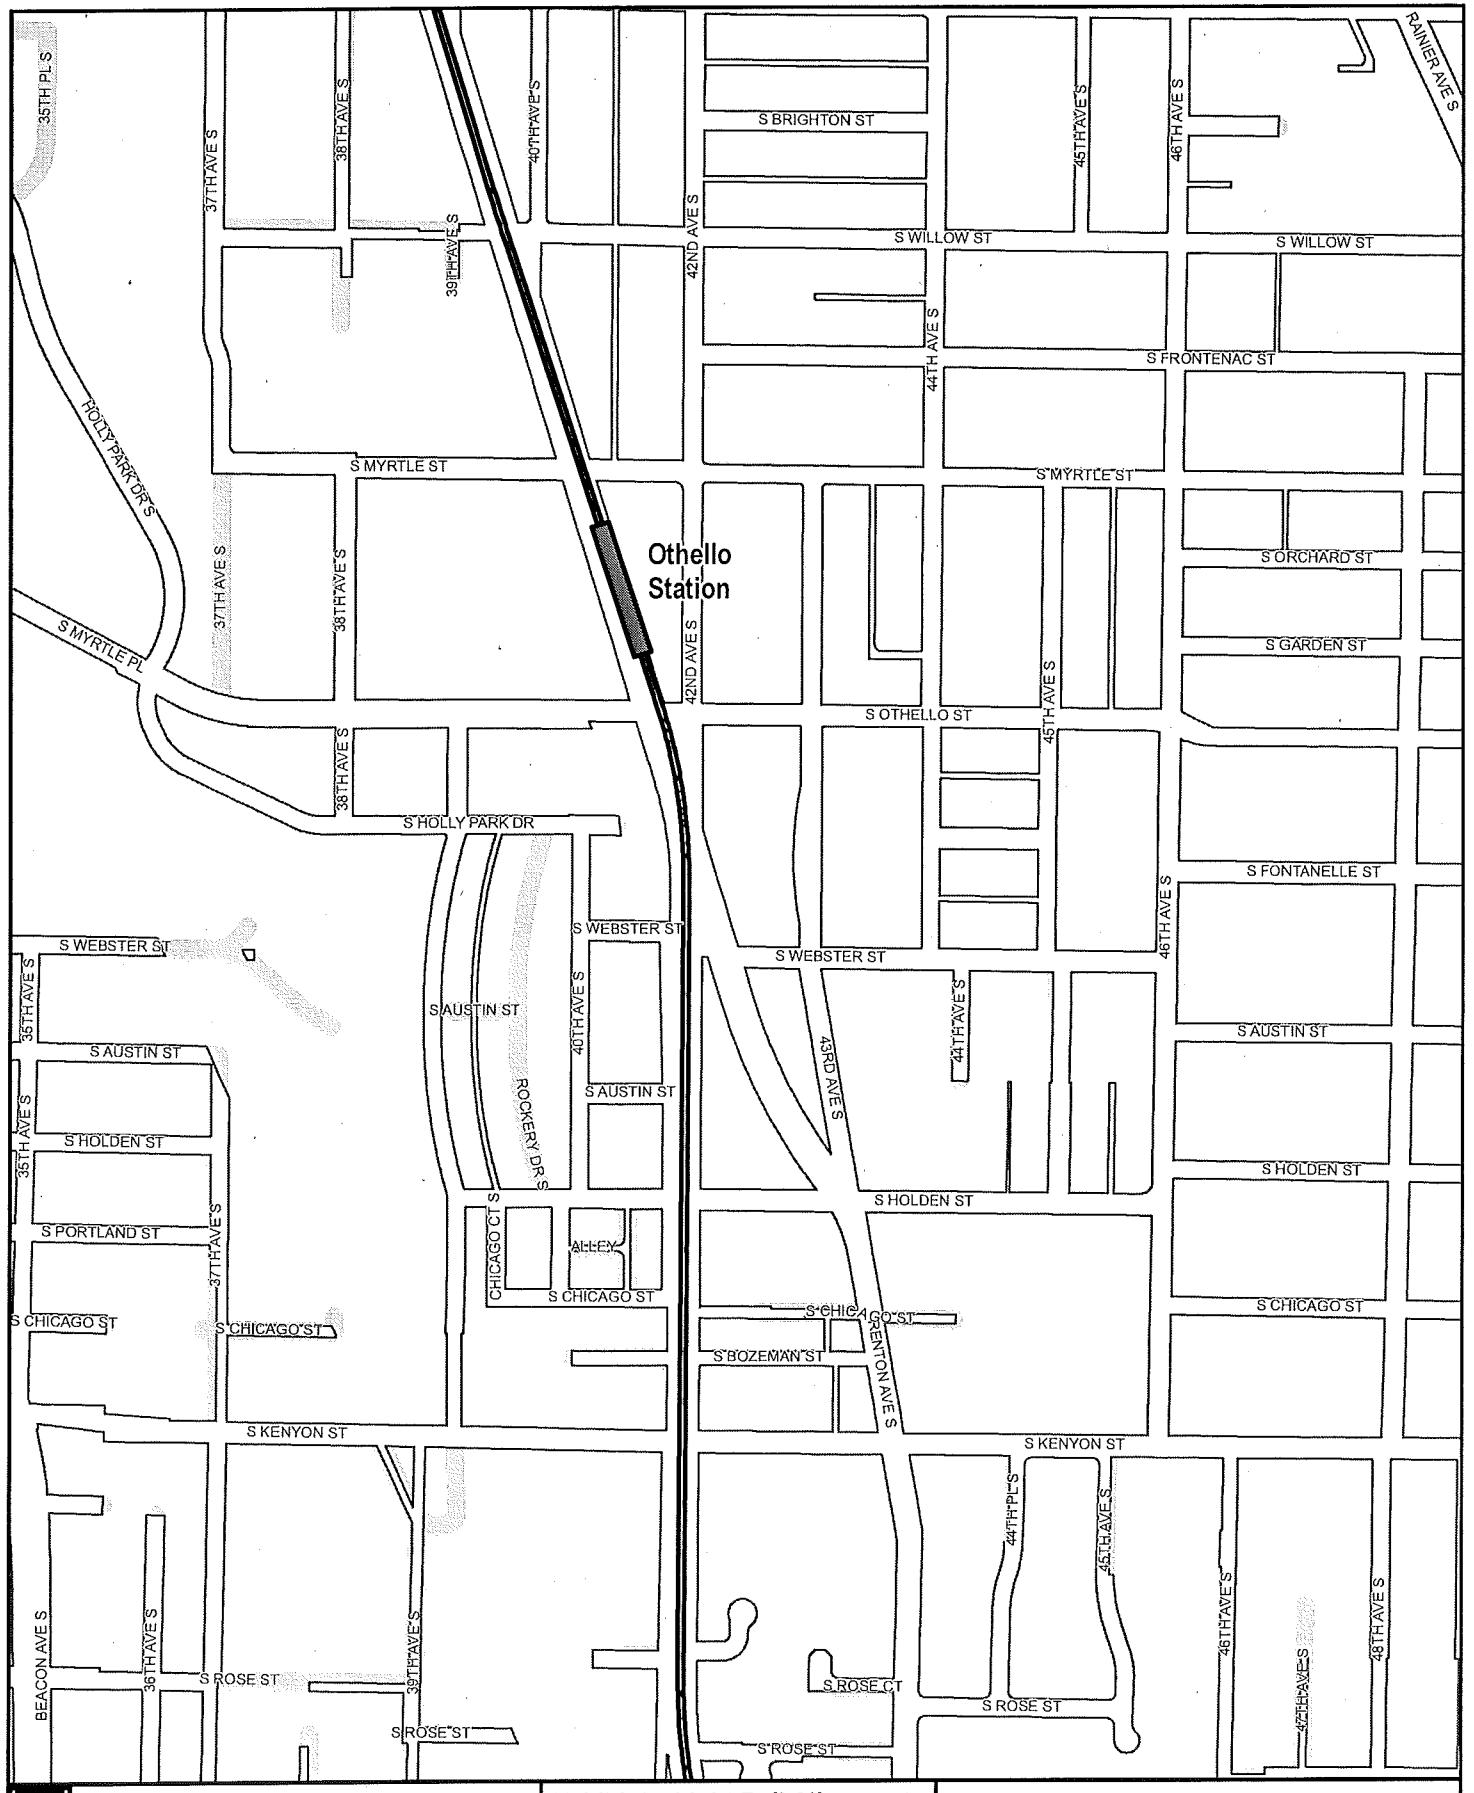


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Feet

Legend

- LIGHT RAIL ALIGNMENT**

 - Aerial
 - At Grade
 - Subway
 - Cut and Cover
 - Retained Cut / Fill
 - Maintenance facility
 - Right-of-way

Data source: King County GIS, City of Seattle, Sound Transit GIS
G:\PROJECTS\2011\Housing\NorthWest\PT\WA\Seattle\Waypoint\2012
may contain implied, including accuracy, completeness, or fitness for use.

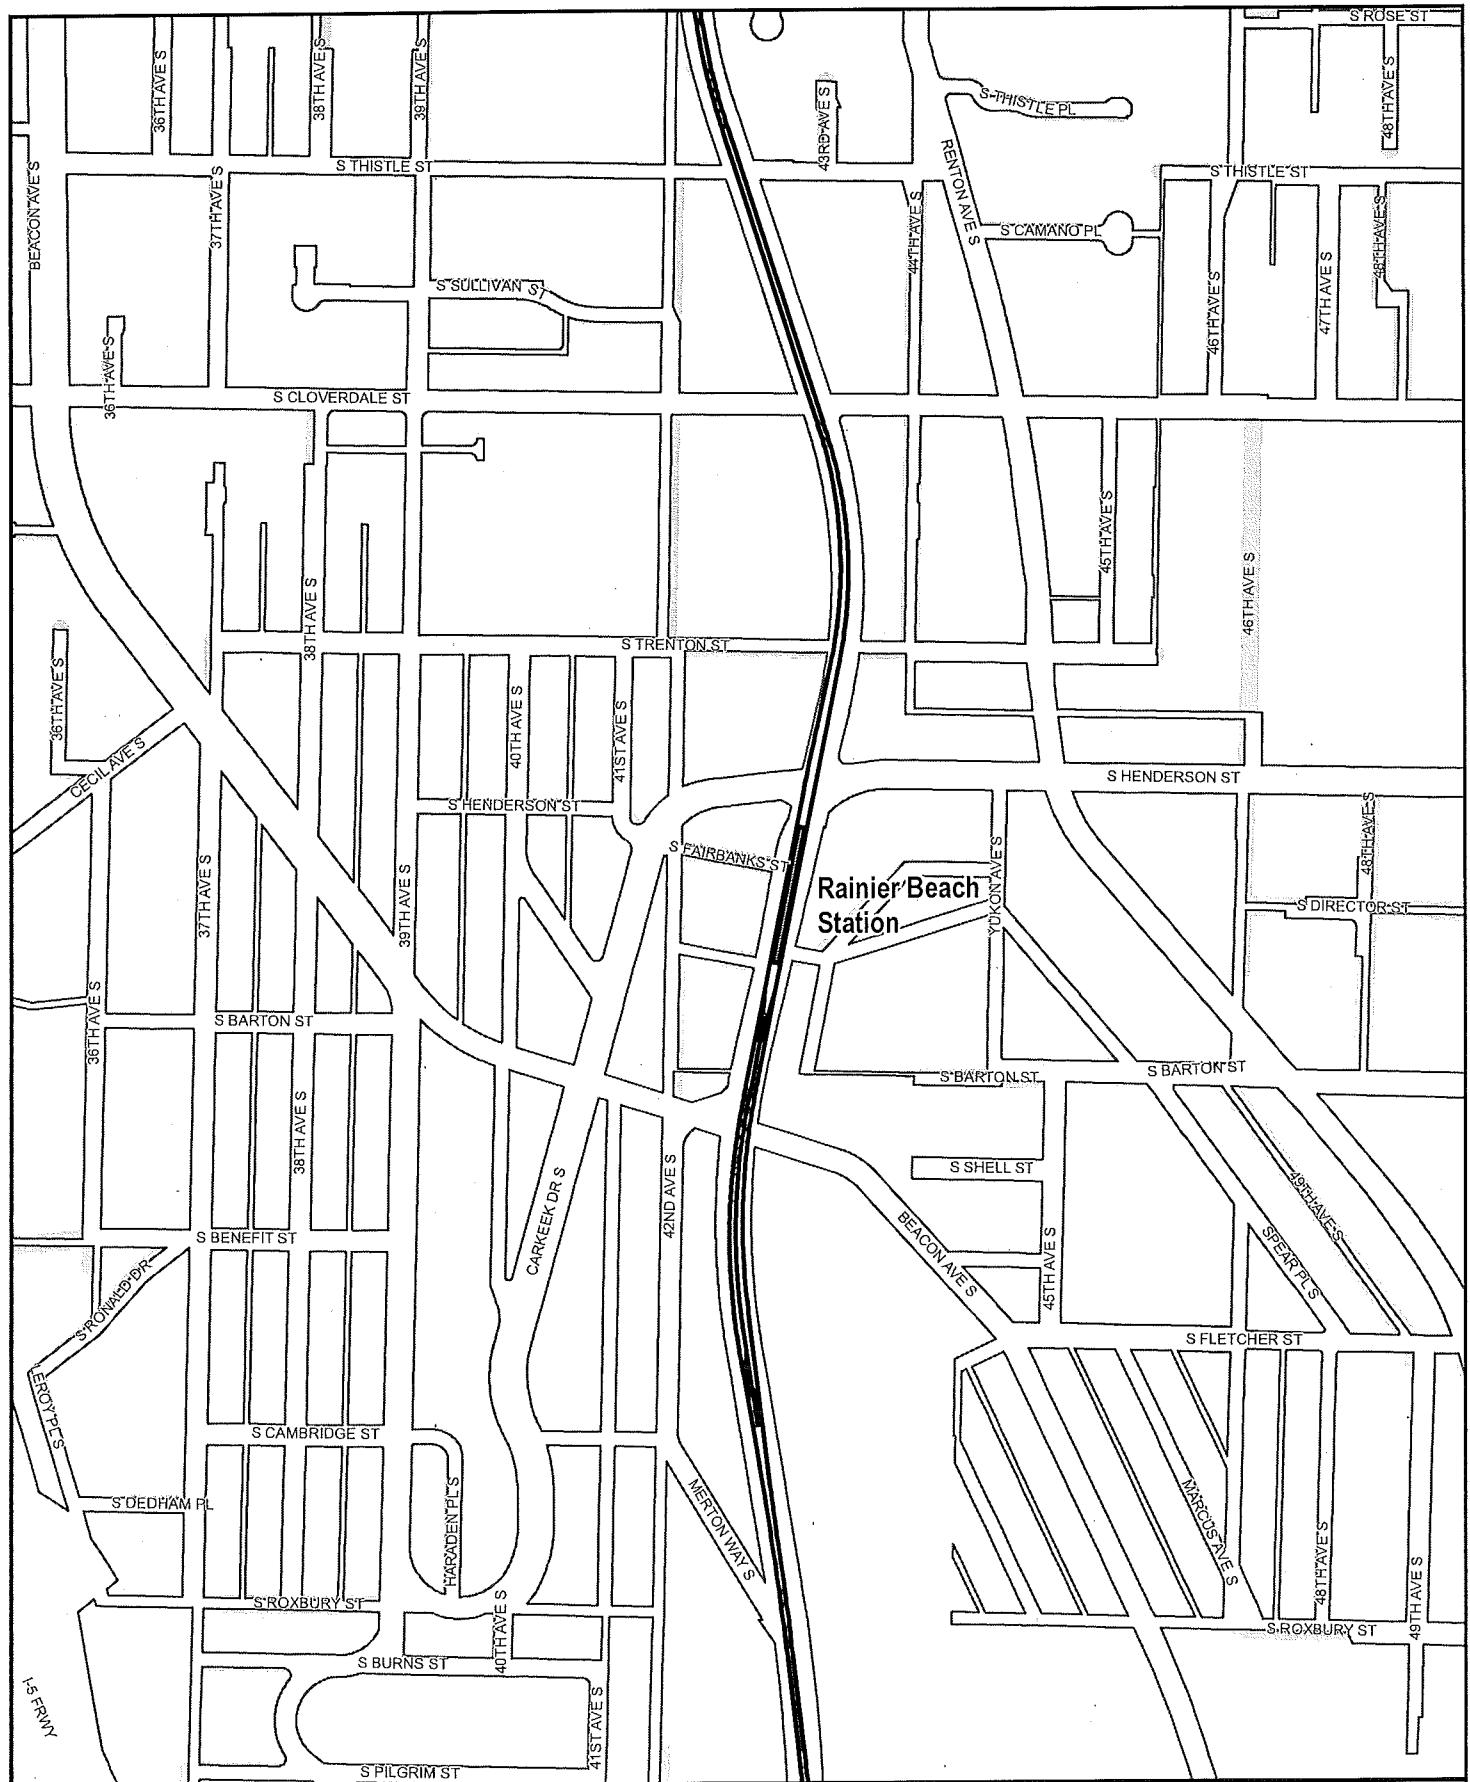

Legend

- LIGHT RAIL ALIGNMENT**
 - Aerial
 - Cut and Cover
 - At Grade
 - Retained Cut / Fill
 - Subway

- Light rail station platform
- Maintenance facility
- Right-of-way


**Exhibit B: Light Rail Alignment,
Station Locations, and
Maintenance Facility Location**
Map 16 of 20


0 250 500
Feet



SOUND TRANSIT
Central Area

Source: King County GIS, City of Seattle Sound Transit
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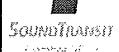


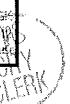Legend

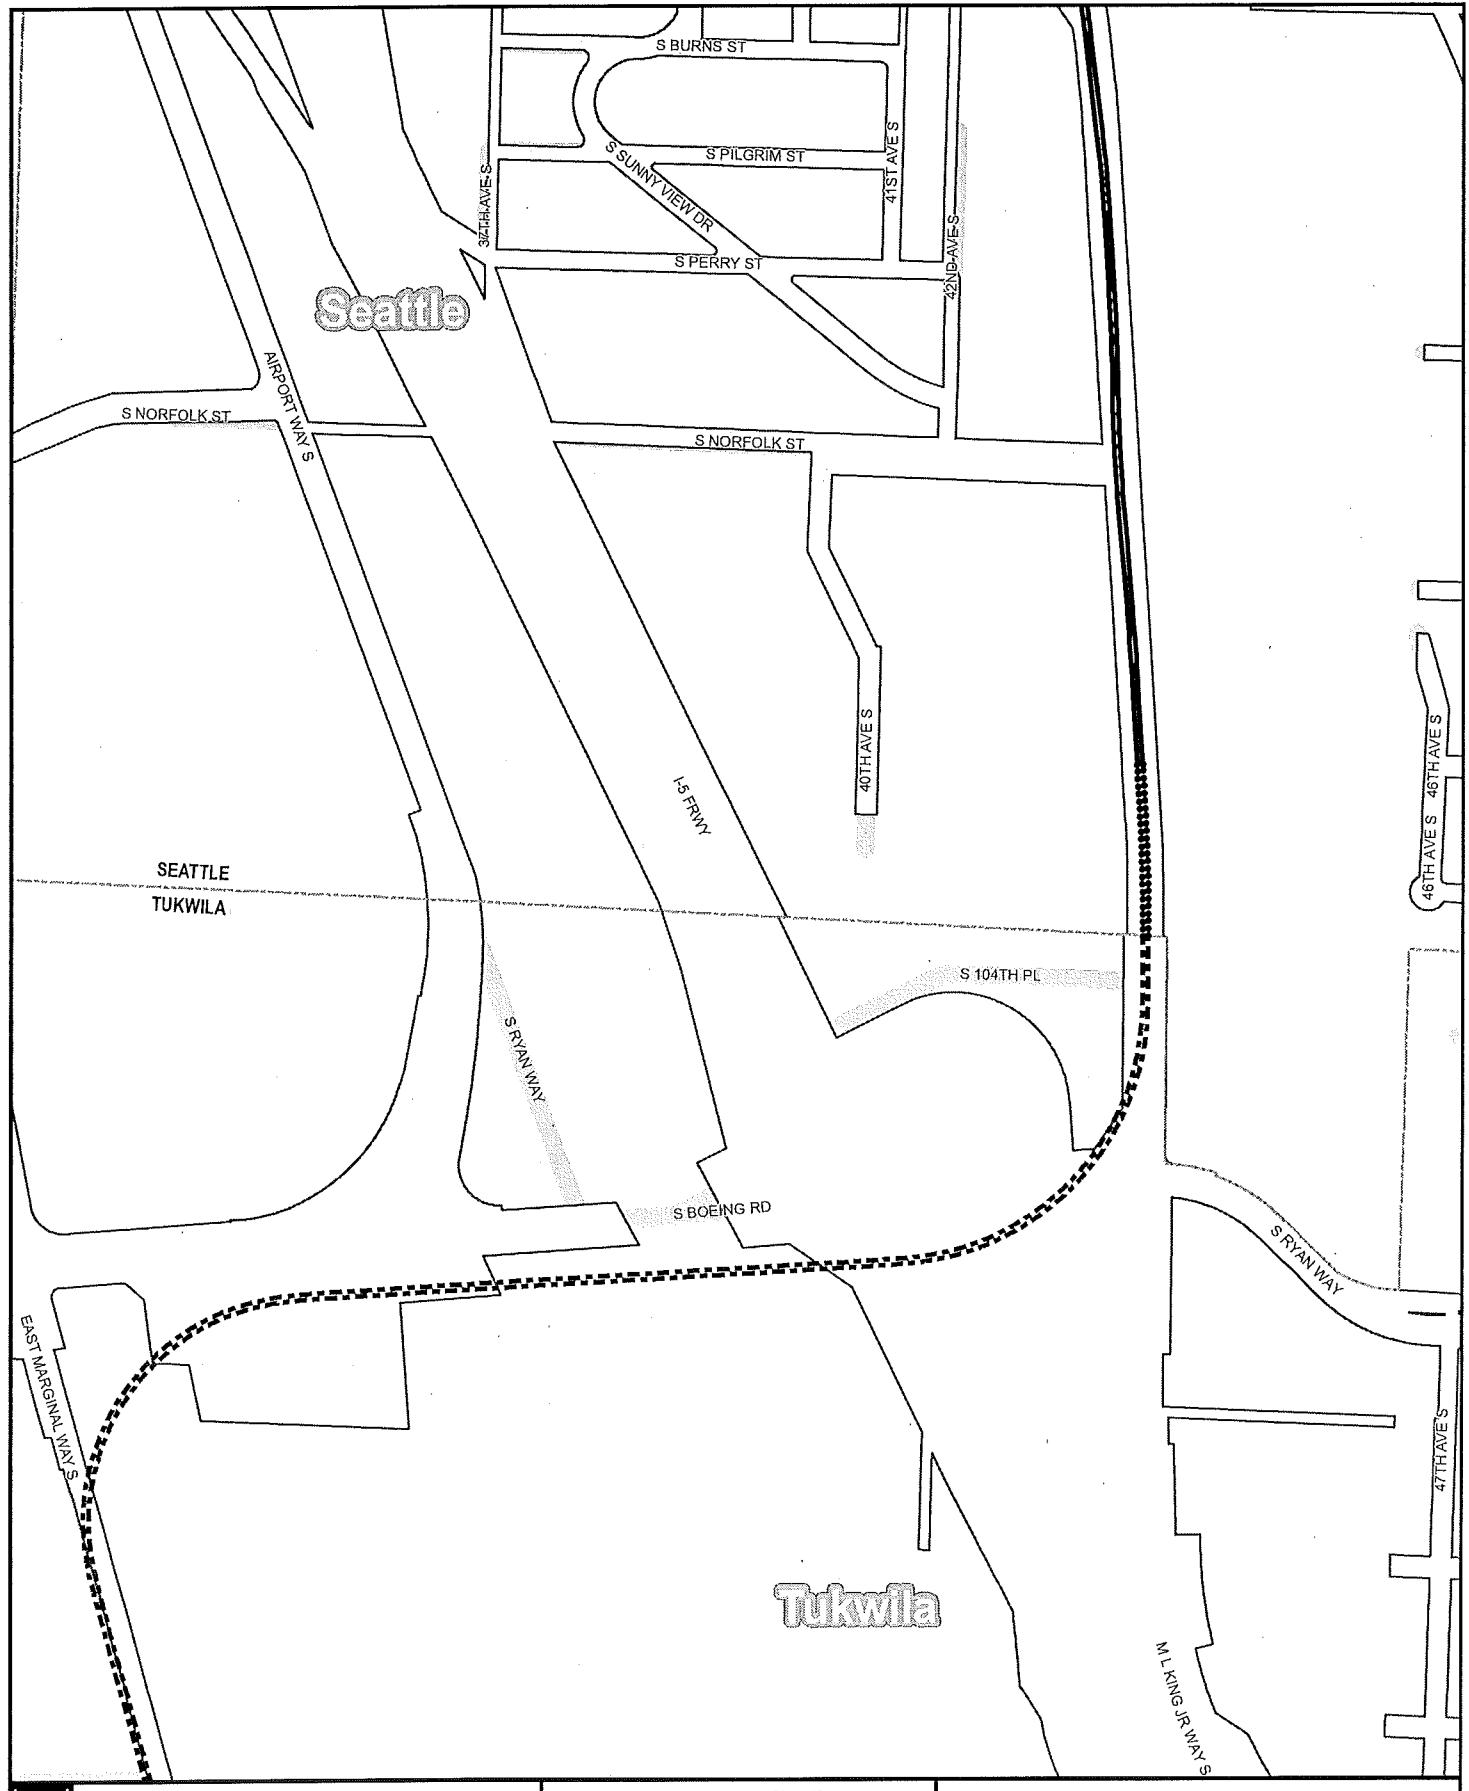- LIGHT RAIL ALIGNMENT**
- Aerial
- At Grade
- Subway
- Cut and Cover
- Retained Cut / Fill

- Light rail station platform
- Maintenance facility
- Right-of-way

**Exhibit B: Light Rail Alignment,
Station Locations, and
Maintenance Facility Location**
Map 17 of 20




SOUND TRANSIT
CARRIER NO. 1

0 250 500
Feet



Data source: King County GIS, City of Seattle, Sound Transit. © PROJECT 302 LIGHT RAIL STATION PLACEMENTS - MAY 2012
No guarantee of any sort implied, including accuracy, completeness, or fitness for use.



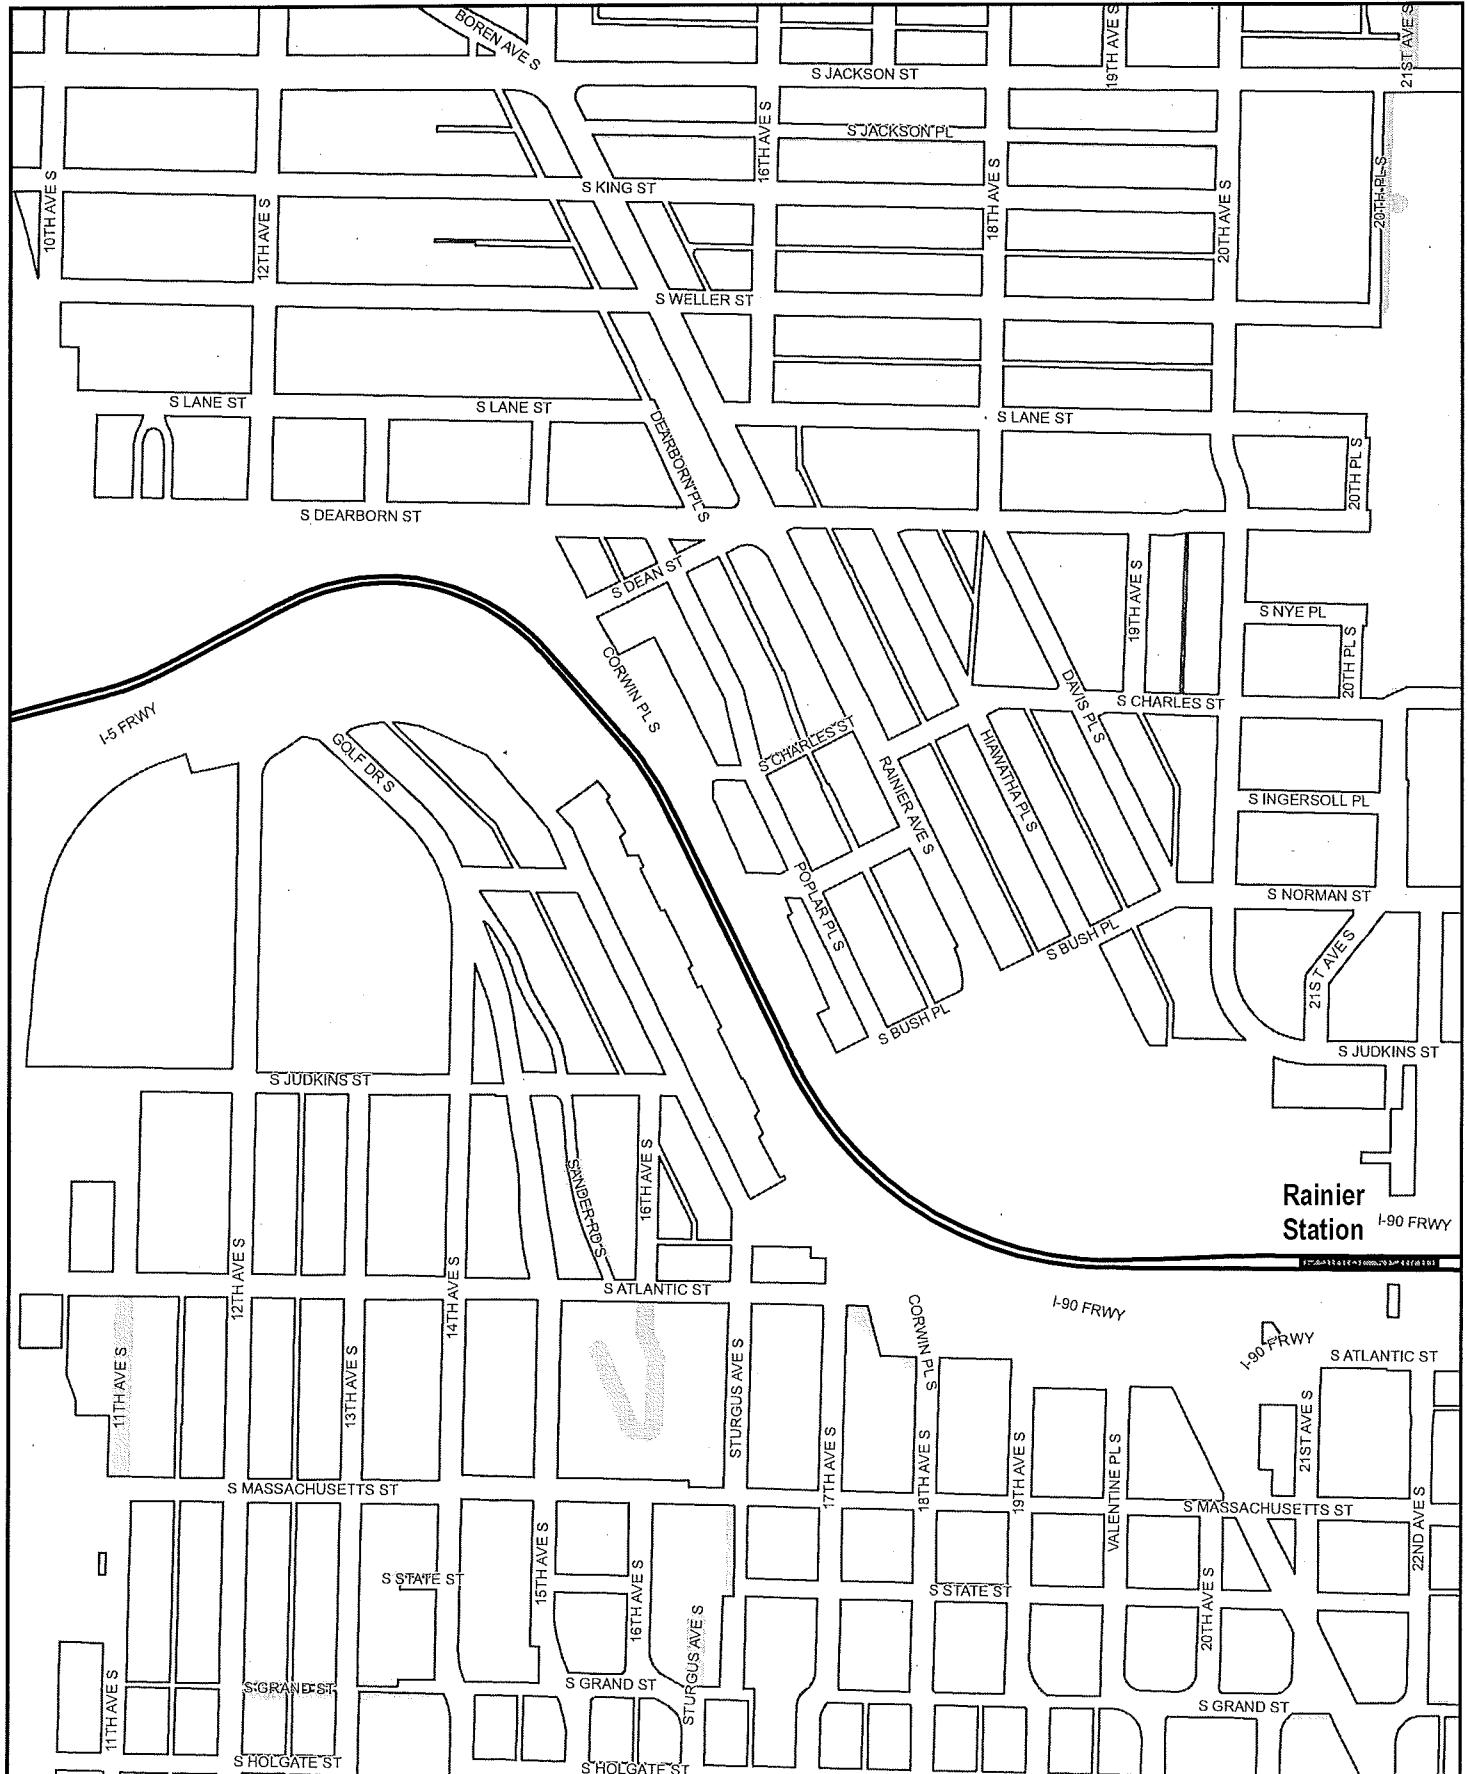

Legend

LIGHT RAIL ALIGNMENT	
— Aerial	===== Cut and Cover
— At Grade	●●● Retained Cut / Fill
— Subway	

Light rail station platform	
Maintenance facility	
Right-of-way	

Exhibit B: Light Rail Alignment, Station Locations, and Maintenance Facility Location Map 18 of 20



SOUND TRANSIT
Summer 2012



0 250 500
Feet



Source: King County GIS, City of Seattle Sound Transit GIS
© PROJECTS VOLUNTARY TRANSIT AUTHORITY 2012

No guarantee of any sort implied, including accuracy, completeness, or fitness for use.



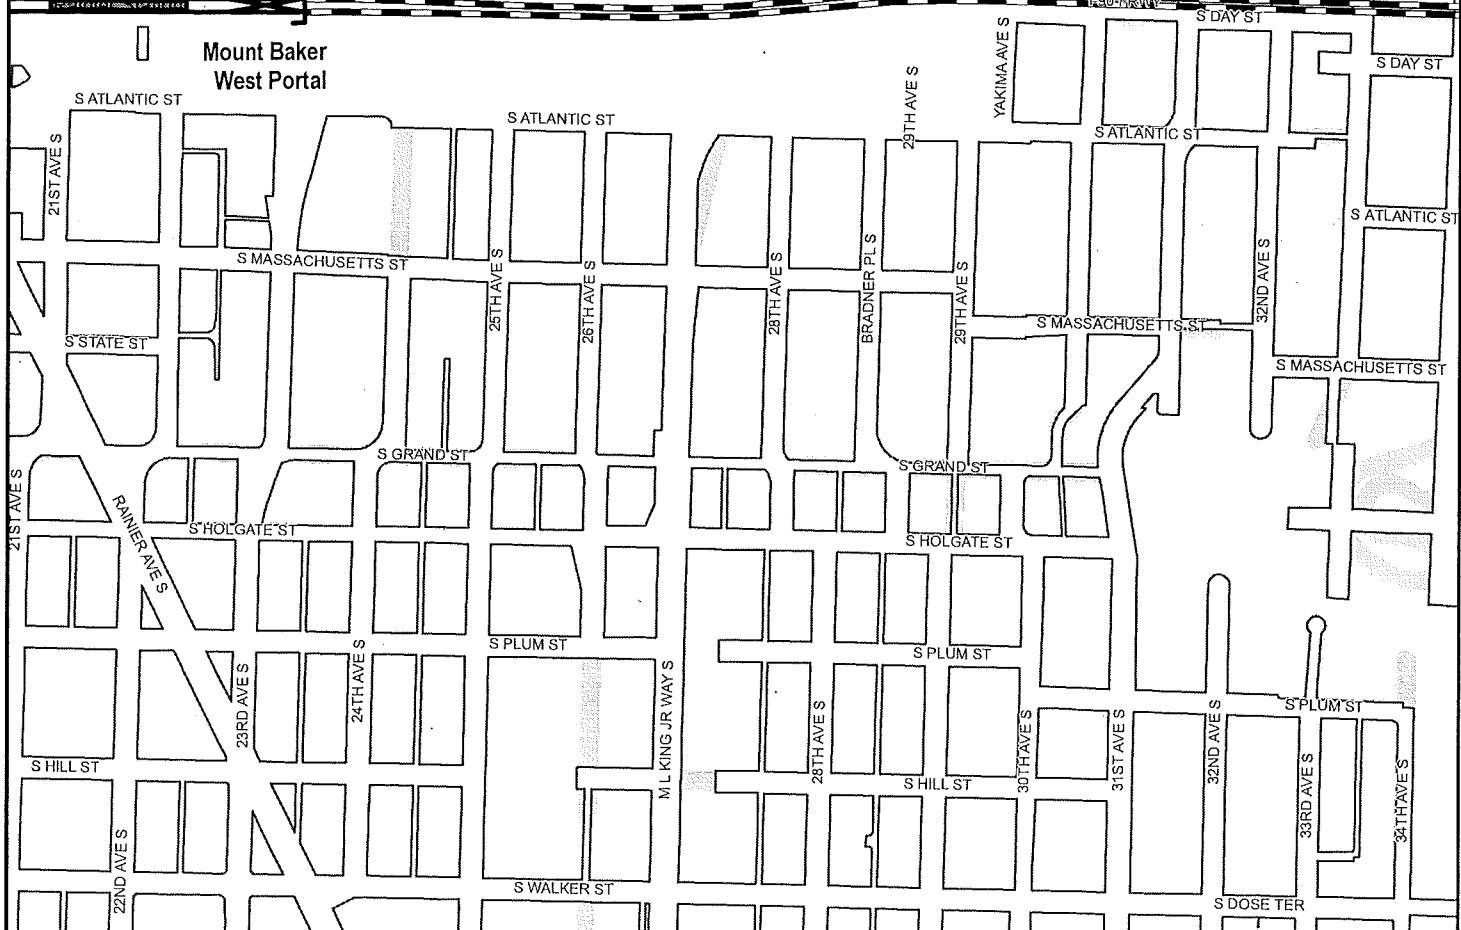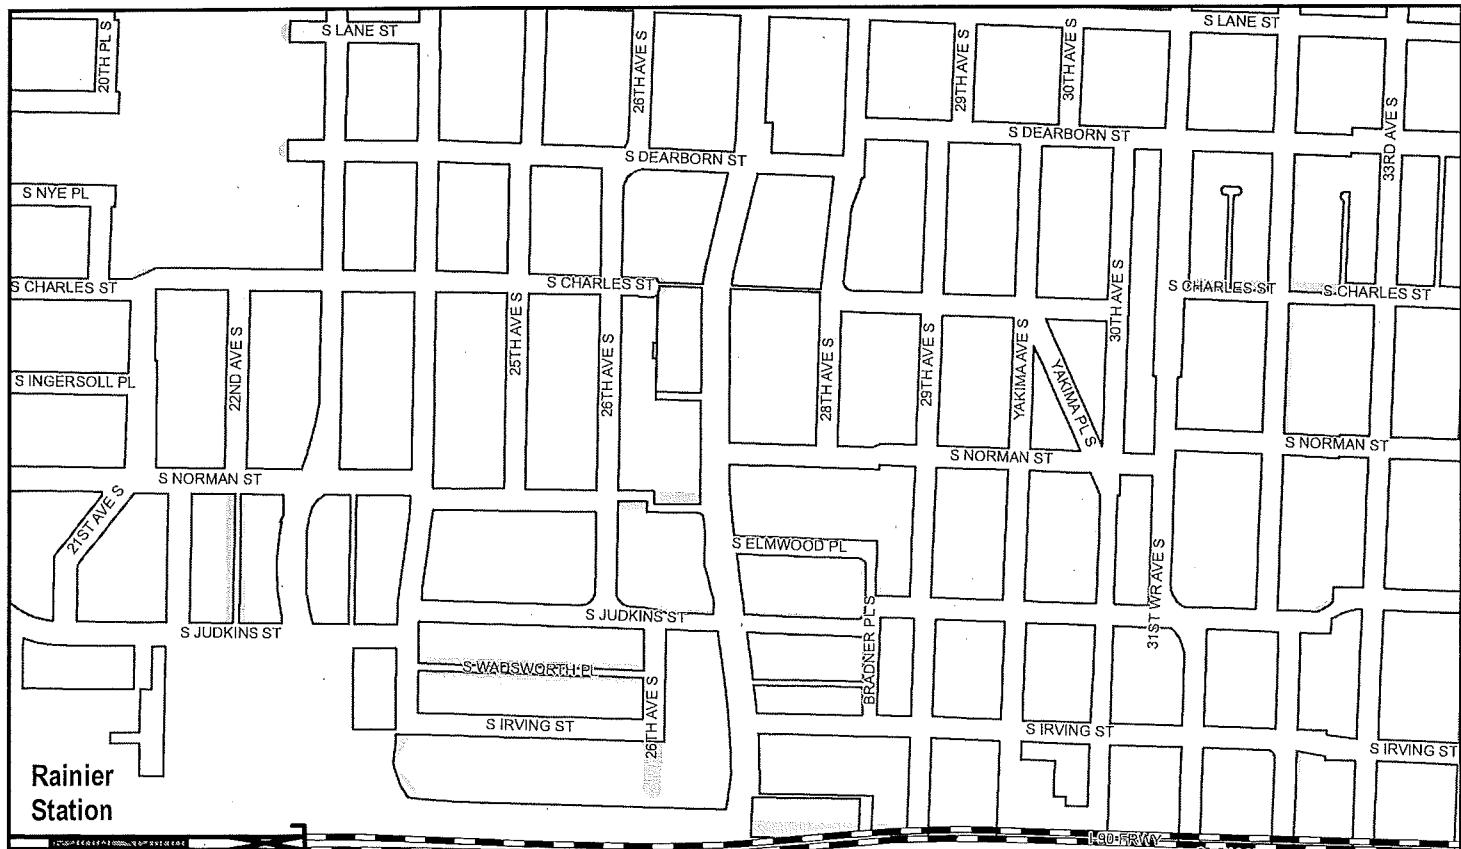

**Exhibit B: Light Rail Alignment,
Station Locations, and
Maintenance Facility Location**
Map 19 of 20



SoundTransit

Data source: King County GIS, City of Seattle, Sound Transit GIS
Map by: KING COUNTY PLANNING DIVISION, SEATTLE, WA

No guarantees of any sort implied, including accuracy, completeness, or timeliness.


Legend

- LIGHT RAIL ALIGNMENT**

 - Aerial
 - At Grade
 - Subway
 - ||||| Cut and Cover
 - Retained Cut / Fill



6. Search Trace & GIS
Estimated Date 10/12
2000 or later

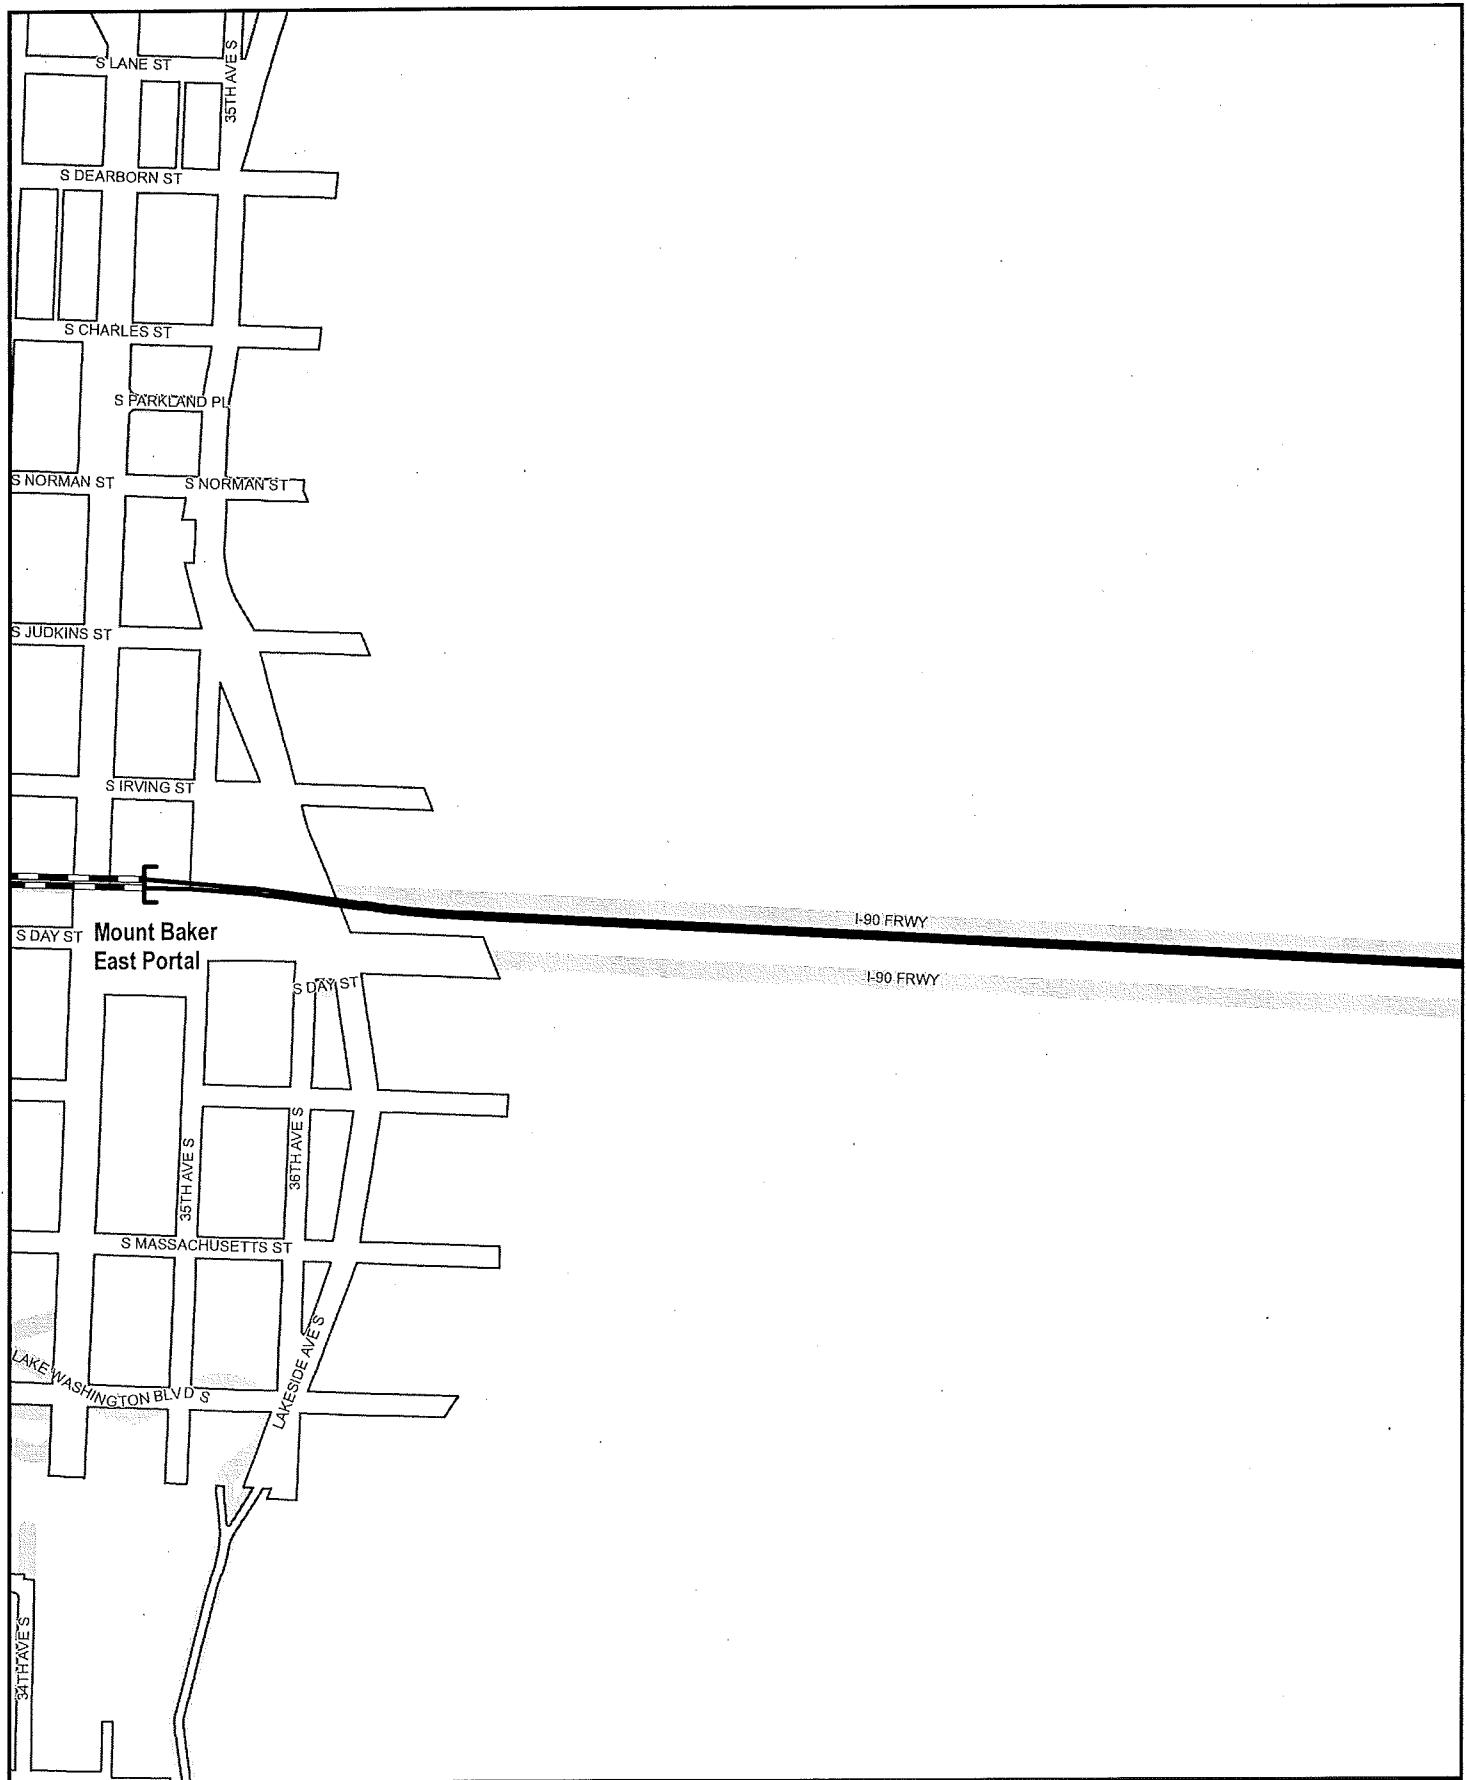

Legend

- LIGHT RAIL ALIGNMENT
 - Aerial
 - Cut and Cover
 - At Grade
 - Retained Cut / Fill
 - Subway

- Light rail station platform
- Maintenance facility
- Right-of-way

**Exhibit B: Light Rail Alignment,
Station Locations, and
Maintenance Facility Location
Map 20 of 20**



0 250 500
Feet



Data source: King County GIS, City of Seattle, Sound Transit GIS
© PROJECT 2010 Northgate Station Final Phase Update 2010

No guarantee of any sort implied, including accuracy, completeness, or fitness for use.




Ethan Melone
SDOT City of Seattle Alignment EXH C
May 7, 2013
Version #1

Exhibit C

Link Light Rail Project North Corridor Plans and Profile Drawings

Northgate Link (Northgate Station to University of Washington Station).....	1-23
U-Link (University of Washington Station to Pine St.).....	24-40
Initial Segment (Pine St. to City Limit – Boeing Access Road).....	41-93
East Link (International District Tunnel Station to Lake Washington, via I-90).....	94-106



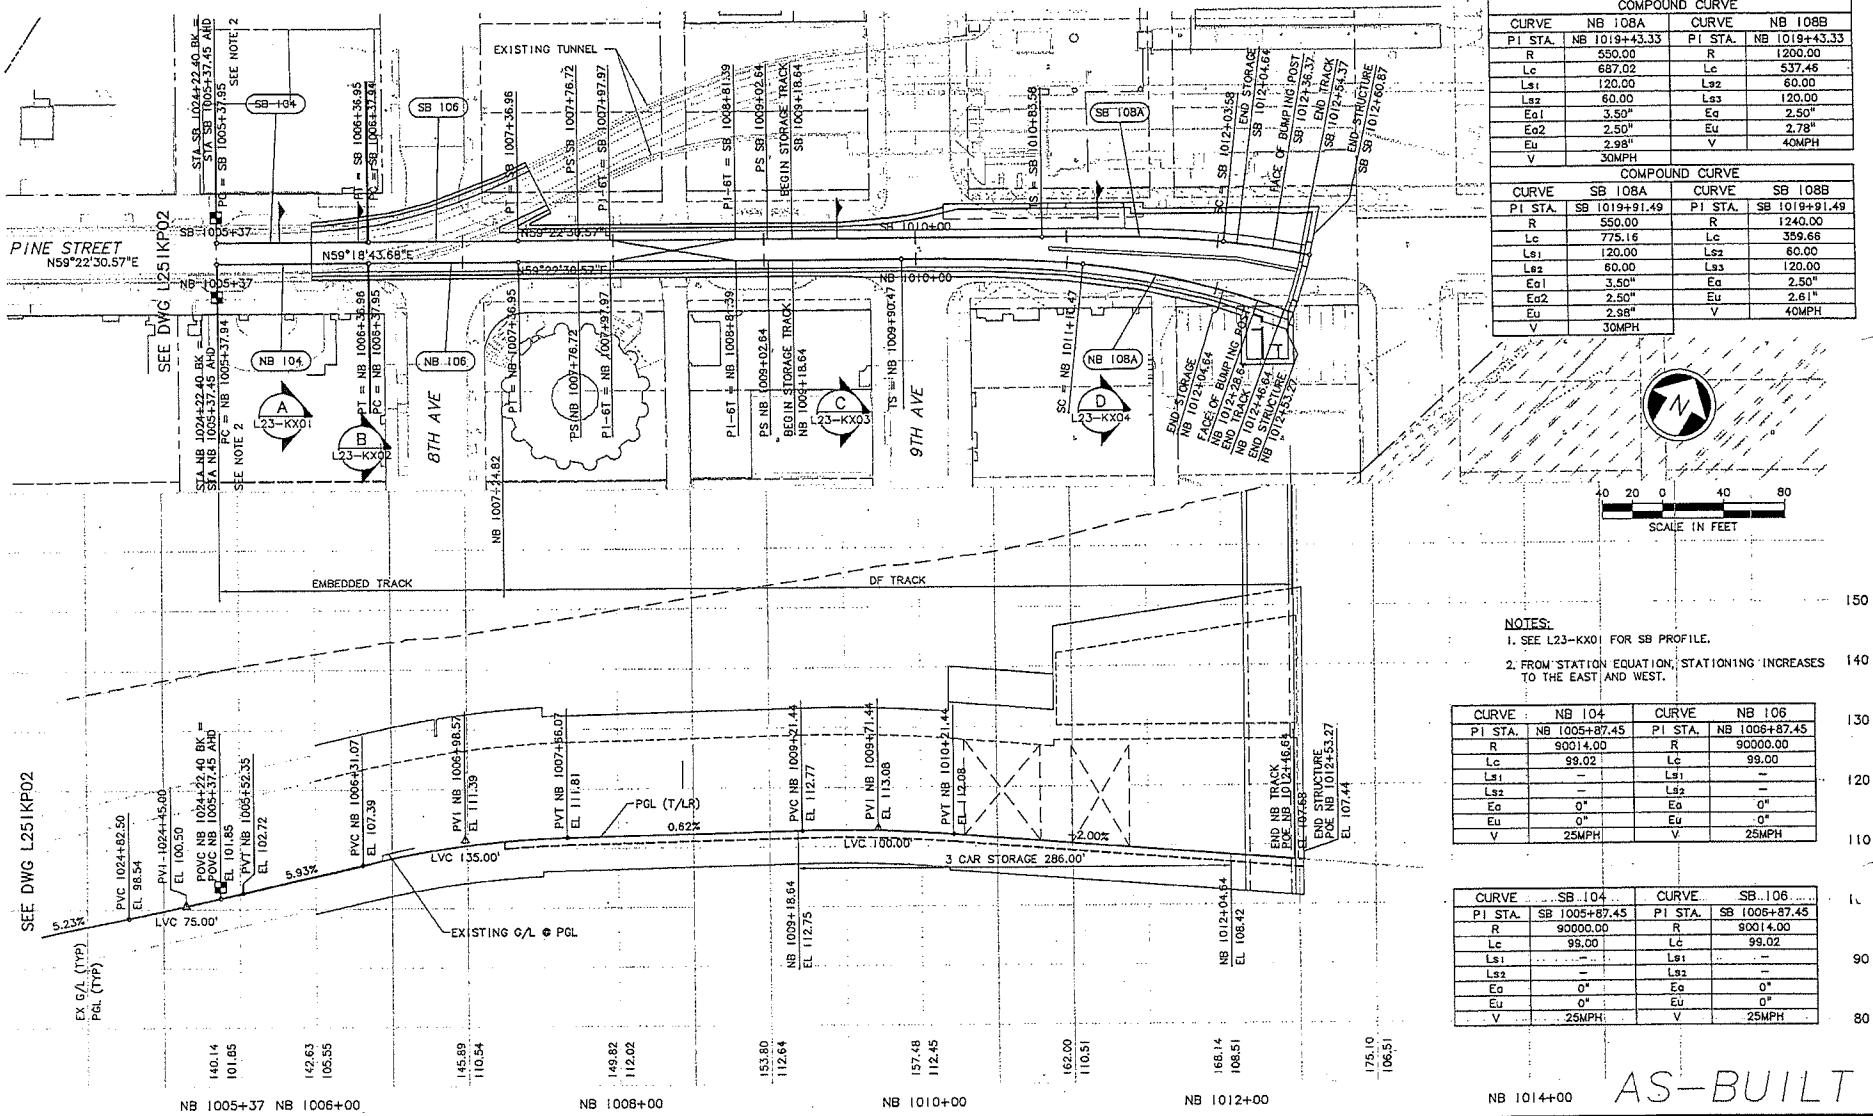

AS-BUILT

						 City of Seattle	Designed By: J. BAILEY
Work Order No.			Approved:			Drawn By:	
Permit No. Y4495			Inspector's Book:			K. WONG	
AS-BUILT			Received:			Checked By:	
B	02/29/08	BP	JLB	ASM	FC #050	J. GACIARZ	
A	04/14/08	JLB	ASM	ASM		Approved By:	
O	06/25/04				ISSUED FOR CONSTRUCTION	I. GUSTETICH	
SOT:							



LINK LIGHT RAIL PROJECT
CENTRAL CORRIDOR

PINE STREET STUB TUNNEL
TRACK PLAN AND PROFILE

Drawing No.: L23-KP01

REFS
Revised
K339F
K344F
CO0251KA
C318K
C339F
C344F
C52_120_SP
Z024K
ZG-22345CA
Unrevised

LTS SCALE
1=1

34325
FACILITY SERIAL NO.
DATE DRAWN
DRAWING NUMBER
REVISED
REVISIONS
DRAWN BY
APPROVED BY

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wobj2.CE4520



City of Seattle

Work Order No.	Approved
Permit No.	Y4495
Received:	K. WONG
Revised As Built:	M. COLYN
Approved By:	I. GUSTETICH
Date:	05/25/04
Drawn:	J. HARRISON
Chk:	
App:	
Revisions:	ISSUED FOR CONSTRUCTION

Designed By
J. BAILEY

Drawn By

K. WONG

Checked By

M. COLYN

Approved By

I. GUSTETICH



PSTC

SUBMITTED

06/25/04

S. KIRBY

05/25/04


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Filename:
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Contract No.:
C 510

Drawing No.:
L251KP02
Vault Pno.:
231-510
TRACK PLAN & SB PROFILE
STA SB 1024+22.40 TO STA SB 1028+50

Rev.:
B
Sheet No.:
42
Drawing No.:
L251KP03
Vault Pno.:
231-510
Link Light Rail Project
Central Corridor

SEE DWG L251KP03

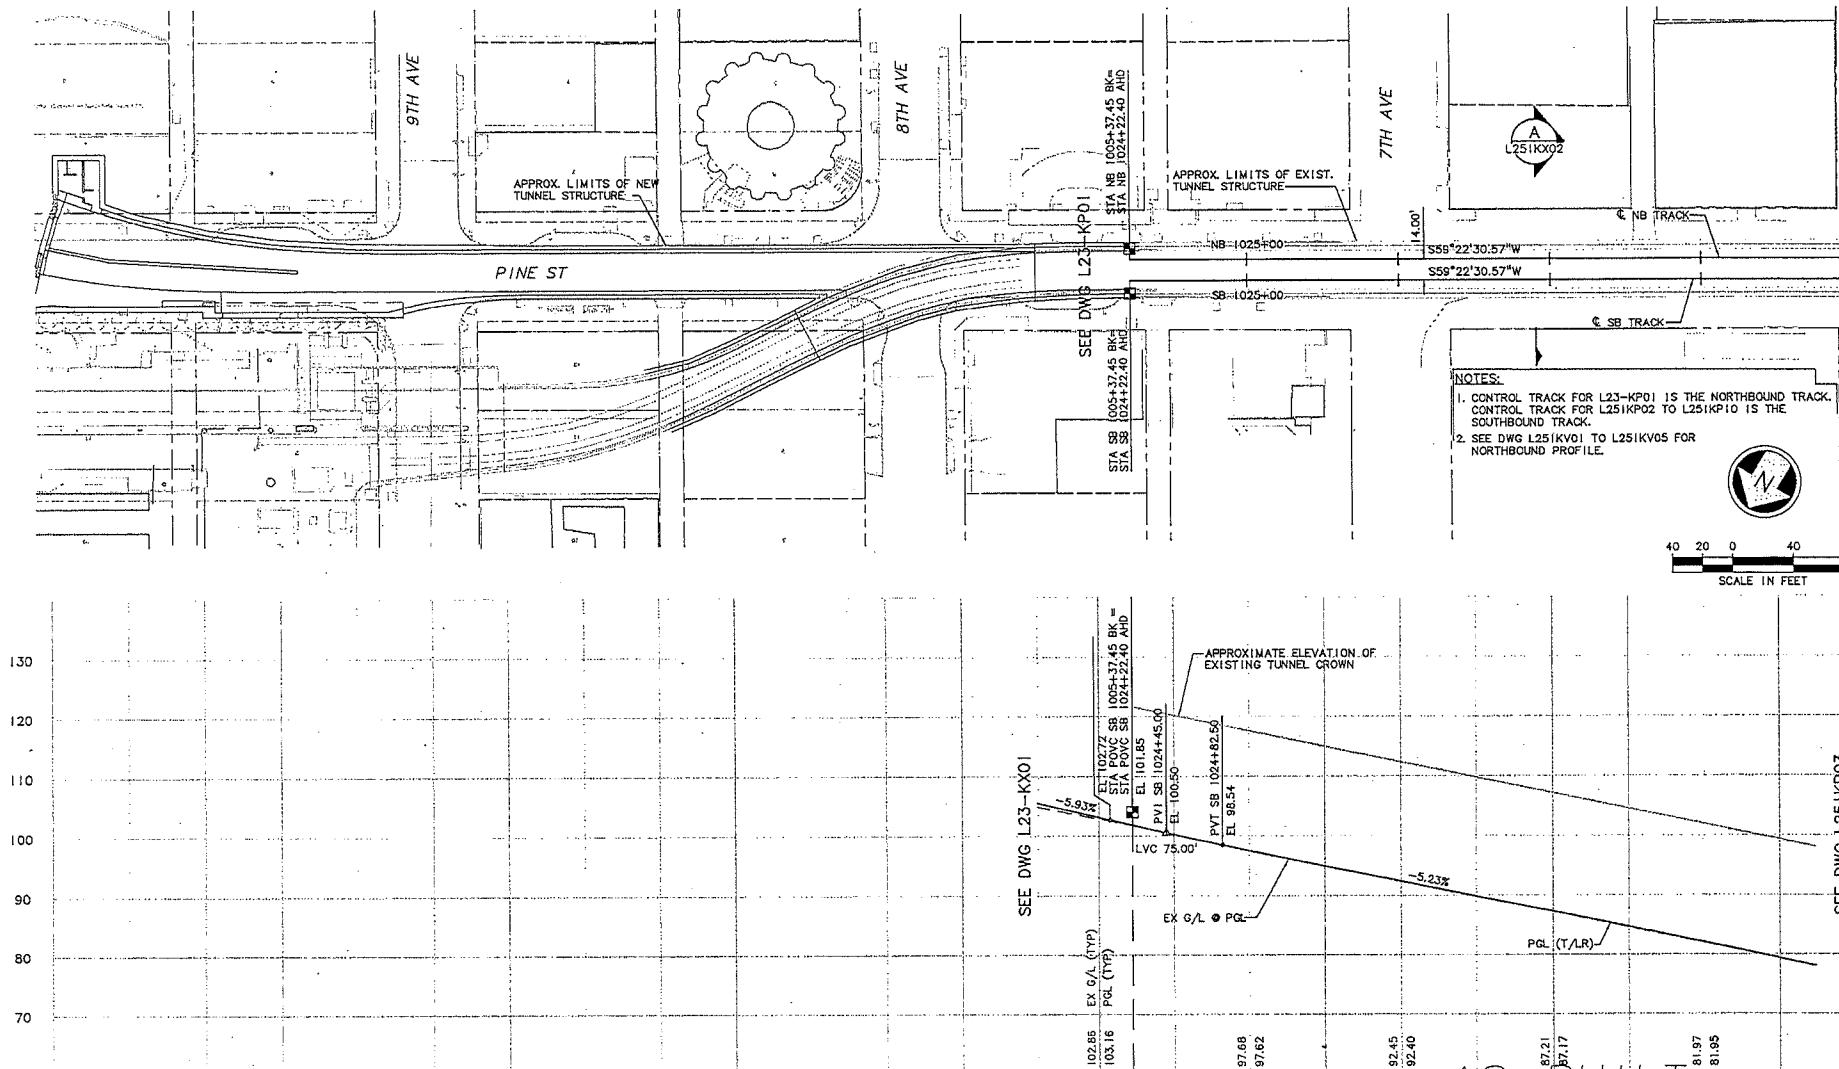

AS-BUILT

SB 1024+00 SB 1028+00

SEE DWG L251KP03

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X339SF	
X341RX	
X341SF	
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ZG-2234SEA	
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MADE EX-0 REV'D

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03>13/08 10:06 : w

SEE DWG L25 IKP02

SEE DWG L251KP02

A
L251F

The logo for the City of Seattle, featuring a stylized 'S' inside a circle.

City of Seattle

Work Order No.	Approved:
Permit No.	Y4495 Inspector's Book:
	Received:
	Revised As Built:
DOT:	

Designed By:	J. BAILEY
Drawn By:	K. WONG
Checked By:	M. COLYN
Approved By:	I. GUSTETICH

PS

STC

5

Scale:
H: 1"=4'
Filename:
C00_L2
Corrected

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51KP03.dwg
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LINK LIGHT R
CENTRAL

RAIL PROJECT
CORRIDOR

Drawing No.:
L251KR
Vault Plan No.
231-5

WESTLAKE STATION

C NB TRACK

C SB TRACK

PROPOSED PLATFORM EDGE, TYP

FUTURE TRACK BLOCKOUTS NOT SHOWN. SEE A


APPROXIMATE LIMITS OF EXISTING TUNNEL STRUCTURE

SEE DWG L251KPO4

N

CURVE SB 1610		CURVE NB 1610	
PI STA.	SB 1030+95.75	PI STA.	NB 1030+95.75
R	900.00	R	910.00
Lc	0.45	Lc	0.18
Ls ₁	51.00	Ls ₁	51.00
Ls ₂	51.00	Ls ₂	51.00
E _a	1.00°	E _a	1.00°
E _u	1.75°	E _u	1.72°
V	25 MPH	V	25 MPH

CURVE SB 1608		CURVE NB 1608	
PI STA.	SB 1025+91.60	PI STA.	NB 1025+91.60
R	900.00	R	910.00
Lc	0.35	Lc	0.28
Ls ₁	51.00	Ls ₁	51.00
Ls ₂	51.00	Ls ₂	51.00
E _a	1.00°	E _a	1.00°
E _u	1.75°	E _u	1.72°
V	25 MPH	V	25 MPH

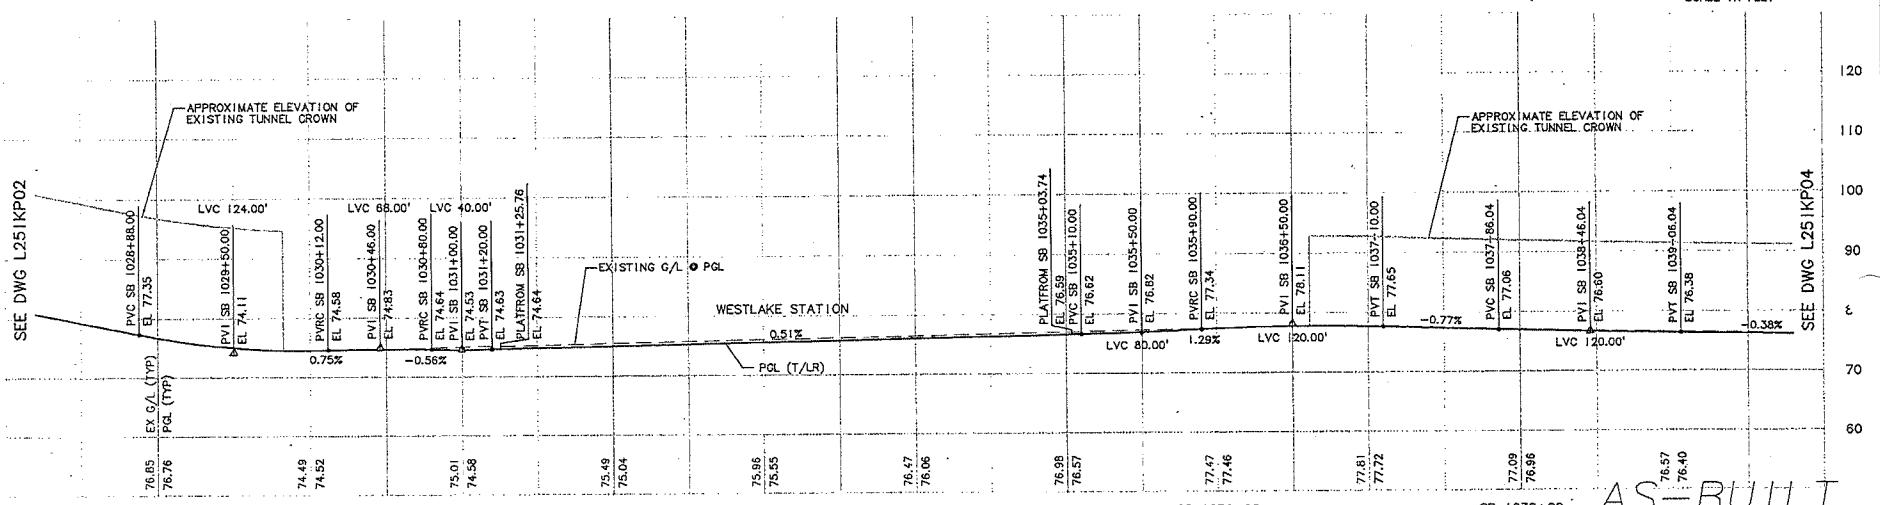


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Revised
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43335T
X31RDX
2412T
ZG-270010
CDL-L201A
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C33RDX
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CMV
CMV
ZG-2245TA
UNNUMBERED

LTS SCALE

SEE DWG L251KP03

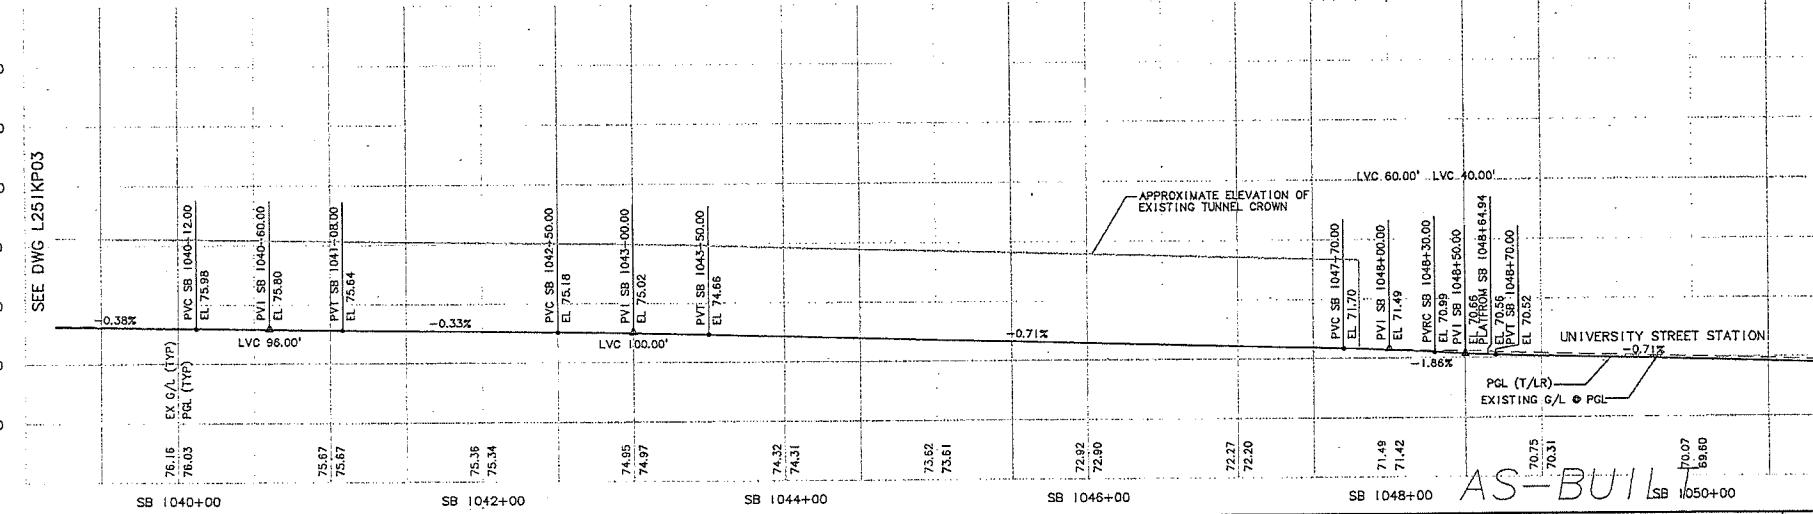

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Date:	06/25/04	Received:	M. COLYN
Revised As Built:		Approved By:	J. HARRISON
Date:	06/25/04	Date:	06/25/04
Revisions:		Approved:	S. KIRBY

City of Seattle

Designed By: J. BAILEY
Drawn By: K. WONG
Checked By: M. COLYN
Submitted: J. HARRISON

PSTC

SOUNDTRANSIT

Scale: H: 1" = 40'; V: 1" = 10'
Filename: COO_L251KP04.dwg
Contract No.: C 510

LINK LIGHT RAIL PROJECT
CENTRAL CORRIDOR
TRACK PLAN & SB PROFILE
STA SB 1039+50 TO STA SB 1050+50

Drawing No.: L251KP04
Vault Plan No. 231-510
Sheet No. 44 Rev. A



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Received
X14/ST
X14/SF
X14/ST
X14/ST
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C00-229002
C00-229002A
C00-229002B
C00-229002C
C00-229002D
C00-229002E
C00-229002F

Unresolved

LTS/CAL

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2

DATE LAST
MAILED
SERVINGS

RECEIVED
RECORDED

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SEE DWG L251KP04

UNIVERSITY ST

L251KX04

NB 1050+00
S30°37'42.23"E
25.79'
+00

UNIVERSITY STREET STATION

PROPOSED PLATFORM
EDGE, TYP

TS = SB 1052+45.82

PLATFORM END

NB 1620

SB 1620

SC = SB 1052+61.44

SC = SB 1052+45.55

CS = NB 1052+45.02

CS = NB 1052+45.32

SC = NB 1052+45.32

CS = NB 1052+45.32

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Resolved

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X345RX
X345SF
ZG-C20020
C00_L251KA
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X090SF
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Unresolved

LTSCALE
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HUMANUS 1251KE

SS 1002+00			SS 1004+00			SS 1006+00			SS 1008+00			SS 1010+00					
						 City of Seattle			Designed By: J. BAILEY								
Work Order No. Permit No.			Approved Inspector's Book			Drawn By: K. WONG			Checkered By: M. COLYN			Scale: H: 1" = 40'; V: 1' = 10'			Drawing No.: L251KP06		
02/29/08 KTW JLB			AS-BUILT			Received By: M. COLYN			Approved By: I. GUSTETICH			Date: 06/25/04			Contract No.: C 510		
0 Date: 06/25/04			ISSUED FOR CONSTRUCTION			Date: 06/25/04			Approved: S. KIRBY			Date: 06/25/04			Sheet No.: 46 A		
0 Date: 06/25/04			0 Date: 06/25/04			0 Date: 06/25/04			0 Date: 06/25/04			0 Date: 06/24/04			Rev.: B		
LINK LIGHT RAIL PROJECT CENTRAL CORRIDOR																	
TRACK PLAN & SB PROFILE																	
STA SB 1061+50 TO STA SB 1072+50																	

XNET'S

Resolved

ZG-CJ0020
COO_J751KA
COO_XPLAT
X090RJK
X090SF
ZG-2234SE

Unresolved

LTSCALE

34325 VAULT SERIAL NO. DATE WORK NATURE REVISIONS MADE BY D. REYNOLDS

H:\work\coo_1251K



The Sound Transit logo consists of a stylized 'T' shape above the word "SOUNDTRANSIT".

**LINK LIGHT RAIL PROJECT
CENTRAL CORRIDOR**

Drawing No.:	L251KP07
Vault Plan No.:	231-510
Sheet No.:	Rev.:
47	A


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2C-G20020
COOLSPAT
DODSON
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X0895S
X0895T
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X0895Z
Unresponsible

LTS/CALC


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PAGE NO.

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06/25/04 10:07 :
06/25/04 10:07 :

SEE DWG L251KP07

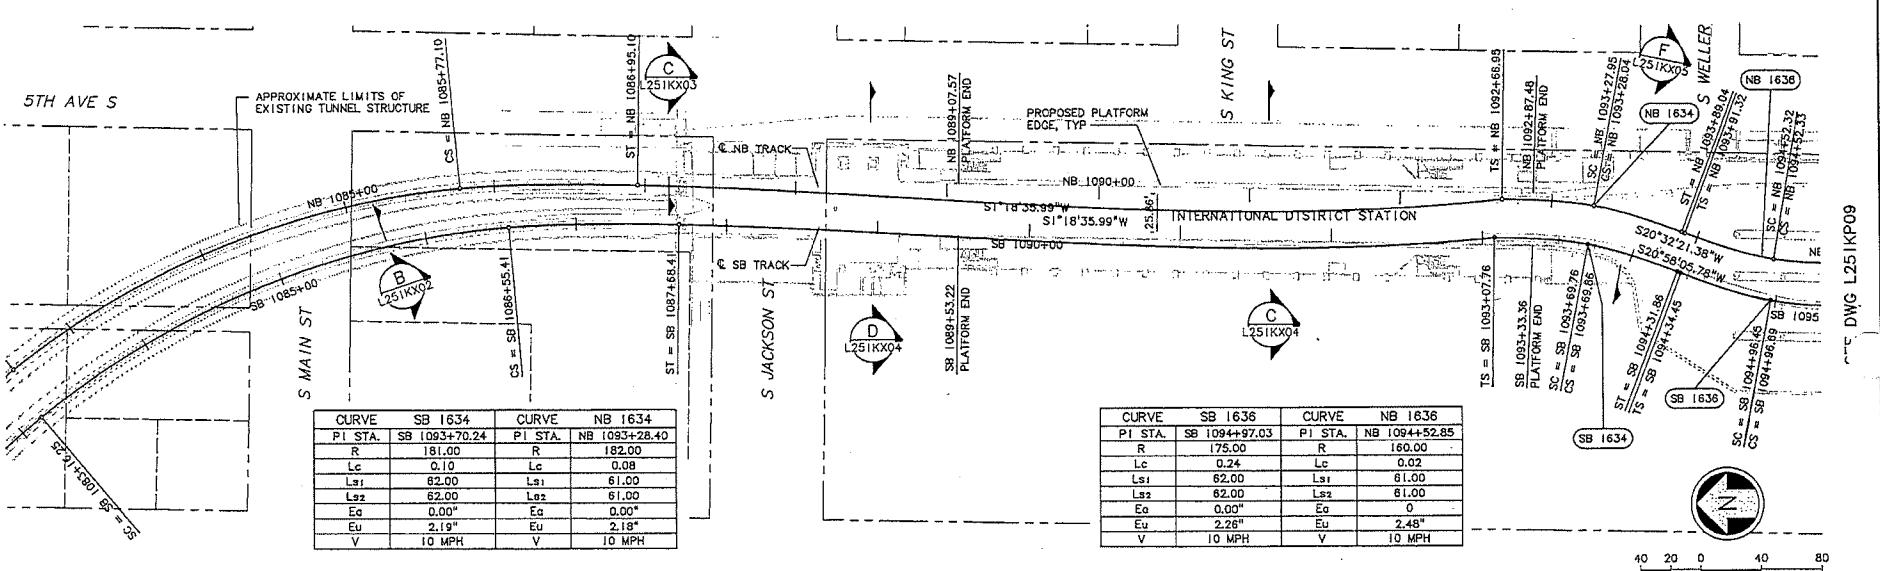

SEE DWG L251KP07

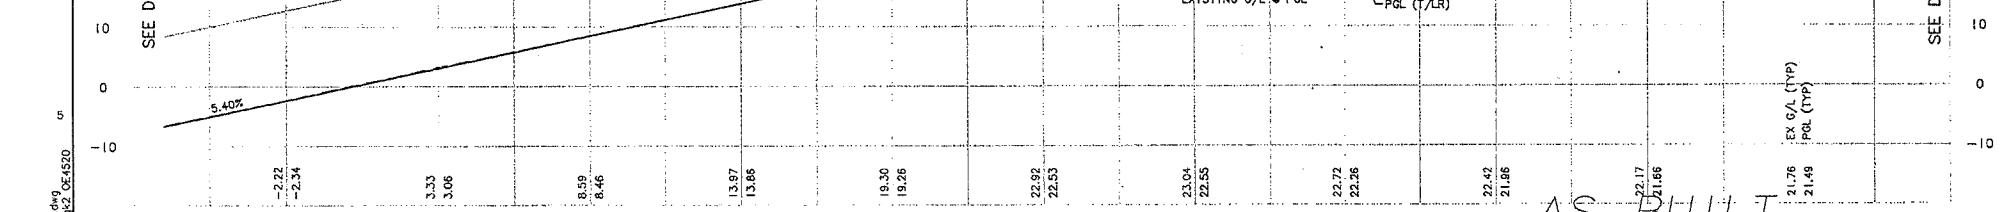

City of Seattle		Designed By:	J. BAILEY	Scale:	L251KP08
Work Order No.	Approved:	Drawn By:		H: 1"=40'; V: 1"=10'	
Permit No.	Y4495	Inspected's Book:	K. WONG	Filename:	COO_L251KP08.dwg
Received:		Checked By:	M. COLYN	Contract No.:	C 510
Revised As Built:		Approved By:	I. GUSTETCH	Date:	02/24/04
Date:	Den. Chk. App. Revisions	SDOT:	J. HARRISON	Date:	06/25/04

PSTC

SOUNDTRANSIT

LINK LIGHT RAIL PROJECT
CENTRAL CORRIDOR

AS-BUILT

STA SB 1083+50 TO STA SB 1094+50


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Vault Plan No.:

Sheet No.:

Rev.:



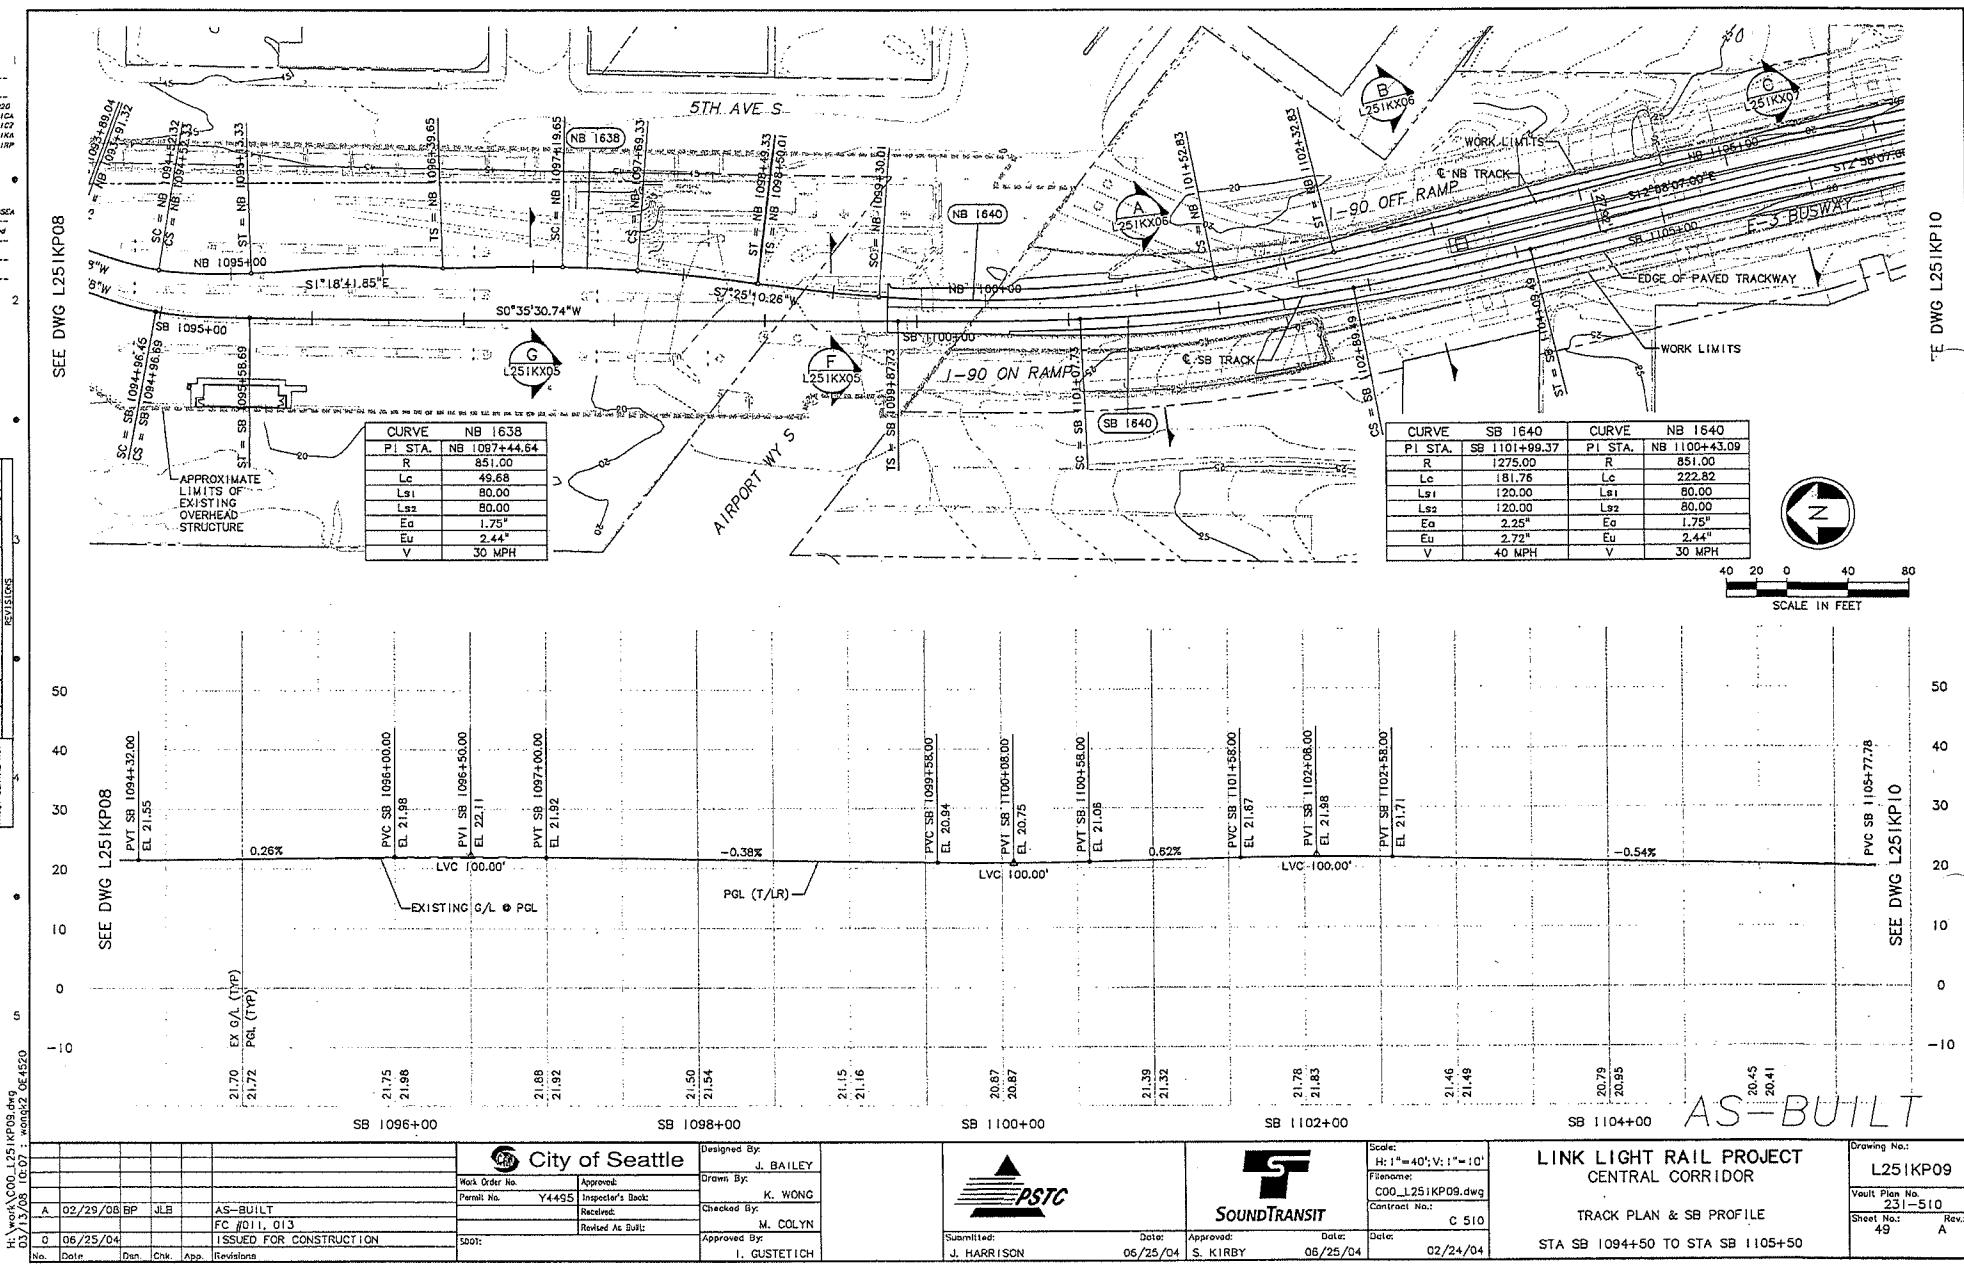

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C00_L251R
C05_L251R
C05_R03_C
X092CN
X092RX
X002SF
ZG-2234SE

Unrespired

LTSCALE
20

SEE DWG L251KPO9

34325 VAULT SERIAL NO. DATE MARK NATURE MADE BY CO REV'D

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SEE DMC 1251K90

22 / 16212

 City of Seattle

							 City of Seattle	
							Work Order No.	Approved:
							Permit No.	Y4495 Inspector's Book:
A	02/29/08	BP	JLB	AS-BUILT			Received:	
I	10/12/05	JLB	MC	NG	FCC	D13	Revised As Built:	
C	06/25/04	ISSUED FOR CONSTRUCTION					SOC:	

Designed By:	J. BAILEY
Drawn By:	K. WONG
Checked By:	M. COLYN
Approved By:	I. GUSTETICH




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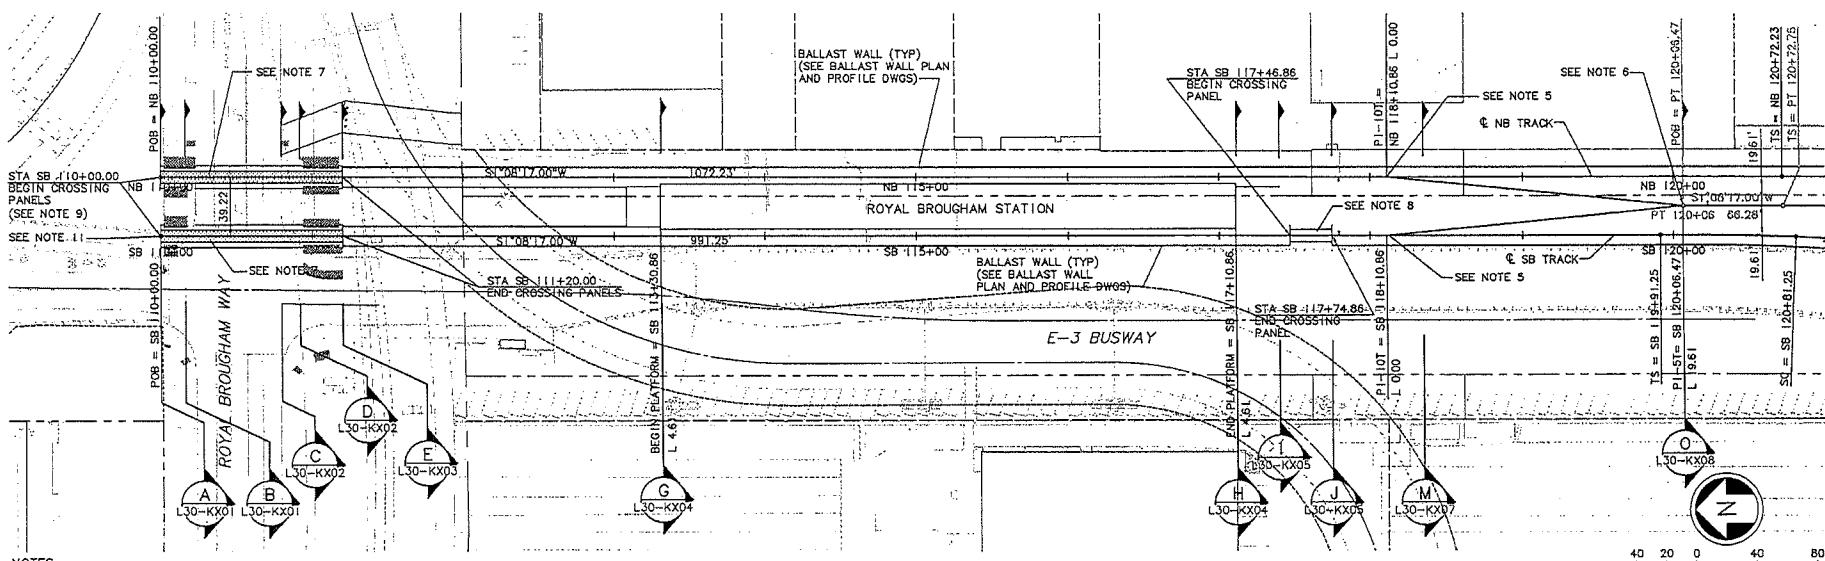
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Control No.:
C 510
Date:
02/24/04

LINK LIGHT RAIL PROJECT
CENTRAL CORRIDOR

Drawing No.:	L251KP10
Vault Plan No.	231-510
Sheet No.:	Rev 50 A

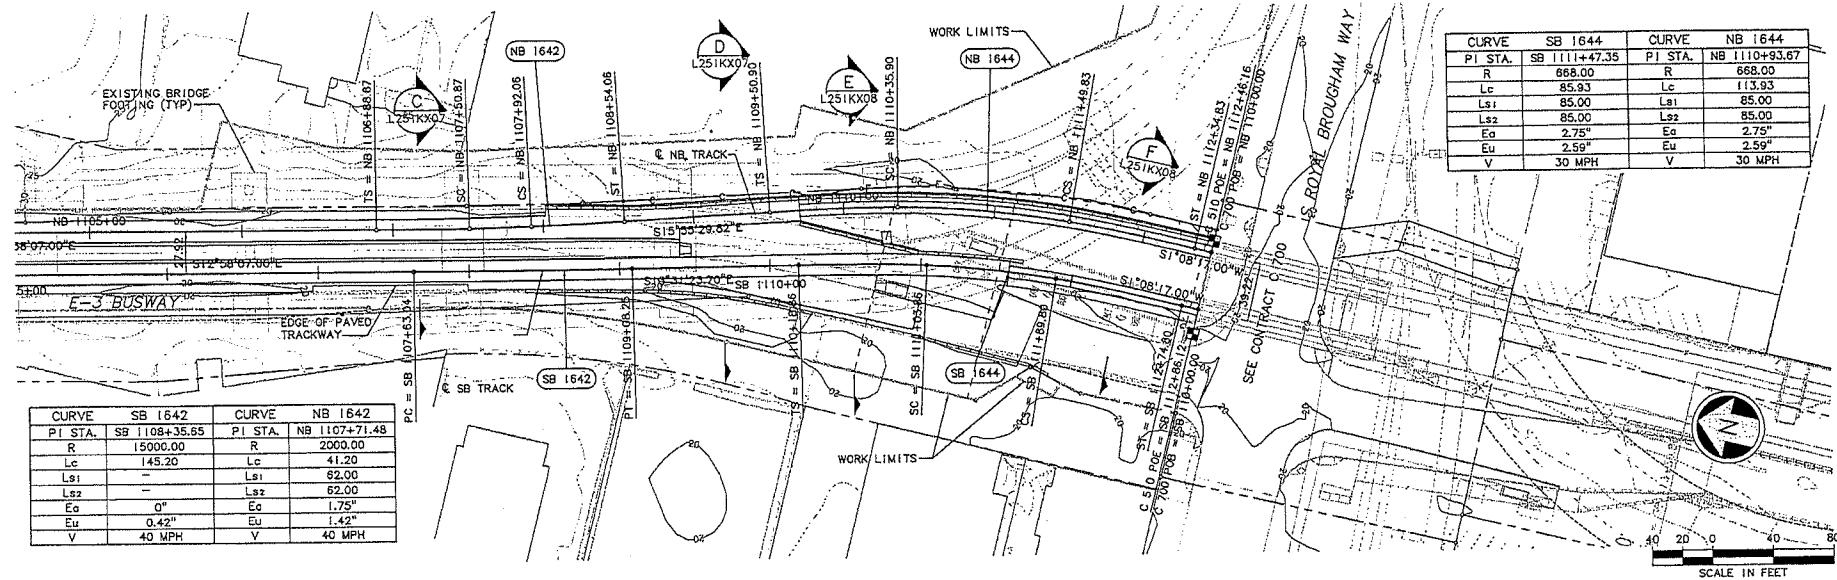


AS-BUILT



NOTES:

- SOUTHBOUND TRACK IS CONTROL TRACK. NORTHBOUND TRACK IS NON-CONTROL TRACK AND TOP OF RAIL SHALL EQUAL CONTROL TRACK TOP OF RAIL UNLESS OTHERWISE NOTED. YARD LEAD AND POCKET TRACK PROFILES ARE INDEPENDENT OF CONTROL TRACK. SEE GENERAL NOTES ON DWG G30-C202.
- SEE DWG L30-KAO1 FOR ADDITIONAL ALIGNMENT DATA.
- SEE TRACK CHART SERIES L30-KCXX FOR ADDITIONAL TRACKWORK DETAILS.
- SEE DWG L30-KP01 FOR POCKET TRACK PLAN AND PROFILE.
- SEE TRACKWORK STANDARD DWG KS110 FOR NO. 10 TURNOUT ON BALLASTED TRACK DETAILS.
- SEE STANDARD DWG KS114 FOR NO. 5 EQUILATERAL TURNOUT ON BALLASTED TRACK DETAILS.
- SEE TRACKWORK STANDARD DWGS KS704 AND KS705 FOR AT-GRADE ROAD CROSSING PANEL DETAILS. CROSSING PANELS TO BE CONSTRUCTED WITHOUT THE UNDERDRAINS SHOWN IN STANDARD DRAWINGS KS704 AND KS705. SEE DWG SERIES L30-USXX FOR UNDERDRAIN LOCATIONS.
- SEE TRACKWORK STANDARD DWG KS719 FOR PEDESTRIAN CROSSING PANEL DETAILS.
- RAILS TO BE EXTENDED 5' BEYOND CROSSING PANELS. SEE DETAIL DWG L30-KD03.
- SEE DWG R05-CPO1 FOR SECTION CUTS NORTH OF ROYAL BROUGHAM WAY.
- SEE DWG R05-CPO1 FOR ALIGNMENT DATA FOR FUTURE C500 SOUTH BOUND TRACK.

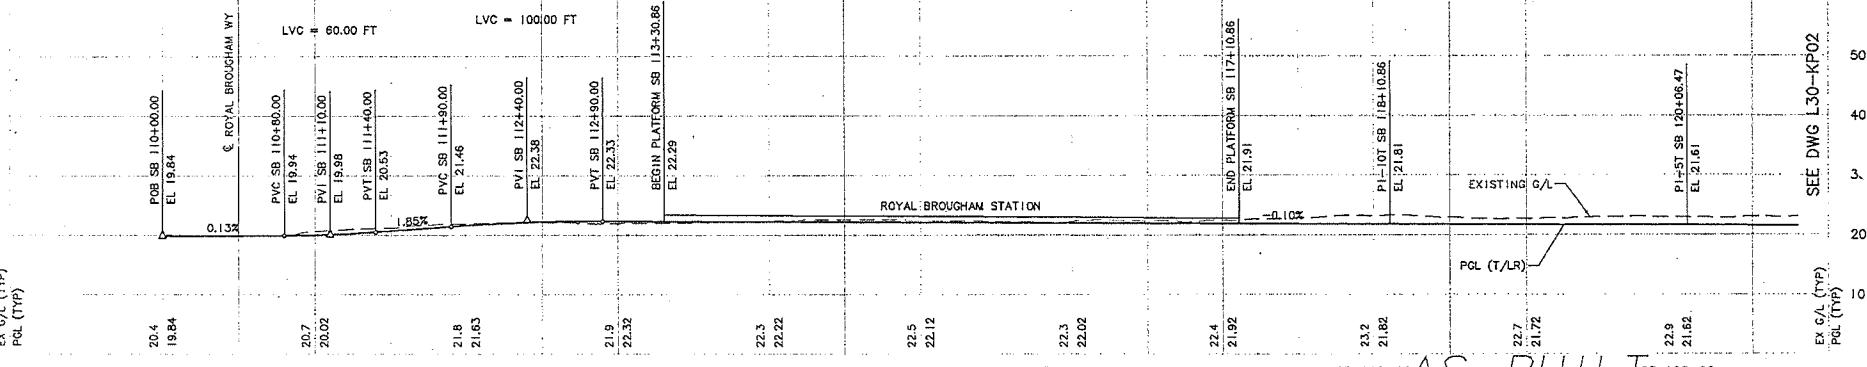

EX G/L (TP) POL (TP)		20.4 19.84		SB 110+00		Pb SB 110+00.00 EL 19.64		E ROYAL BROUGHAM WAY		LVC = 100.00 FT		PVC SB 110+00.00 EL 19.34		PV SB 111+00.00 EL 19.38		PV SB 111+00.00 EL 20.53		PV SB 111+00.00 EL 21.46		PV SB 112+00.00 EL 22.39		BEGIN PLATFORM SB 113+30.86 EL 22.29		END PLATFORM SB 117+10.86 EL 21.91		Pb LOT SB 118+10.86 EL 21.81		PCL (T/LR) 21.72		EX G/L (TP) POL (TP)	
10	10	20.7	20.2	21.8	21.63	21.9	22.32	22.22	22.12	22.02	22.3	22.2	22.1	22.0	21.9	21.8	21.7	21.6	21.5	21.4	21.3	21.2	21.1	21.0	20.9	20.8	20.7	20.6	20.5	20.4	
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A	10/30/09 BP	JLS	AS-BUILT																												
O	07/31/03		ISSUED FOR CONSTRUCTION																												
No.	Date	Des.	Chk.	App.	Revisions																										



City of Seattle

Designed By:

K. LAUZEN

Drawn By:

T. KABOCHO

Approved:

Y1430

Permit No.:

Inspector's Doc#:

Received:

C. TORRES

Revised As Built:

N. MITCHELL

Approved By:

N. MITCHELL

HUITZ-ZOLIARS



SOUNDTRANSIT

Scale:

H: 1"=40'; V: 1"=10'

File name:

C05_L30-KP01.DWG

Contract No.:

C 700

Date:

04/01/02

Approved:

K. NG

Date:

07/31/03

Date:

07/31/03

LINK LIGHT RAIL PROJECT
SOUTH CORRIDOR

TRACK PLAN & PROFILE

STA SB 110+00 TO STA SB 120+50

Drawing No.: L30-KP01

Vault Plan No.: 231-700

Sheet No.: 51

Rev.: A

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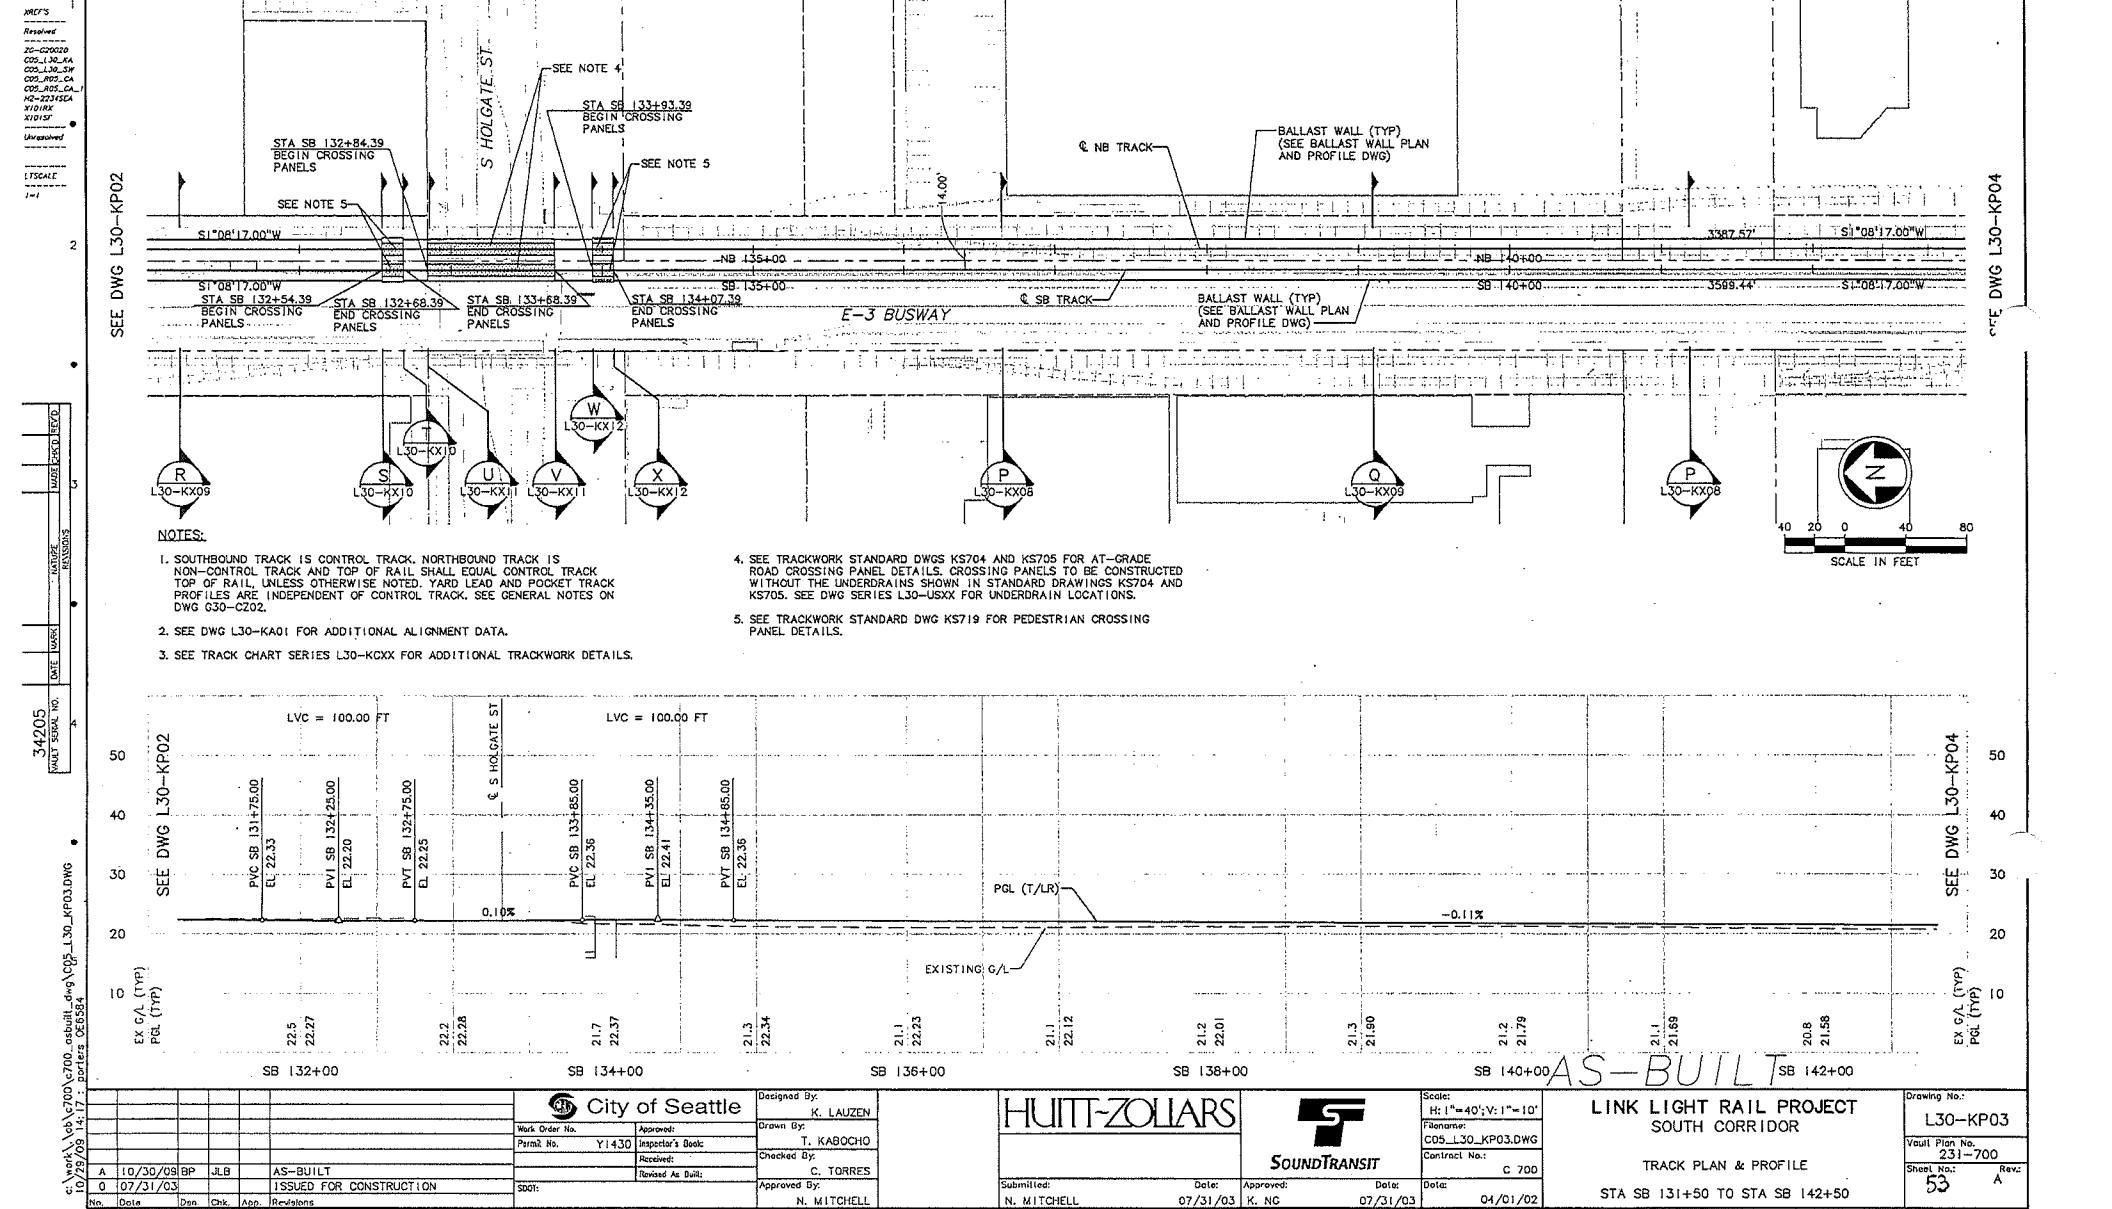
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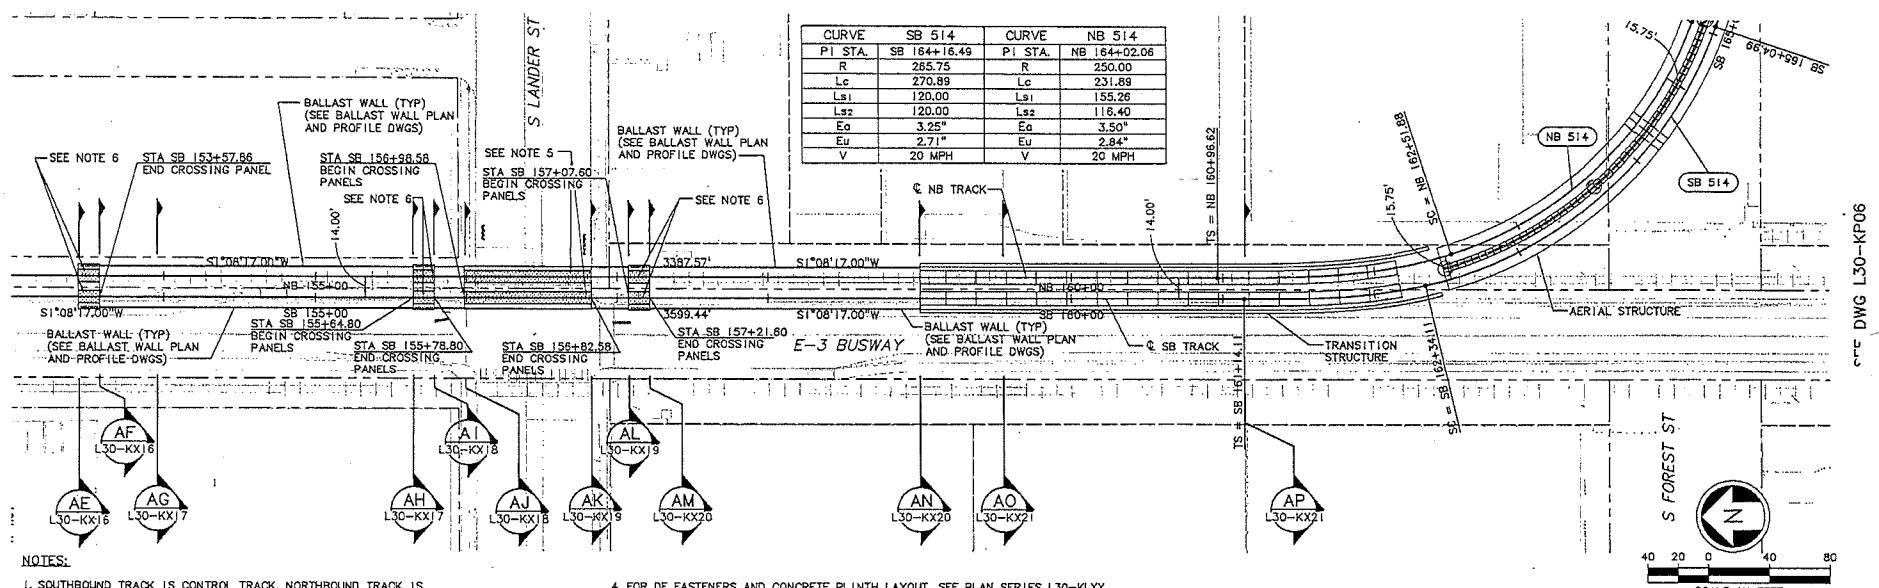
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SEE DWG L30-KP04

XREFS
Revised
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X103ST
UnrevisedL SCALE
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NOTES
1. NATIVE
2. DRAFT
3. REVISIONS
4. MISC'D REV
5. C

34205
STLIS SERIAL NO.
DATE DRAWN
DRAWN BY
REVISIONS

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B	10/30/09	RP	JLB	AS-BUILT
A	06/17/05	TW	LG	REVISED TOP OF RAIL PROFILE
C	07/31/03			ISSUED FOR CONSTRUCTION
No.	Date	Ban.	Clik.	App. Revisions

City of Seattle

Work Order No.

Approved:

Designed By:

K. LAUZEN

Drawn By:

T. KABOCHO

Permit No.:

Y1430

Inspector's Desk:

Received:

Checked By:

C. TORRES

Reviewed As Built:

Approved By:

SDOT:

N. MITCHELL

HUITZ-ZOLIARS

Submitted:

N. MITCHELL

Date:

06/17/05

Approved:

K. NG

Date:

06/17/05

Date:

04/01/02



SOUNDTRANSIT

LINK LIGHT RAIL PROJECT
SOUTH CORRIDOR

TRACK PLAN & PROFILE

STA SB 153+50 TO STA SB 164+50

Drawing No.: L30-KP05

Vault Plan No.: 231-700

Sheet No.: 55


Rev.: B



34205
VARIANT NO.
DATE WORKED
NAME OF PERSONS


XREFS
Revised
C05_L30-KA
C05_L30_SP
C05_L30_CCA
H-234-002
X102RR
X102NN
X103SF
Unscaled
LISCALE
1:1

SEE DWG L30-KP05

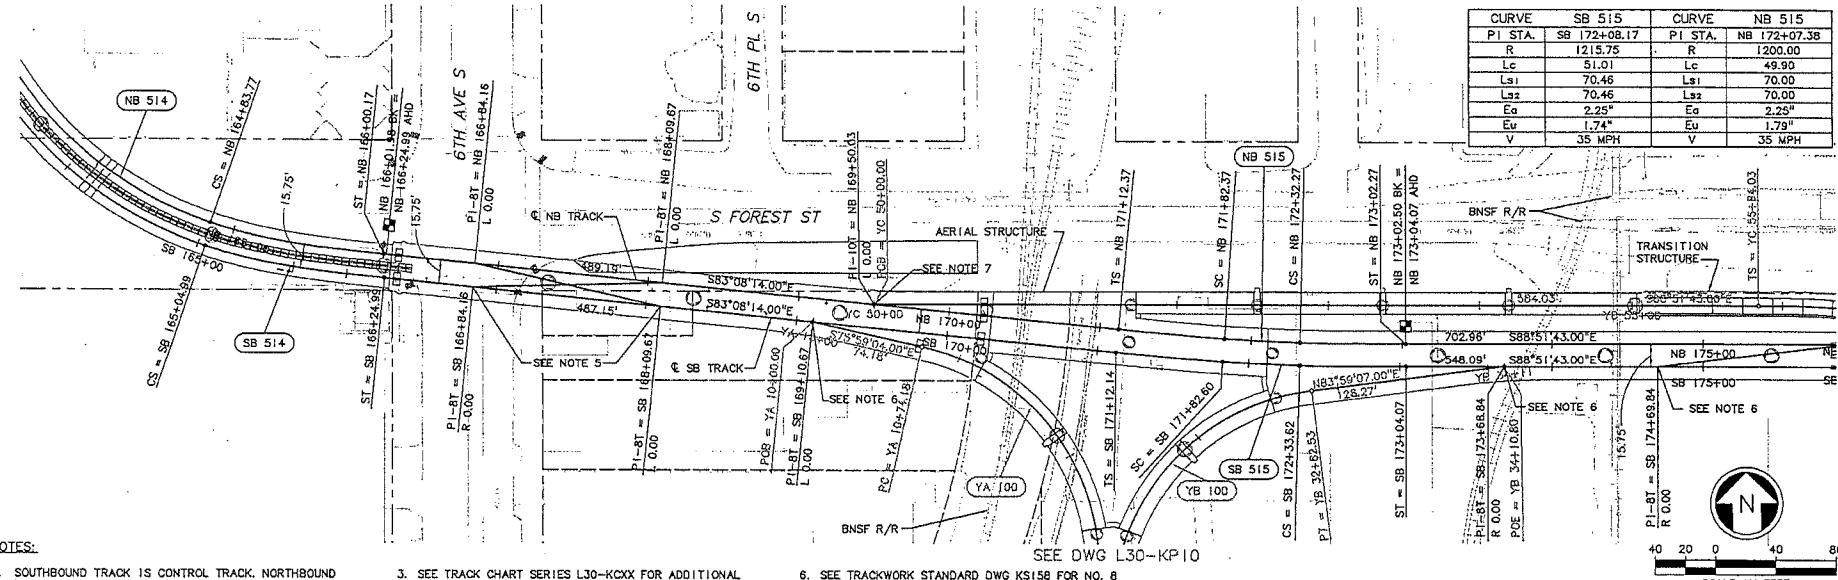

NOTES:

1. SOUTHBOUND TRACK IS CONTROL TRACK, NORTHBOUND TRACK IS NON-CONTROL TRACK AND TOP OF RAIL SHALL EQUAL CONTROL TRACK TOP OF RAIL, UNLESS OTHERWISE NOTED. YARD LEAD AND POCKET TRACK PROFILES ARE INDEPENDENT OF CONTROL TRACK. SEE GENERAL NOTES ON DWG G30-C202.
2. SEE DWG L30-KA01 FOR ADDITIONAL ALIGNMENT DATA. LVC = 200.00 FT
3. SEE TRACK CHART SERIES L30-KCXX FOR ADDITIONAL TRACKWORK DETAILS.
4. FOR DF FASTENERS AND CONCRETE PLINTH LAYOUT, SEE PLAN SERIES L30-KLX.
5. SEE TRACKWORK STANDARD DWG KS324 FOR NO. 8 DOUBLE CROSSOVER DIRECT FIXATION DETAILS.
6. SEE TRACKWORK STANDARD DWG KS158 FOR NO. 8 DOUBLE CROSSOVER DIRECT FIXATION DETAILS.
7. SEE TRACKWORK STANDARD DWG KS161 FOR NO. 10 DOUBLE CROSSOVER DIRECT FIXATION DETAILS.

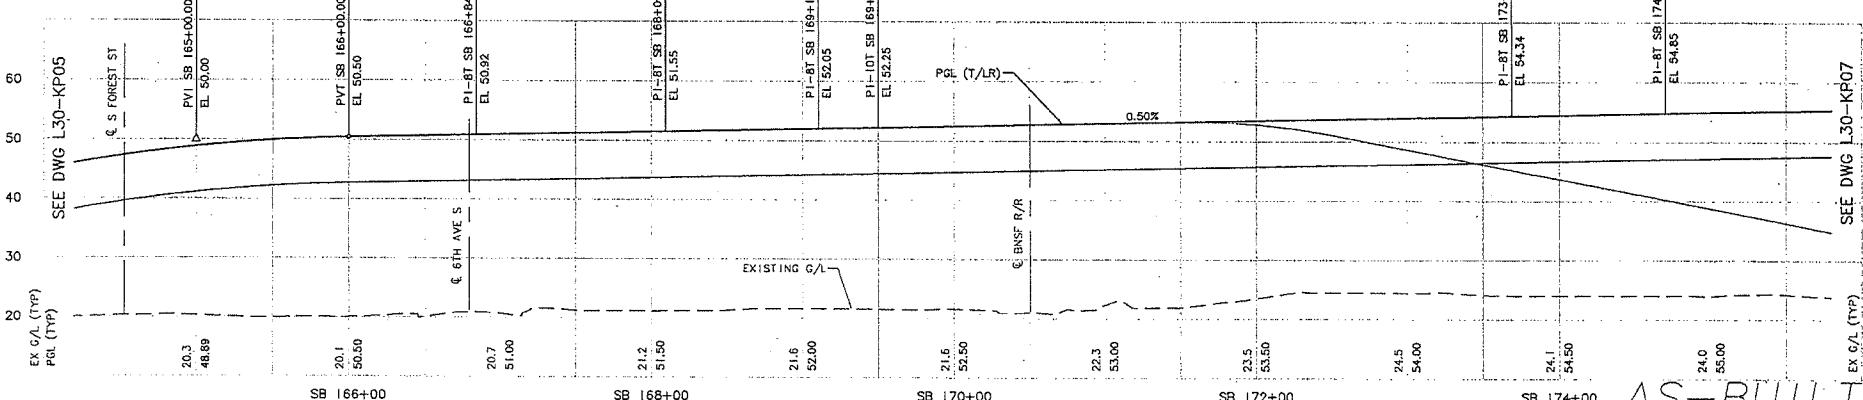

AS-BUILT

City of Seattle		HUITZ-ZOLLARS		LINK LIGHT RAIL PROJECT	
Work Order No.	Approved:	Designed By:		Scope:	Drawing No.:
Permit No.	Y1430	Drewn By:	K. LAUZEN	H: I = 40'; V: I = 10'	L30-KP06
Received:	Inspector's Book:	Checked By:	T. KABOCHO	Filename:	Vault Plan No.:
Revised As Built:	C. TORRES	Approved By:	N. MITCHELL	C05_L30_KP06.DWG	231-700
SDOR:		Submitted:	N. MITCHELL	Contract No.:	Sheet No.:
No Date	Den. Chk. App. Revisions	Date:	06/17/05	C 700	56
		Approved:	K. NG	Date:	B
		Date:	06/17/05	04/01/02	



34205

VALUET SERIAL NO.	DATE	MARK	NATURE	PAGE	REV'D
					REVISIONS

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10/29/09 14:22 : borders QFB5B4


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Received
COS_L30_K
COS_L30_S
12-2234SC
X102RFX
X102SF
X103RFX
X103SF
CG-C70020
~~RECEIVED~~

FSCALE


NOTES

1. SOUTHBOUND TRACK IS CONTROL TRACK. NORTHBOUND TRACK IS NON-CONTROL TRACK AND TOP OF RAIL SHALL EQUAL CONTROL TRACK TOP OF RAIL, UNLESS OTHERWISE NOTED. YARD LEAD AND POCKET TRACK PROFILES ARE INDEPENDENT OF CONTROL TRACK. SEE GENERAL NOTES ON DWG G30-C02C.
 2. SEE DWG L30-KAO! FOR ADDITIONAL ALIGNMENT DATA.
 3. SEE TRACK CHART SERIES L30-KCXZ FOR ADDITIONAL TRACKWORK DETAILS.
 4. FOR OF FASTENERS AND CONCRETE PLINTH LAYOUT, SEE PLAN SERIES L30-KLXX.

LVC = 100.00 FT

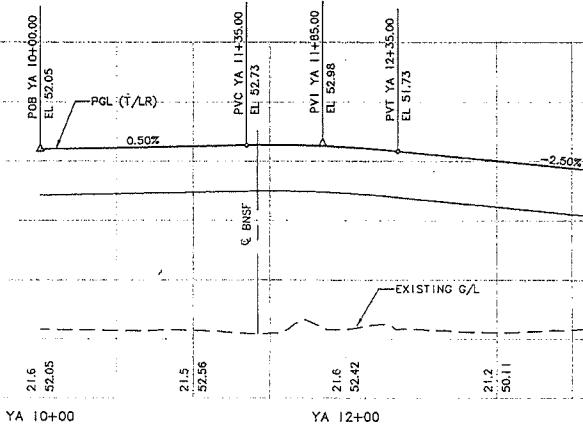

CURVE	YB100
P STA.	YB 32+00.92
R	150.00
Lc	198.16
Ls1	-
Ls2	-
Ea	0.00"
Eu	2.64"
V	10 MPH

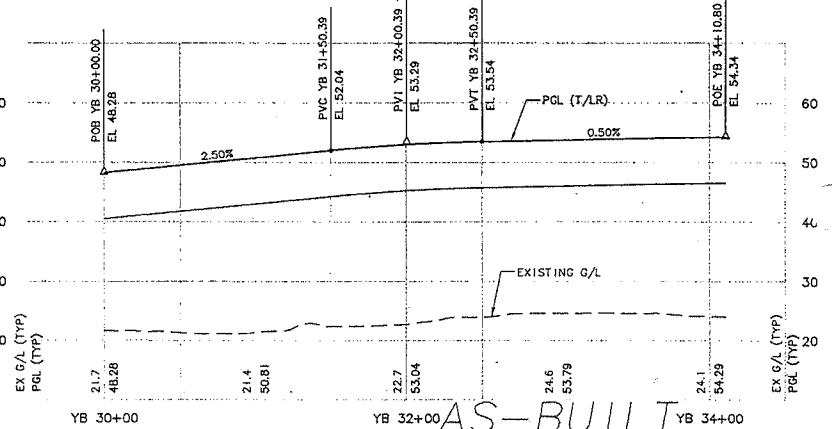

52+00 AS-BUILT

B	10/30/09	BP	JLB AS-BUILT
A	06/17/05	TW	LG IG REVISED TOP OF RAIL PROFILE
O	07/31/03		ISSUED FOR CONSTRUCTION
No.	Date	Doc.	Chk.
			App.
			Revisions

City of Seattle		Designed By: K. LA
Permit No.	Approved:	Drawn By: T. KABO
Y1430	Inspector's Book:	Checked By: C. TOL
	Received:	
	Revised As Built:	Approved By: N. M. TOL
01:		


HUIT-ZOLIAR



LINK LIGHT RAIL PROJECT
SOUTH CORRIDOR


TRACK PLAN & PROFILE
STA YA 10+00 TO STA YA 13+50
STA YB 30+00 TO STA YB 34+10.80

XREFS
 Required
 2G-200
 G01_LX0_5A
 G01_LX0_5B
 HZ-223-GSA
 X01
 X10SF
 X12IRX
 X10F
 Unresolved
 LSCALE
 1=1
 34205
 VAULT SERIAL NO.
 DATE WORK
 NAME
 REVISIONS
 NUMBER OF REVIEWS
 SEE DWG L30-KP10
 10/29/09 14:23:20 ported to ES584

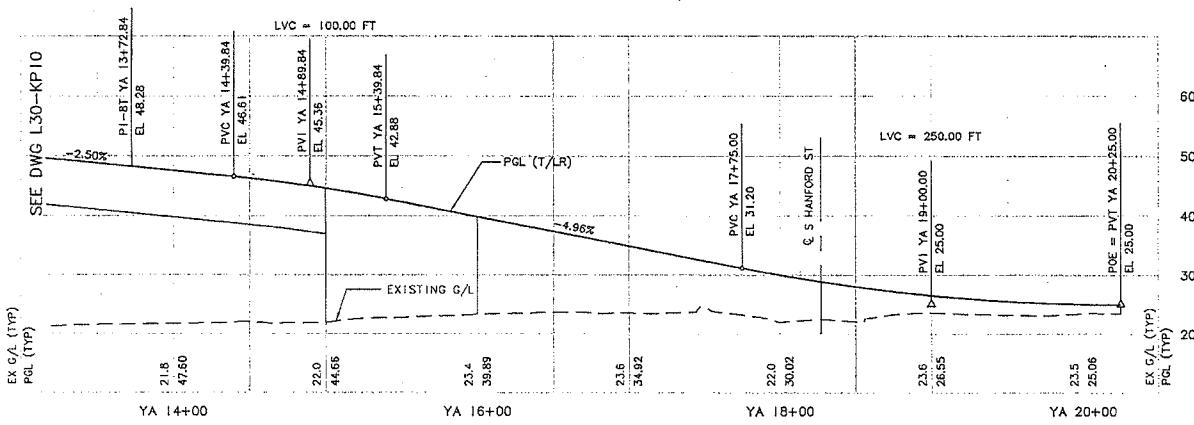

NOTES:

1. SOUTHBOUND TRACK IS CONTROL TRACK, NORTHBOUND TRACK IS NON-CONTROL TRACK AND TOP OF RAIL SHALL EQUAL CONTROL TRACK TOP OF RAIL UNLESS OTHERWISE NOTED. YARD LEAD AND POCKET TRACKS PROFILES ARE INDEPENDENT OF CONTROL TRACK. SEE GENERAL NOTES ON DWG G30-C202.
2. SEE DWG L30-KA01 FOR ADDITIONAL ALIGNMENT DATA.
3. SEE TRACK CHART SERIES L30-KCXX FOR ADDITIONAL TRACKWORK DETAILS.
4. FOR OF FASTENERS AND CONCRETE PLINTH LAYOUT, SEE PLAN SERIES L30-KLXX.
5. SEE TRACKWORK STANDARD DWG KS158 FOR NO. B TURNOUT DIRECT FIXATION DETAILS.

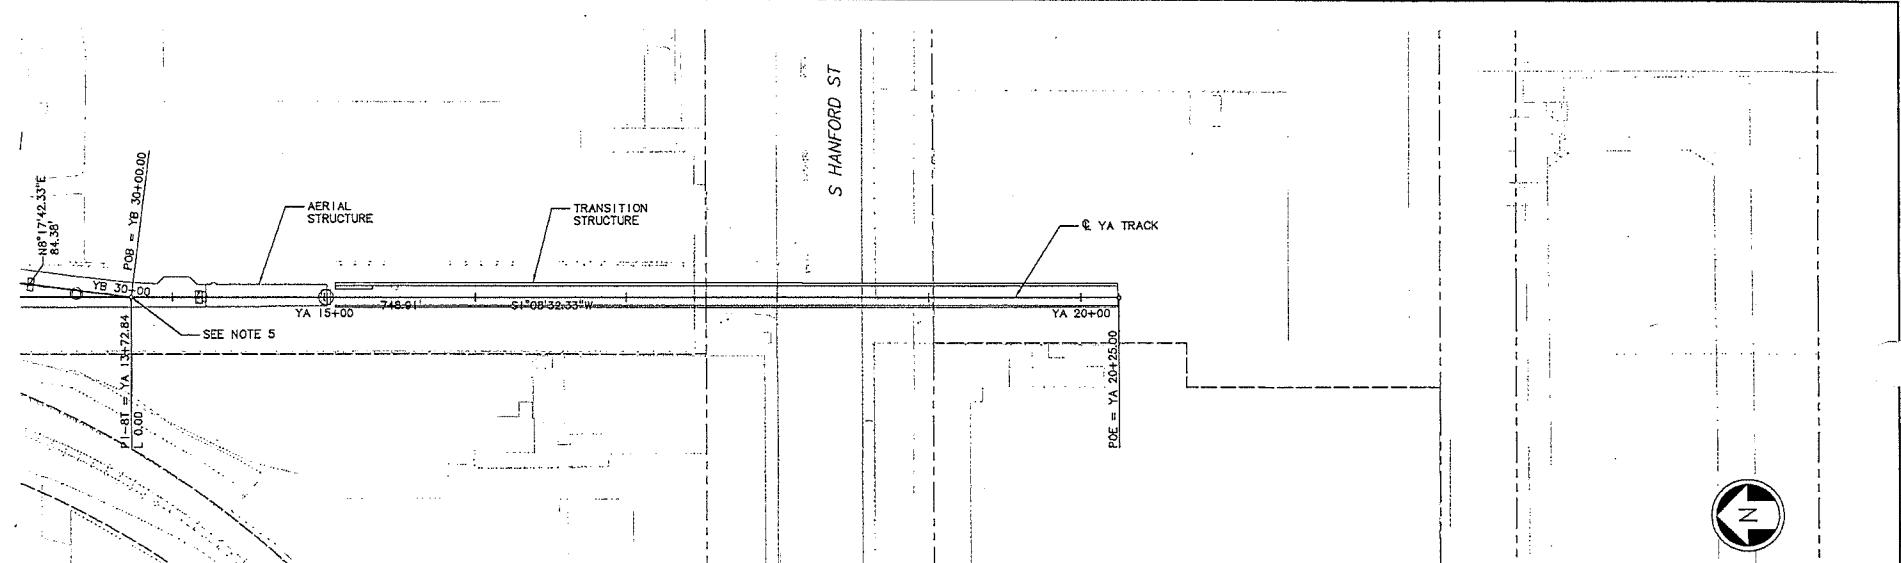

AS-BUILT

B	10/30/09	BP	ULB	AS-BUILT
A	06/17/05	TW	LG	REVISED TOP OF RAIL PROFILE
O	07/31/03			ISSUED FOR CONSTRUCTION
No.	Date	Den.	Chk.	App. Revisions

		City of Seattle		Designed By: K. LAUZEN
Work Order No.		Approved:		Drawn By: T. KABOCHO
Permit No.	Y1430	Inspector's Name:		Received: C. TORRES
Submitted:		Checked By:		Revised As Built: N. MITCHELL
Date:	06/17/05	Date:	06/17/05	Approved By: N. MITCHELL

HUITZ-ZOLARS





LINK LIGHT RAIL PROJECT
SOUTH CORRIDOR
TRACK PLAN & PROFILE
STA YA 13+50 TO STA YA 20+25.00

Drawing No.: L30-KP11
Vault Plan No.: 231-700
Sheet No.: 53
Rev.: B

34205
VULUT NO. DATE MARK
NAME
BUSESSES

C:\work\cjb\c700\c700_cmbuilt.dwg\C05_1-30_KP21.DWG
10/29/09 14:23 : porters DE584

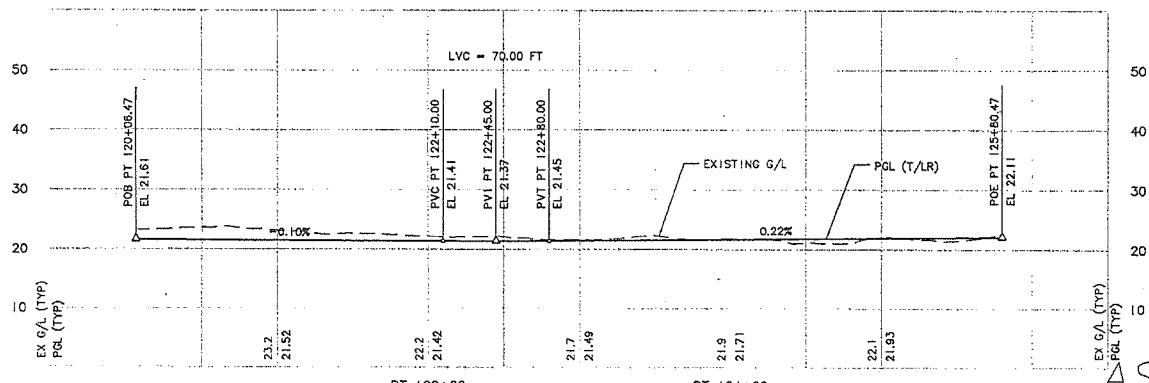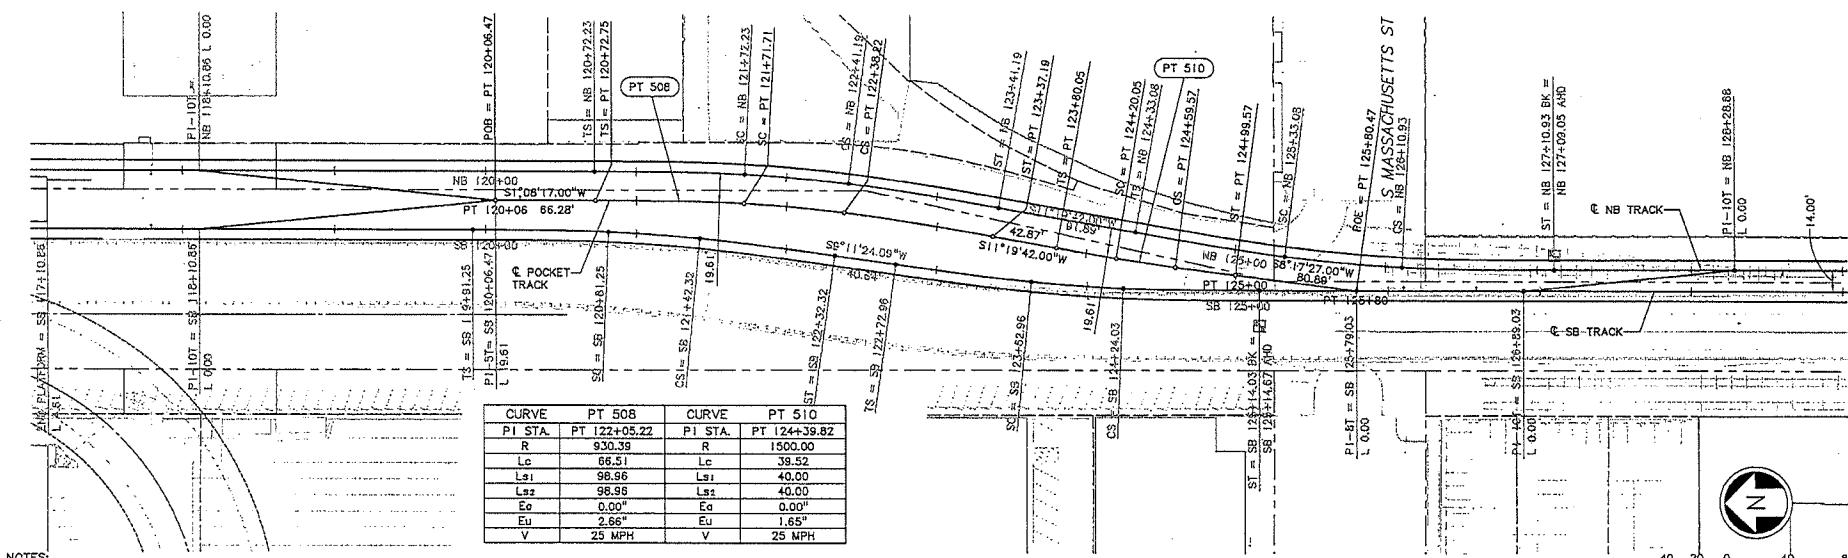

AS-BUILT

City of Seattle

Work Order No. Y1430

Permit No. 07/31/03

Date: 10/30/09 BP: JLB

AS-BUILT

ISSUED FOR CONSTRUCTION

Designed By:
K. LAUZEN

Approved:
B. MCMILLAN

Received:
C. TORRES

Reviewed As Built:
N. MITCHELL

HUITT-ZOLLARS

Inspected's Book:

Received:

Approved:

Approved By:
N. MITCHELL

SOUNDTRANSIT

Contract No.: C 700

Submitted:
N. MITCHELL

Date: 07/31/03

Approved:
K. NG

Date: 07/31/03

Scale:
H: 1"=40'; V: 1"=10'

File Name:
C05_L30_KP21.DWG

Contract No.: C 700

Date: 04/01/02

LINK LIGHT RAIL PROJECT
SOUTH CORRIDOR

Vault Plan No.: 231-700

Sheet No.: 01

Rev: A

STA PT 120+06.47 TO STA PT 125+00.47




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Revised
JULY 2004
2004-07020
2234-05A
C10_V03_SA
C10_V03_SA
2004-07020
S10000
X10000
NP-NIA
Unrevised

LSCALE
1:1


34206 DATE WORK NATURE REASONS
WAT Series No.

- NOTE:
1. SEE STRUCTURE DRAWINGS FOR
TUNNEL, CROSPASSAGE & PORTAL
INFORMATION.
2. FOR NB PROFILE,
SEE DWG NO. L35-KV01

c:\work\c0\l35_kp01.dwg
10/02/04 09:00 : bobjw\06584

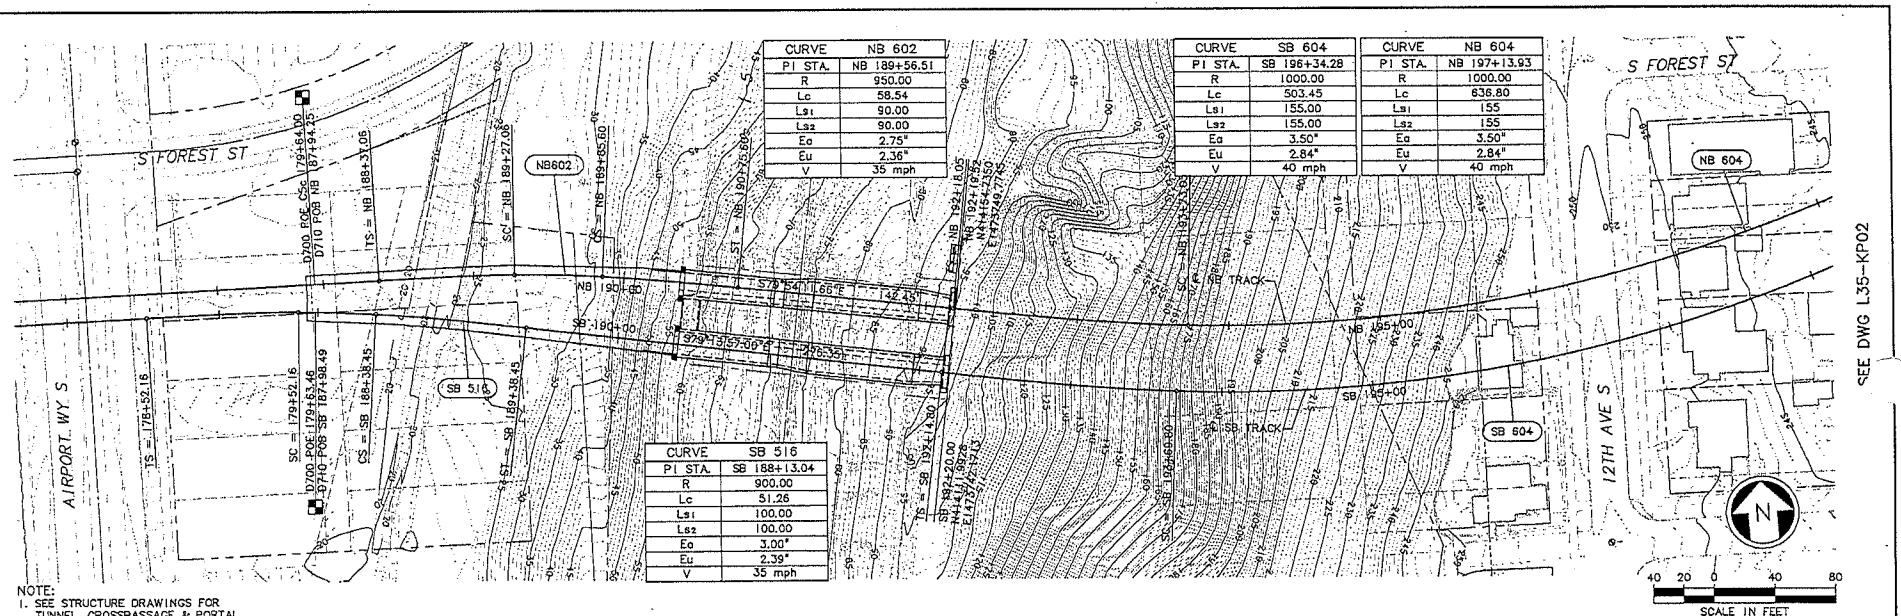

SEE DWG L35-KP02

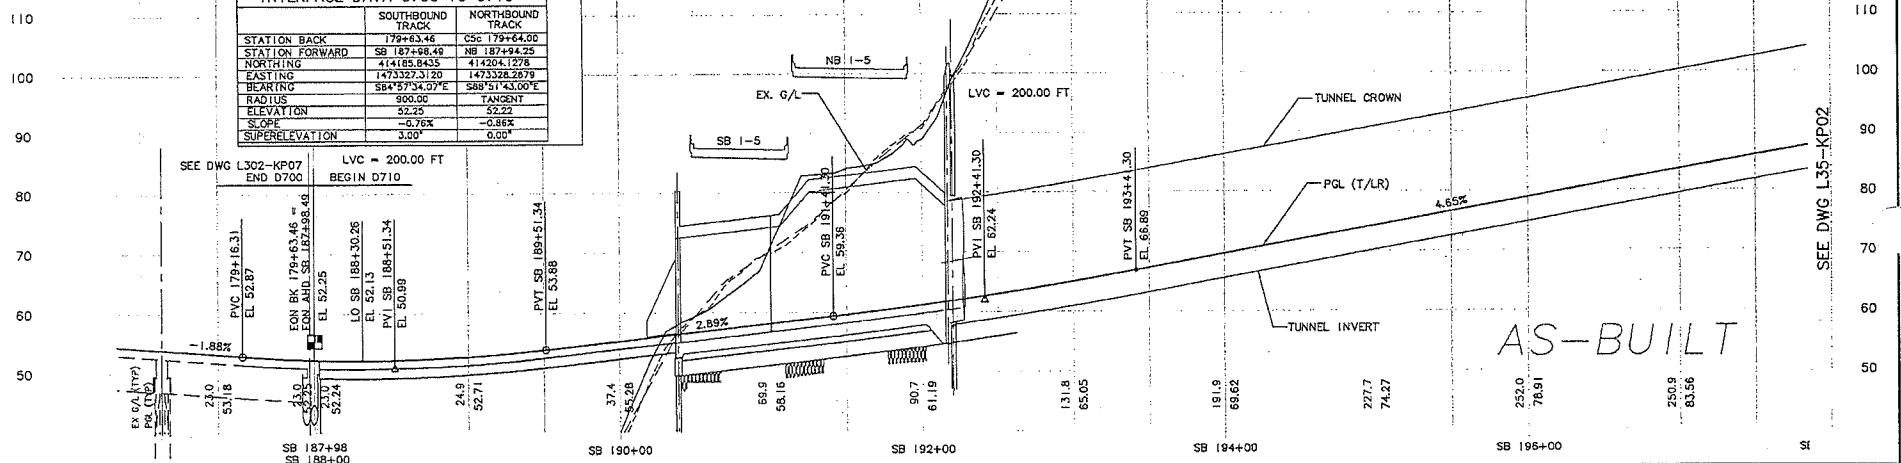

SEE DWG L35-KP02

Designated By:	N. CORNWELL	Drawn By:	R. LAYGO	Submitted:	D. J. PHELPS	Date:	H: 1' = 40', V: 1' = 10'	Drawing No.:
Approved:		Drawn:		PATTERSON & ASSOCIATES, INC.		Date:		L35-KP01
Work Order No.:	Y1431	Inspected's Date:		J.E. JACOBS CIVIL INC.		Approved:		Vault Plan No.:
Panel No.:		Received:		Subcontractor:		Date:		23-710
B	AS-BUILT	Checked By:	N. BARON	SOUNDTRANSIT	Date:	Date:	Date:	Sheet No.:
A	11/01/04 JLB	Revised As Built:			06/28/04	06/28/04	12/15/03	62 Rev. B
O	ASM CO #158	Approved By:	J.L. PATTERSON					
No.	Date:	Chk.	Ang.	Revisions:				

AS-BUILT

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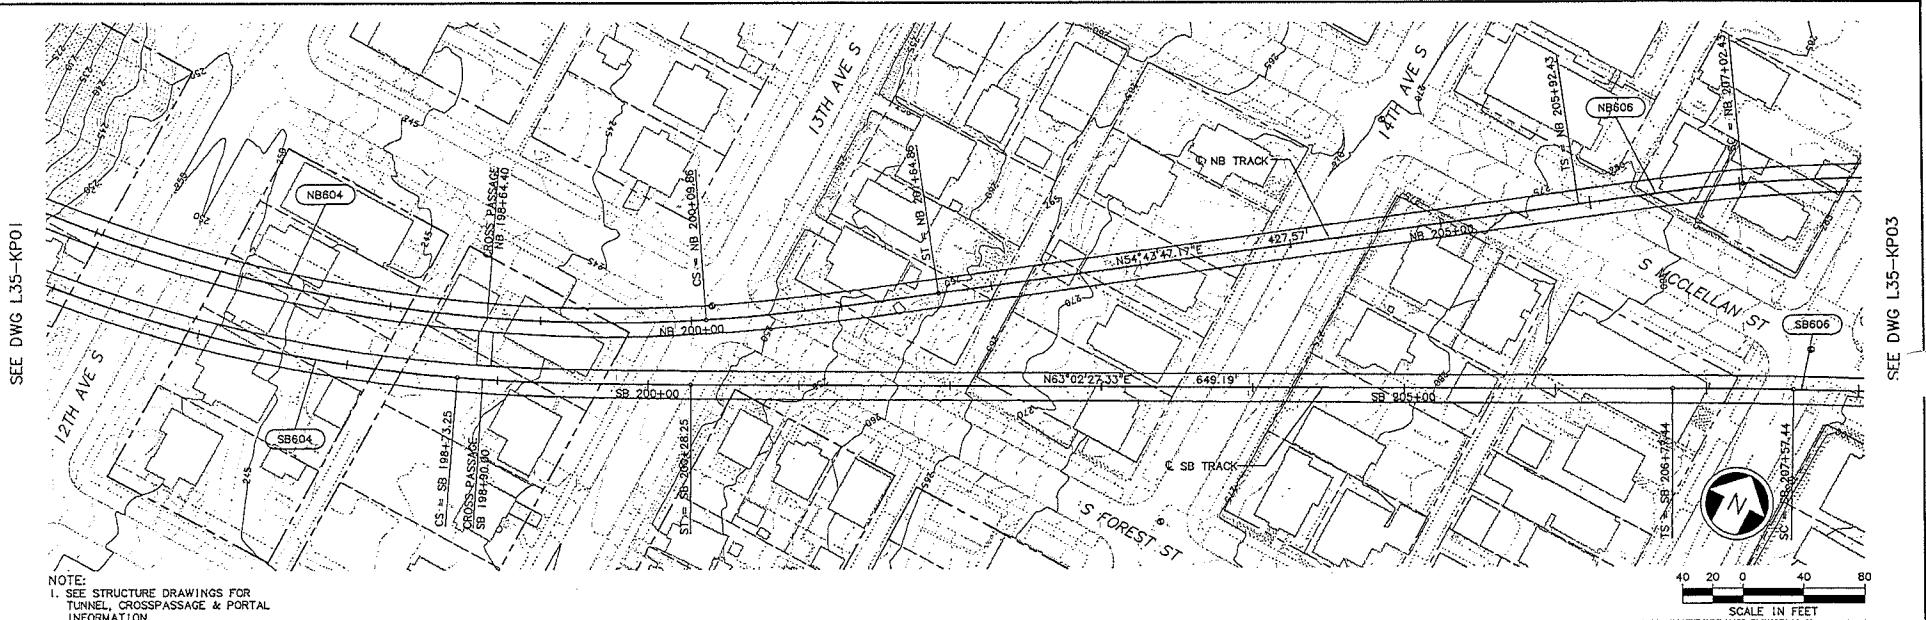
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SEE DWG L35-KP01


SEE DWG L35-KP03

- NOTE:
 1. SEE STRUCTURE DRAWINGS FOR
 TUNNEL CROSSPASSAGE & PORTAL
 INFORMATION.
 2. FOR NB PROFILE SEE DWG. NO. L35-KV01

SCALE IN FEET

SEE DWG L35-KP01

SEE DWG L35-KP03

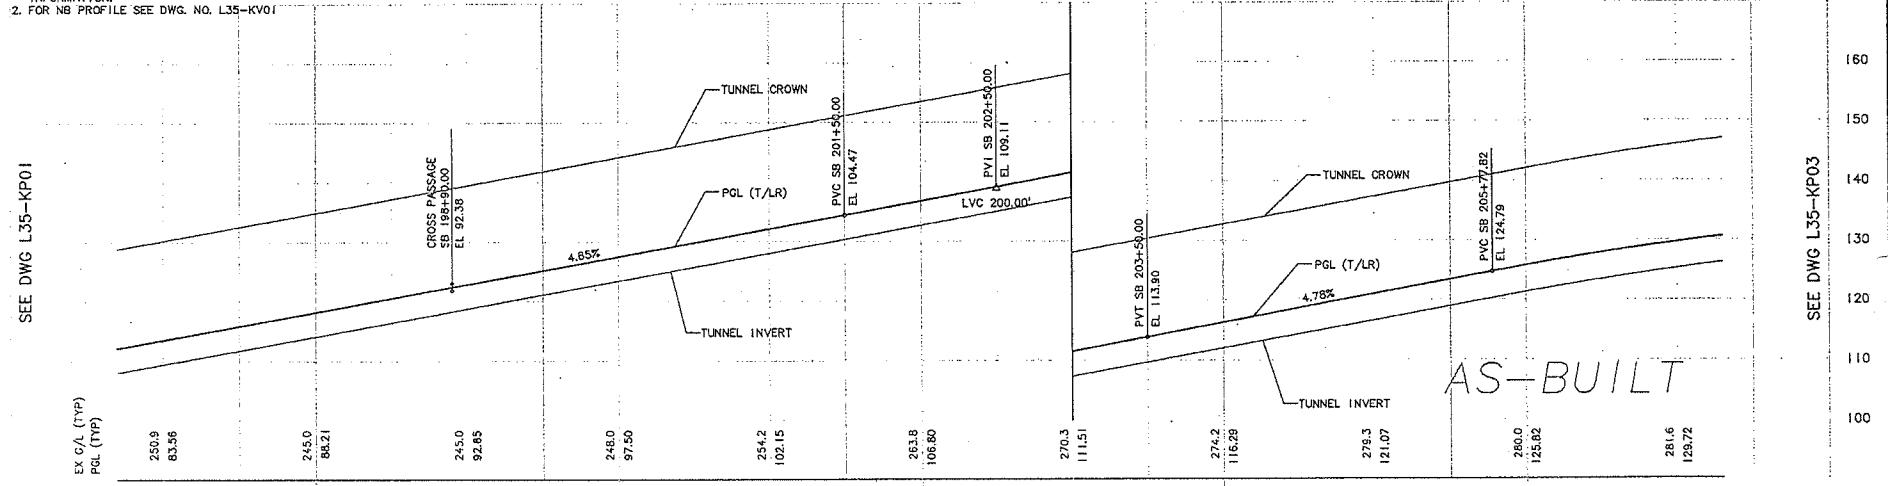

EX C/L (TYP)
PGL (TYP)

250.9

83.56

245.0

85.21

CROSS PASSAGE

SB 198+00

EL 92.38

248.0

97.50

254.2

102.15

261.8

106.80

270.3

111.51

274.2

116.29

280.0

121.07

281.6

125.82

TUNNEL CROWN
PGL (T/LR)
LVC 200.00'
EL 104.47
PVC SB 201+50.00

PVT SB 202+50.00
EL 109.11
TUNNEL CROWN
PGL (T/LR)
TUNNEL INVERT

PVC SB 203+50.00
EL 113.90
TUNNEL CROWN
PGL (T/LR)
TUNNEL INVERT

AS-BUILT

C:\work\CL35-KP02.dwg	06/28/04	06/28/04	06/28/04	06/28/04
C	07/25/07	ILB MC	ASM CO /231	AS-BUILT
B	07/25/07	JLB	ASM CO /158	
A	11/01/06	JG	JLB	
O	06/28/04		ISSUED FOR CONSTRUCTION	SDOT:
No.	Date	Den.	Chk.	App.

City of Seattle

Work Order No.

Permit No.

Received:

Revised As Built:

Approved By:

Designed By:
N. CORNWELL

Drawn By:

R. LAYCO

Checked By:

N. BARON

Approved By:

Hatch Mott
MacDonald

JACOBS

CIVIL INC

PATTERSON & ASSOCIATES, INC.

STRUCTURAL ENGINEERS

Submitted: D. J. PHELPS

Date: 06/28/04

Approved: D. McALLISTER

Date: 06/28/04

Date: 12/15/03

Scope:
H: I"=40", V: I"=10"

Filename:

C10_L35_KP02.dwg

Contract No.:

C 710

Date:

SOUNDTRANSIT

Link Light Rail Project

South Corridor

Beacon Hill Tunnel

Track Plan & Southbound Profile

STA SB 197+00 TO STA SB 207+00


Drawing No.: L35-KP02

Vault Plan No.: 231-710

Sheet No.: 63

Rev'd: C



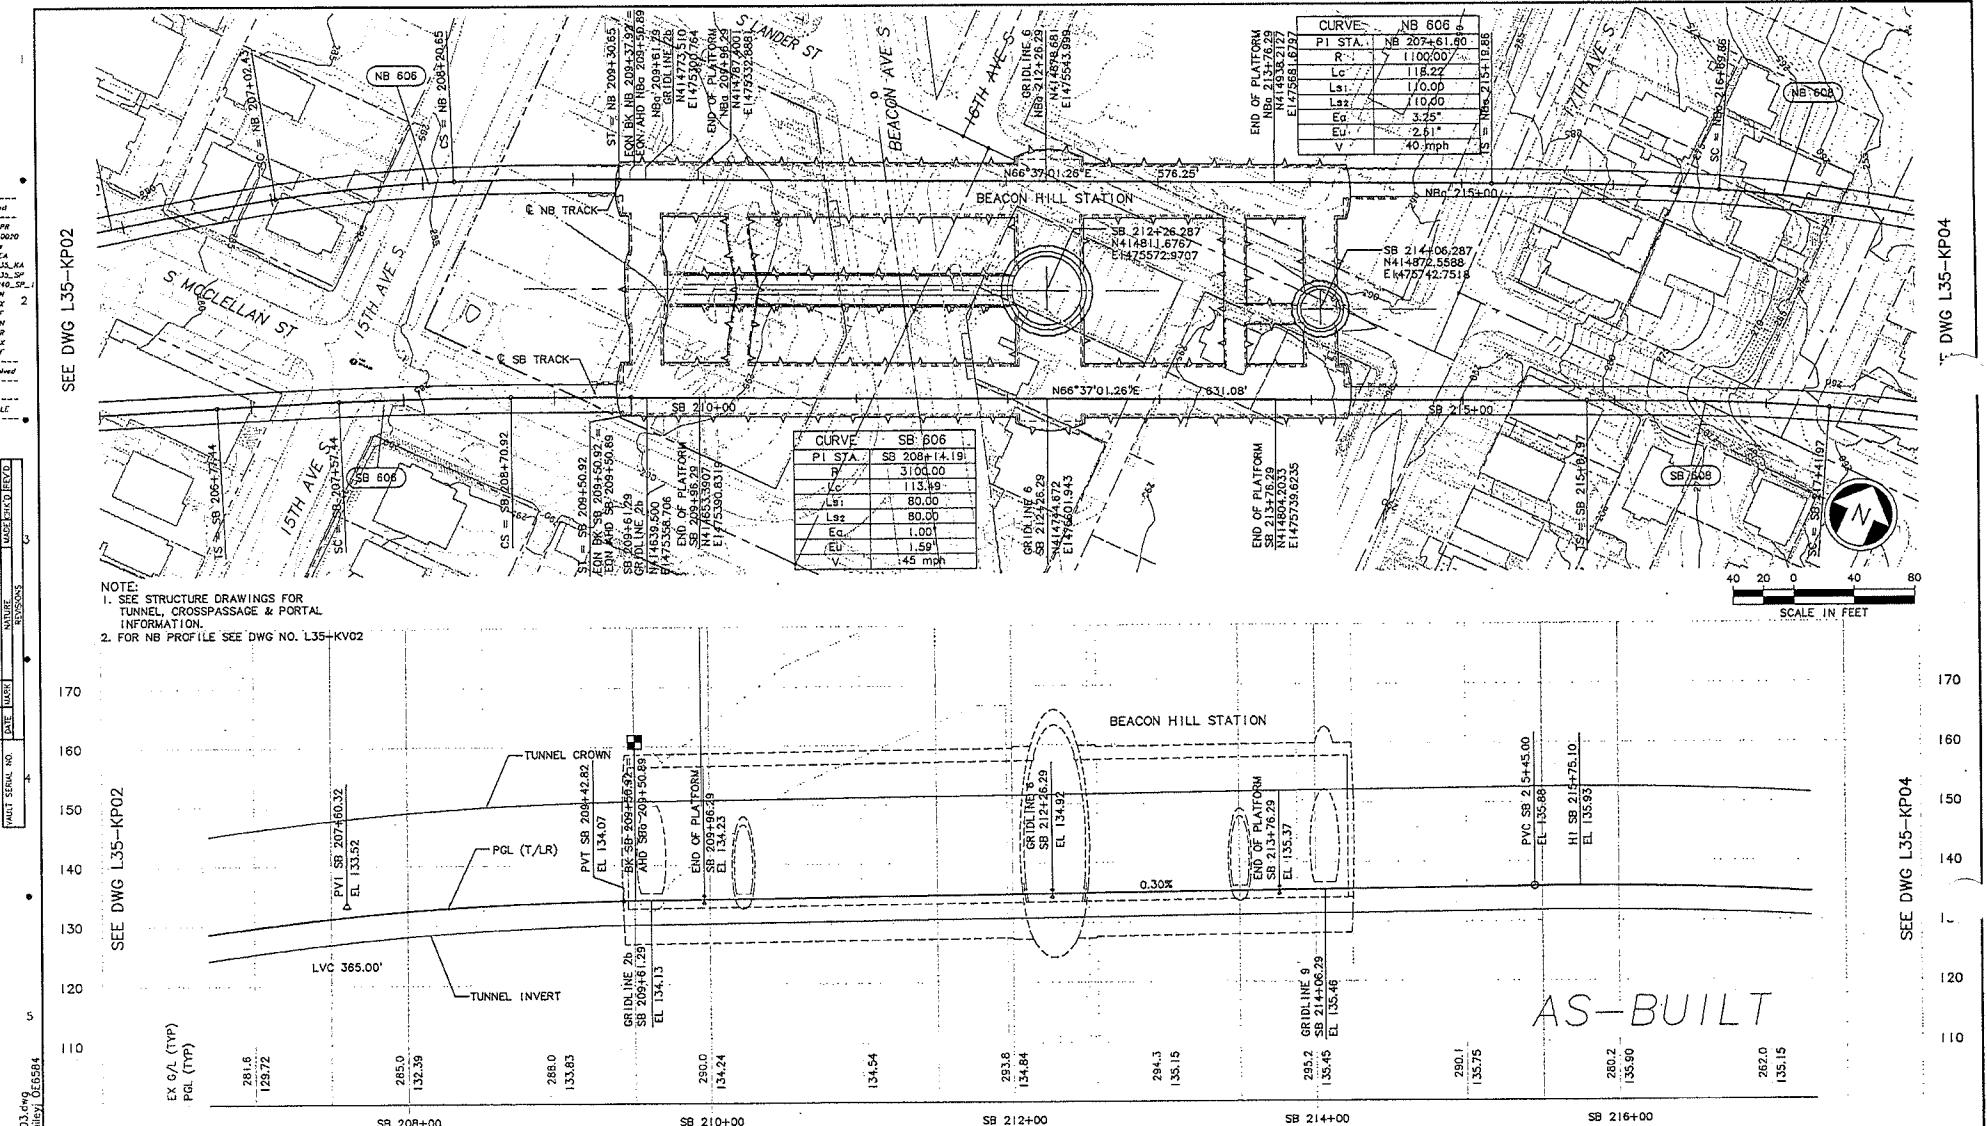

C					AS-BUILT		P
B	07/26/07	JLB	MC	ASM	CO #231		P
A	11/01/06	JLG	JLB	ASM	CO #158		
D	06/28/04				ISSUED FOR CONSTRUCTION		S
N	Date	Perf.	Chk.	Am.	Designation		

City of Seattle

City of Seattle

Work Order No. Approved: _____

RECEIVED NO. 11431 INSPECTOR'S BOOK

Revised As Built:

DOT:

N. CORNWELL
Dinner, Bar

Drawn By: B. LAYGO

Checked By:

N. BARON

Approved By:

 Hatch Mot
MacDonald

 JE JACOBS
CIVIL INC

Submitted:

PATTERSON
&
ASSOCIATES, INC.
CHAMPAIGN SPRINGS

Date: Approved:
06/28/04 D. McALLISTER

Scale:
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Filename:
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Contract No.: S-312

Date: 12/15/03


**LINK LIGHT RAIL PROJECT
SOUTH CORRIDOR
BEACON HILL TUNNEL**

STA SB 207+00 TO STA SB 217+00

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	L35-KP03
	Vault Plan No.
	231-710
	Sheet No. Rev.:

64 C


SEE DWG L35-KP03

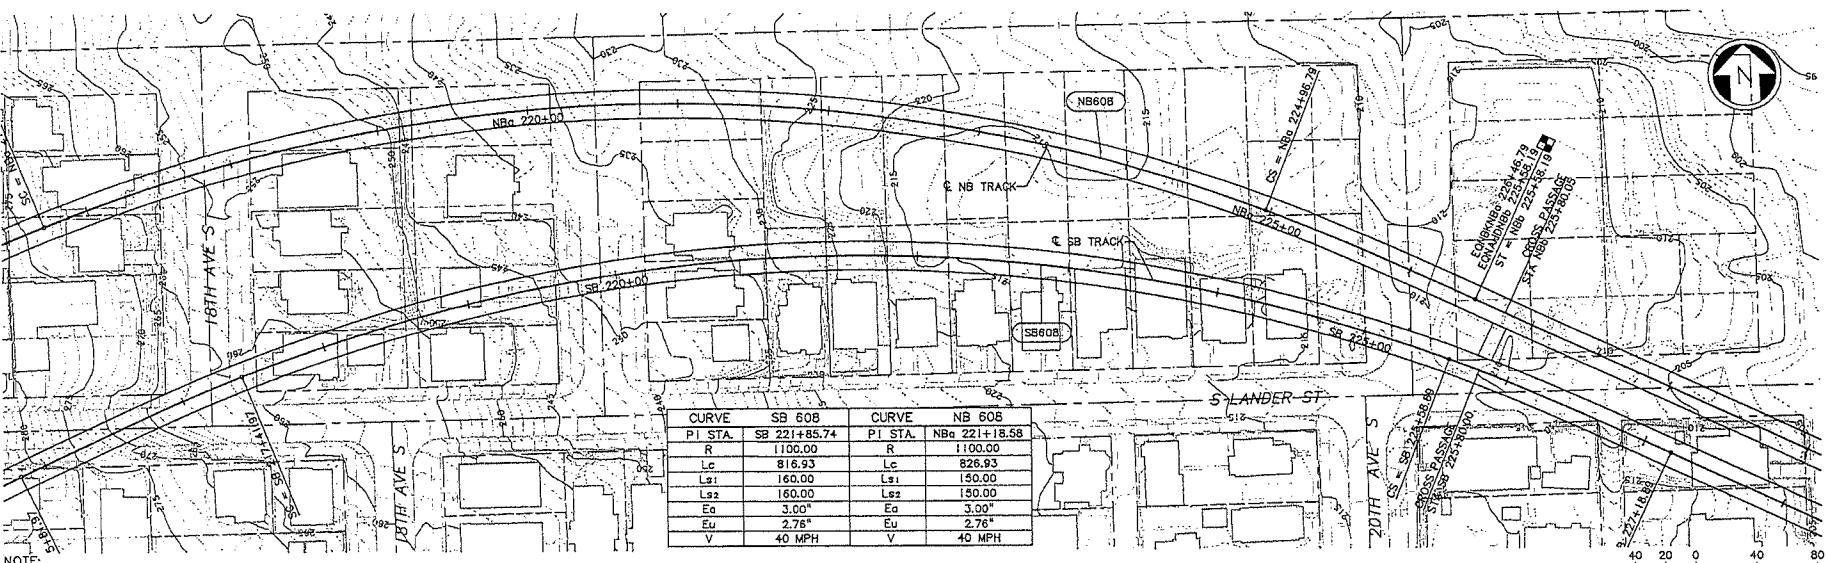

- NOTE:
 1. SEE STRUCTURE DRAWINGS FOR
 TUNNEL, CROSSPASSAGE & PORTAL
 INFORMATION.
 2. FOR NB PROFILE SEE DWG. NO. L35-KV02

34206
WALK SPAN NO.
DATE WORK
NOTICE
ENDORS
MADE TO SPANNED
C

SEE DWG L35-KP03

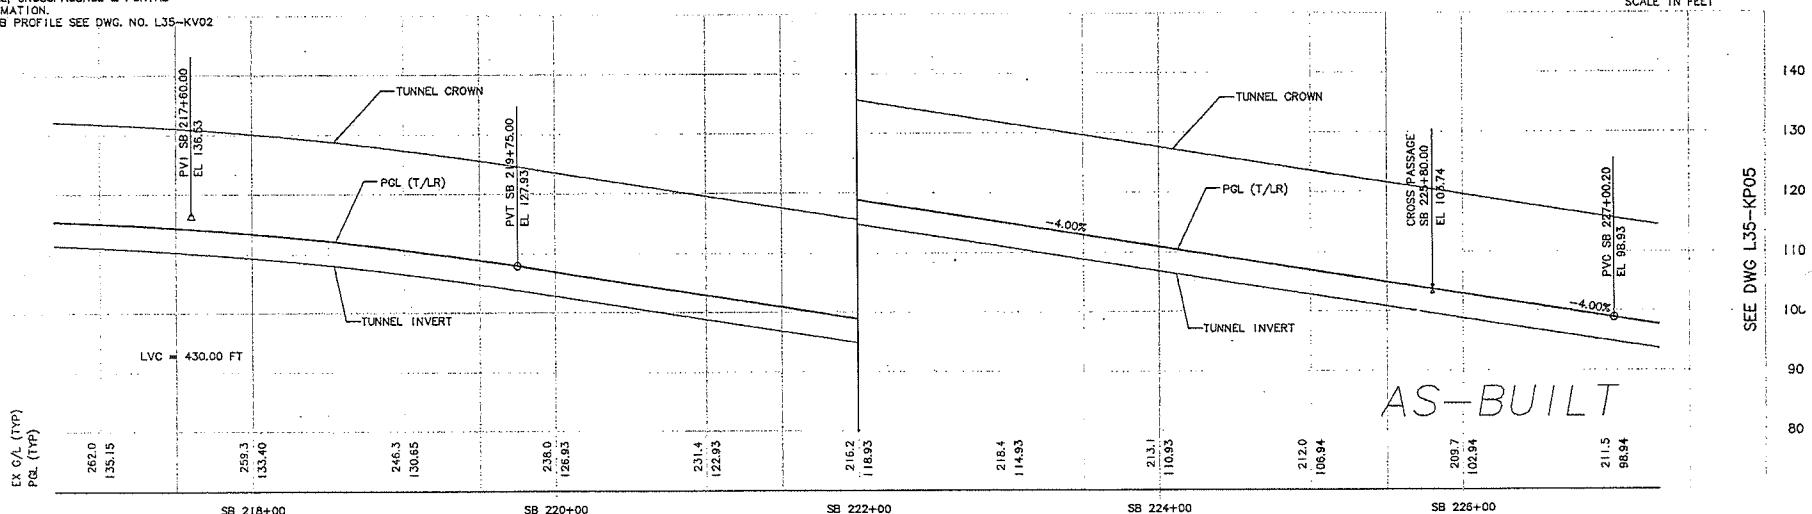

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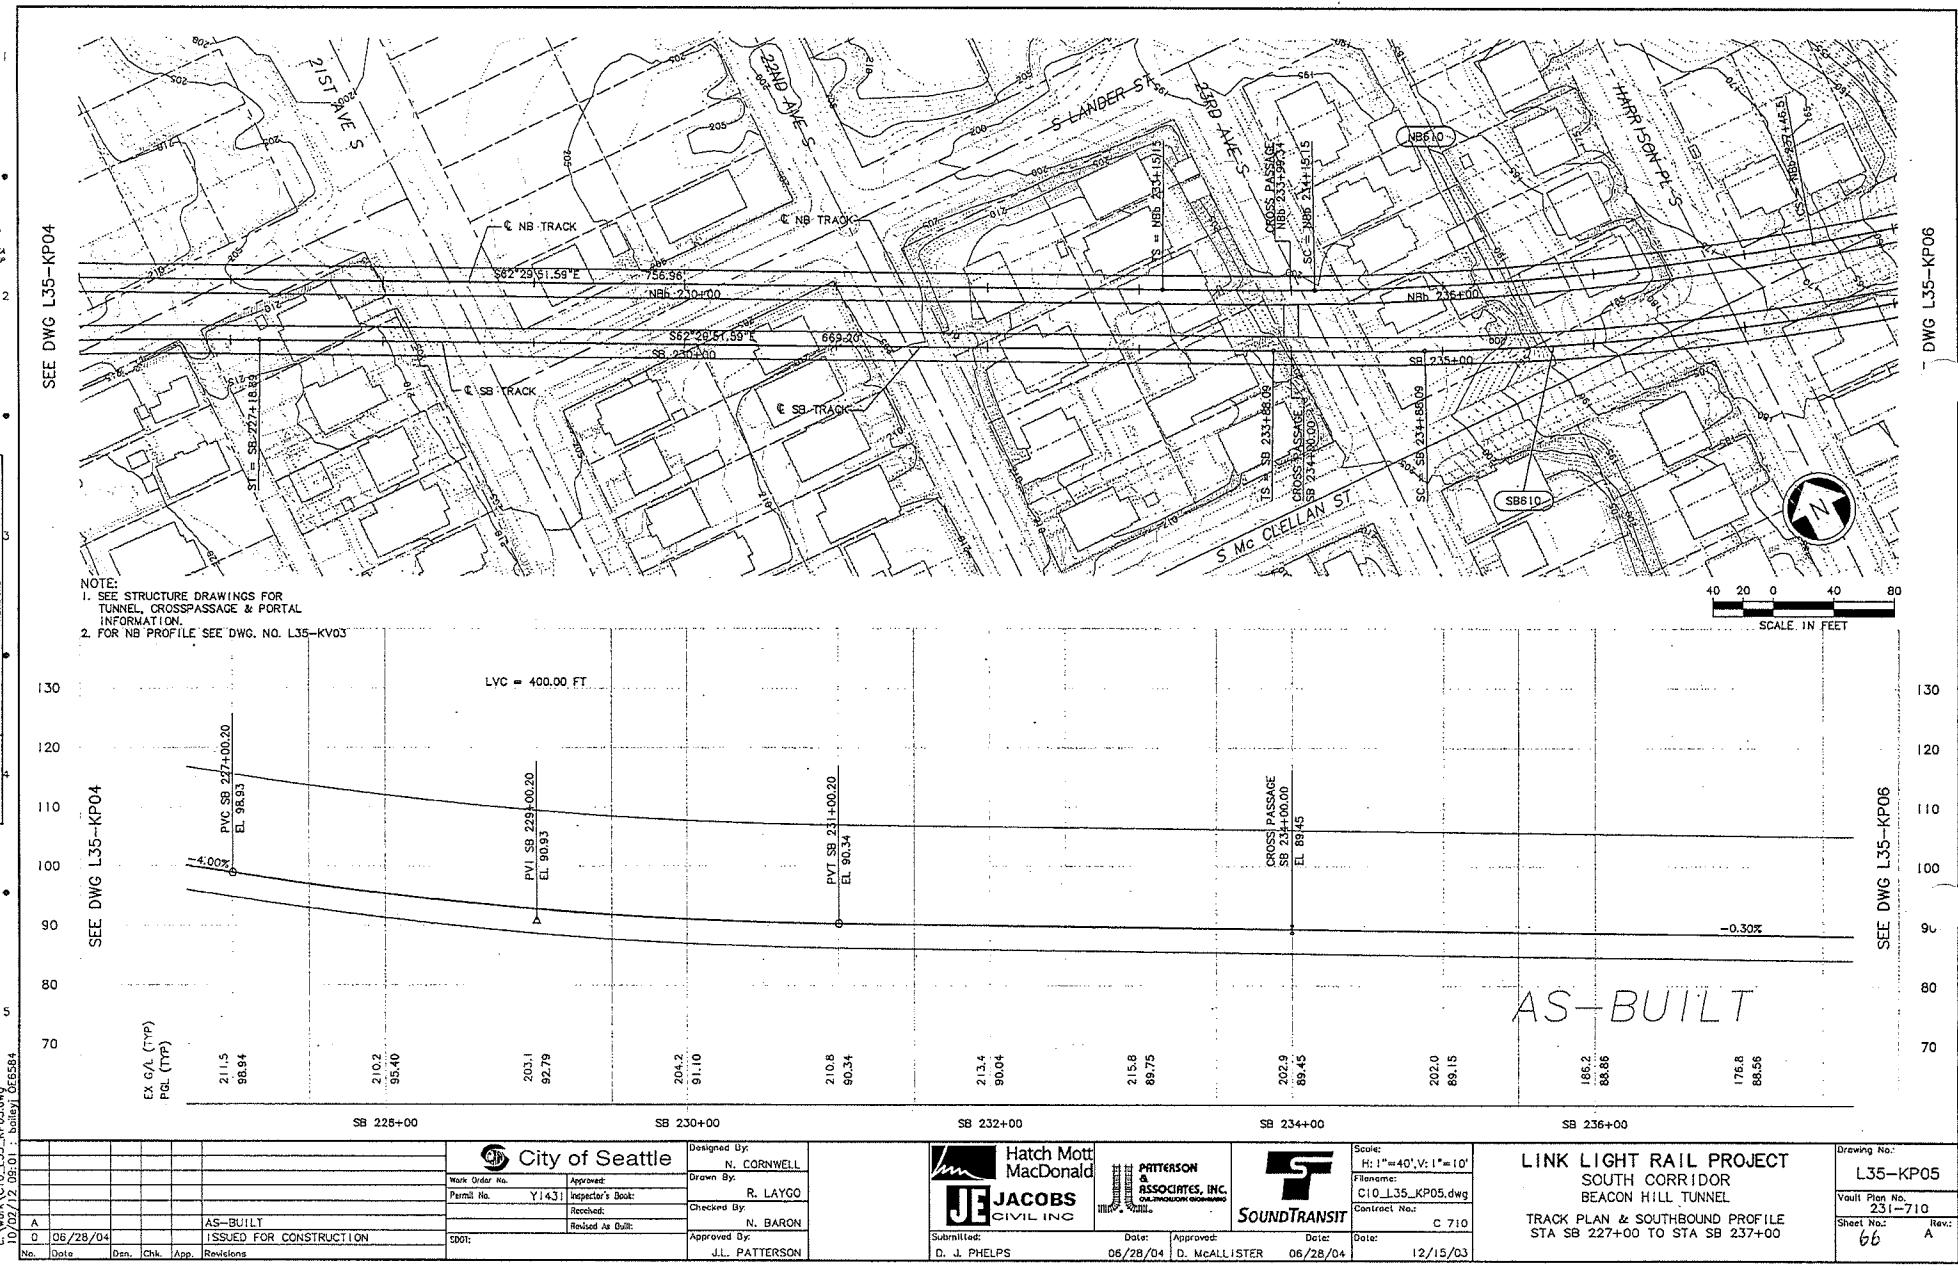
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NOTE: 1. SEE STRUCTURE DRAWINGS FOR TUNNEL CROSSPASSAGE & PORTAL INFORMATION.

2. FOR NB PROFILE, SEE DWG No. L35-KP03

34206
VALS. SERIAL NO.
SEE DWG L35-KP05

EX G/L (TYP)
PGL (TYP)

176.8

88.55

SB 238+00

155.5

87.97

SB 240+00

141.8

87.67

109.3

87.37

104.4

87.05


85.6

85.81

SB 244+00

SB 246+00

AS-BUILT

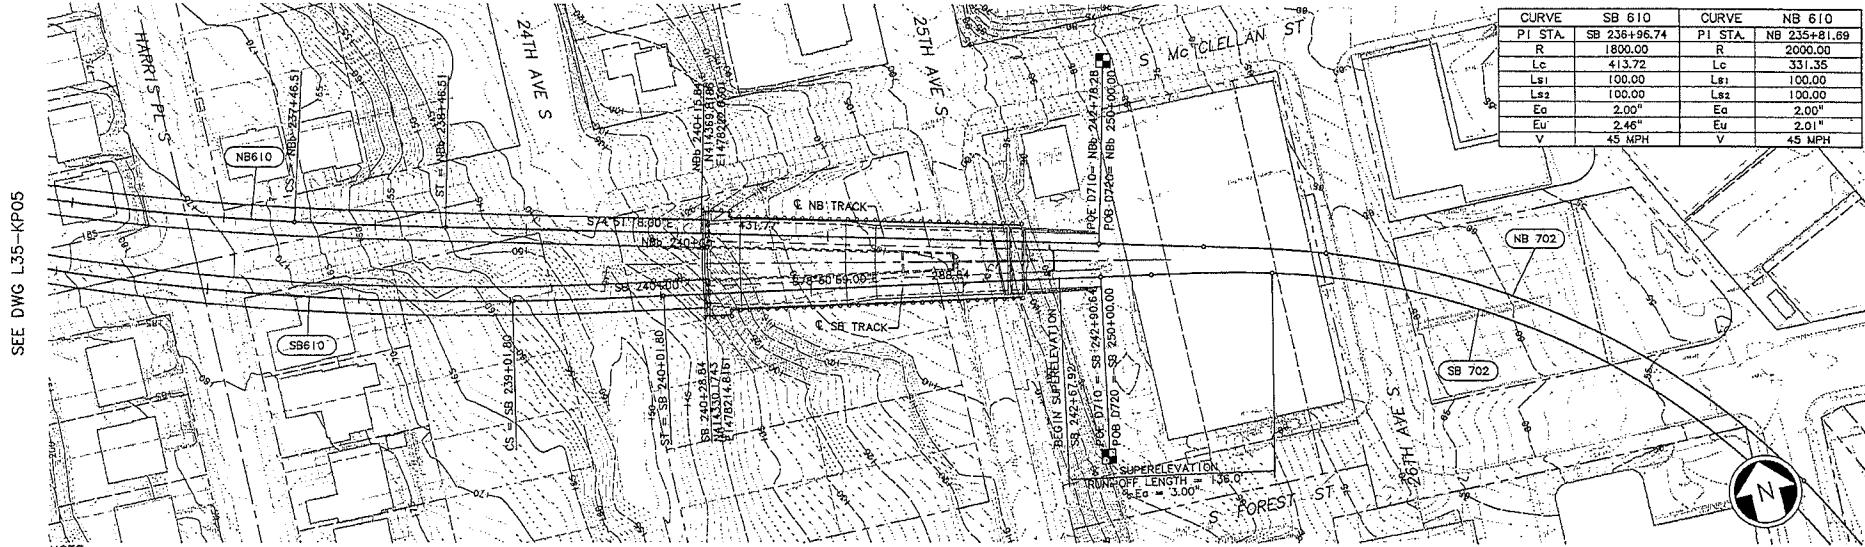

SEE DWG L35-KP05

INTERFACE DATA C710 TO C720

	SOUTHBOUND TRACK	NORTHBOUND TRACK
STATION BACK	SB 242+90.64	Nb 242+78.28
STATION FORWARD	SB 250+00.00	NB 250+00.00
NORTHING	414271.5462	414301.2529
EASTING	1478471.6762	1478475.9547
BEARING	S78°50'59.00"E	S74°51'18.00"E
RADIUS	TANGENT TRACK	TANGENT TRACK
ELEVATION	86.81	86.81
SLOPE	-0.30%	-0.30%
SUPERELEVATION	0.50"	0.00"

c:\work\c10.l35.kp06.dwg : billywi 06584

10/22/12 09:02

City of Seattle

Designed By:
N. CORNWELL

Drawn By:
R. LAYCO

Checked By:
N. BARON

Approved By:
J.L. PATTERSON

Hatch Mott
MacDonald

PATTERSON
& ASSOCIATES, INC.

JACOBS
CIVIL INC

SOUNDTRANSIT

Scale:
H: 1" = 40', V: 1" = 10'

Filename:
C10_L35_KP06.dwg

Contract No.:
C 710

LINK LIGHT RAIL PROJECT
SOUTH CORRIDOR
BEACON HILL TUNNEL

Drawing No.:
L35-KP06

Vault Plan No.:
231-710

TRACK PLAN & SOUTHBOUND PROFILE
STA SB 237+00 TO STA SB 242+90.64

Show No.:
67

Rev.:
A

No.

Date

Desn.

Chk.

App.

Revisions

06/28/04

AS-BUILT

ISSUED FOR CONSTRUCTION

SOCH:

J.L. PATTERSON

06/28/04

D. McALLISTER

06/28/04

12/15/03

I.D.

10/22/12 09:02

BILL OF MATERIALS

ITEM

QTY

DESCRIPTION


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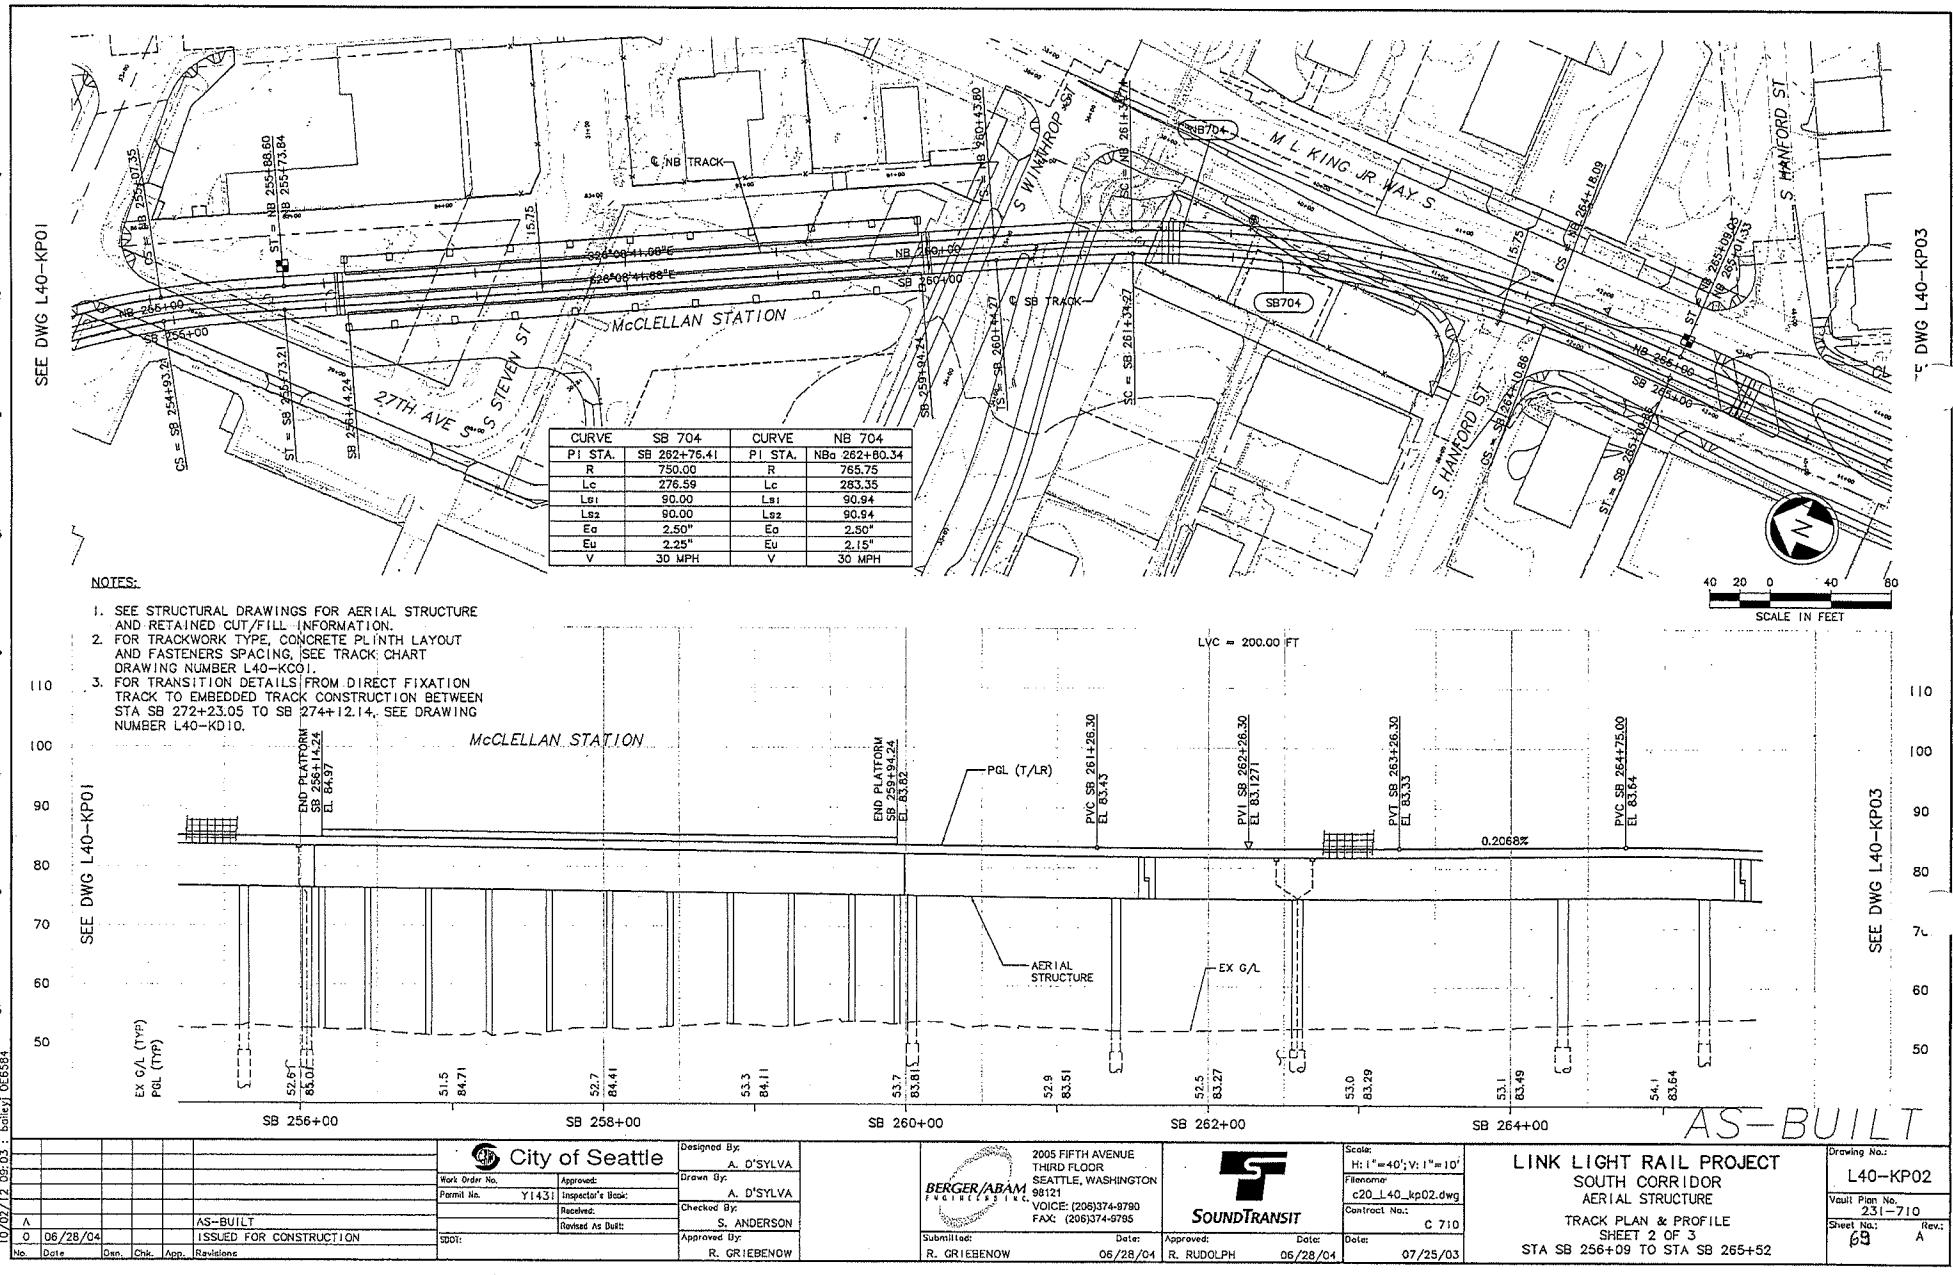
AMOUNT

ITEM


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DESCRIPTION




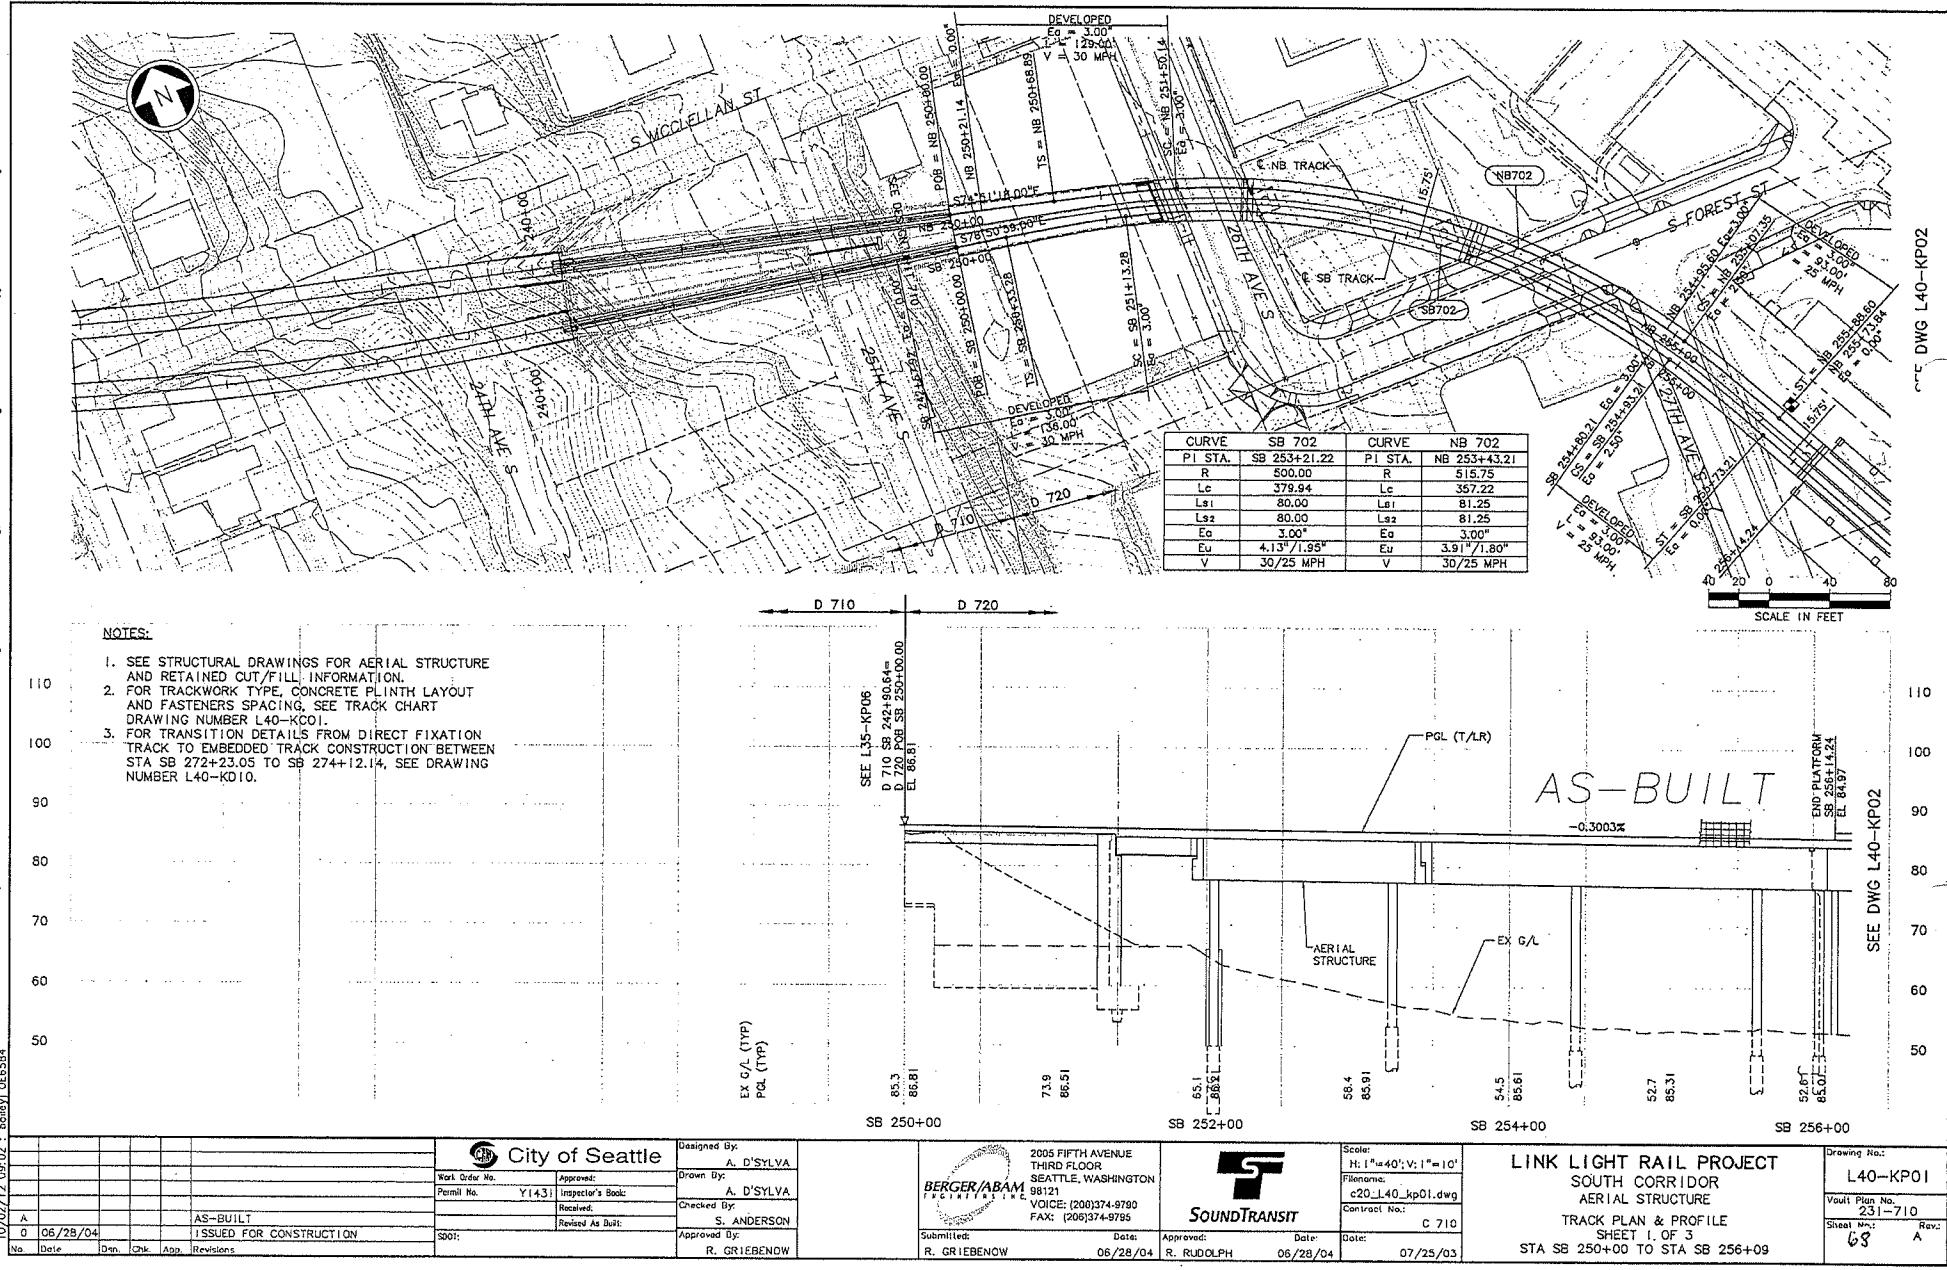

SEE DWG L40-KP02

SCALE IN FEET
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SEE DWG L40-KP02

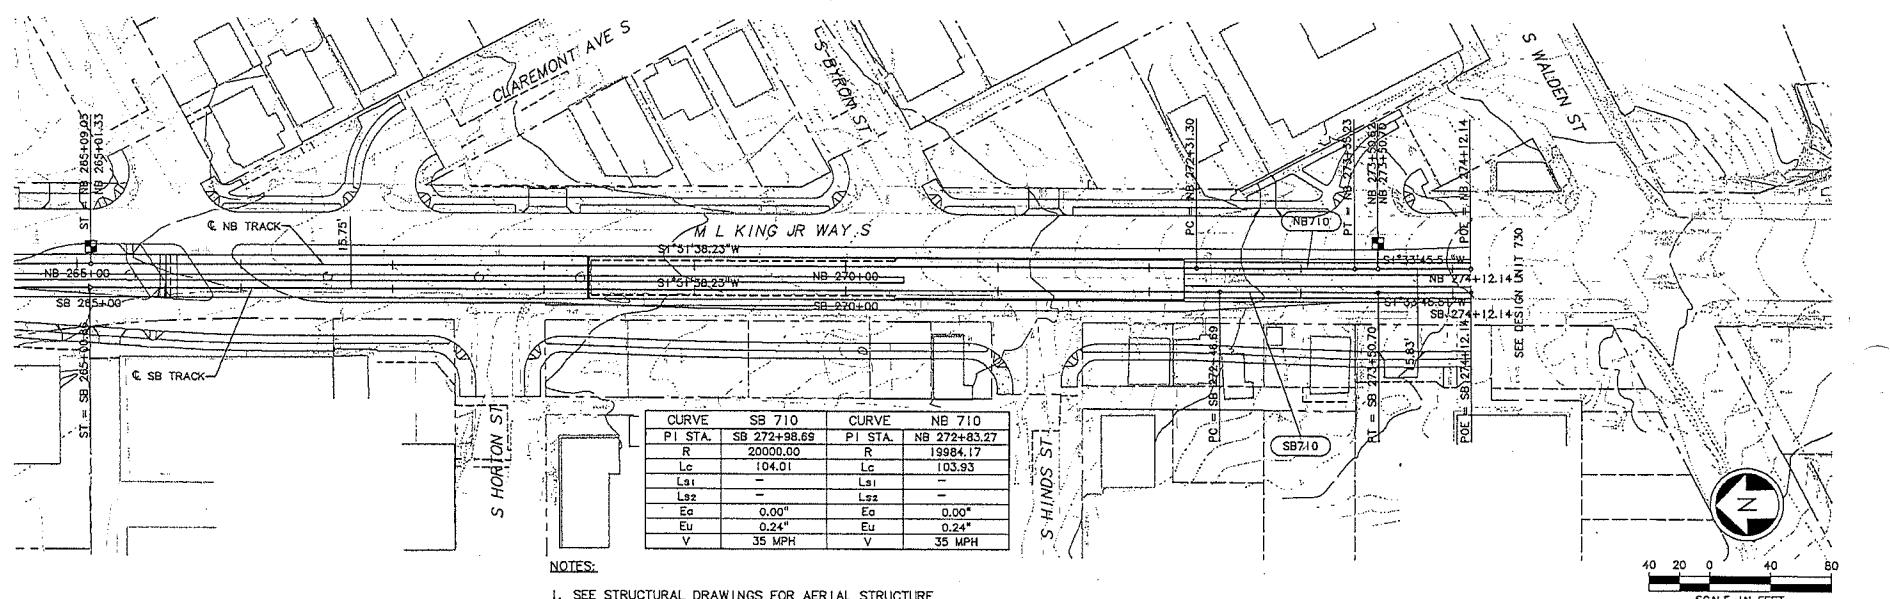

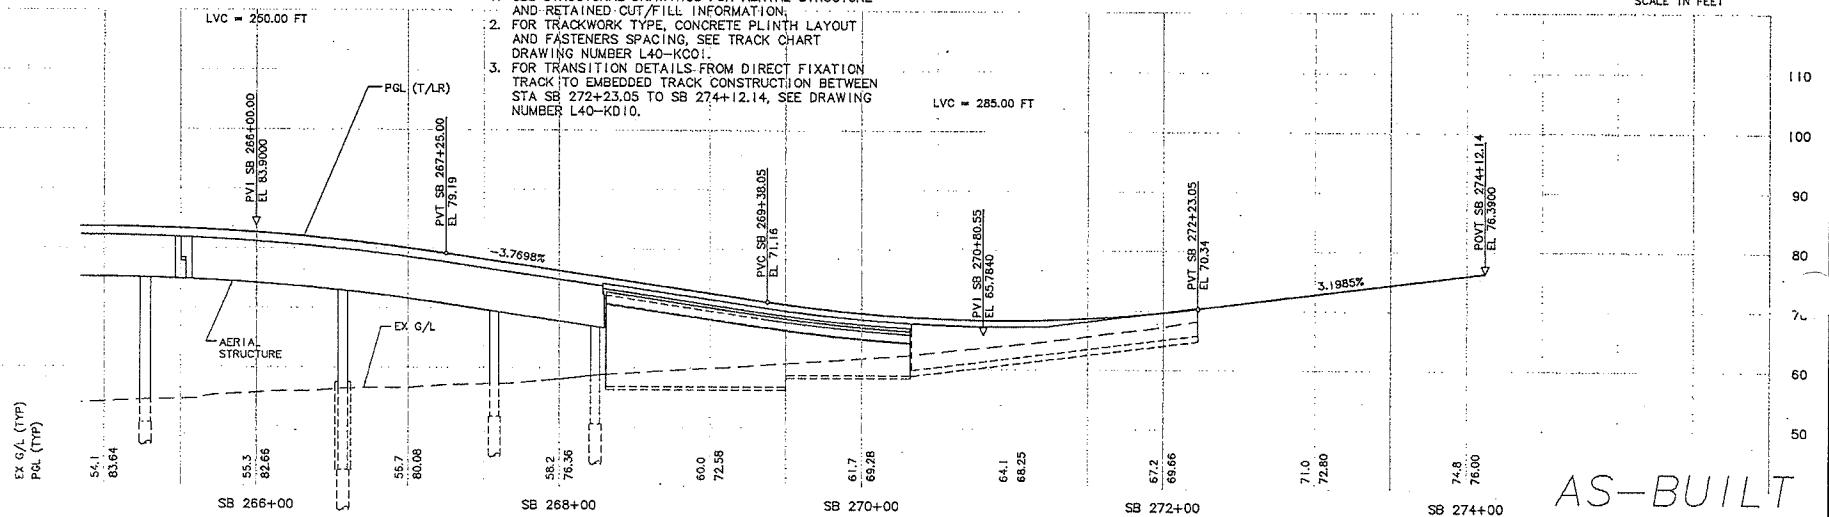AS-BUILT

c:\work\c20_l40_kp03.dwg 05

05/01 : build 06594

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City of Seattle

Work Order No.

Permit No.

Inspector's Book

Received:

Checked By:

Revised As Built:

Approved By:

R. GRIEBENOW

Designed By:

A. D'SYLVIA

Drawn By:

A. D'SYLVIA

Submitted:

R. GRIEBENOW

Date:

05/28/04

Approved:

R. RUDOLPH

Date:

05/28/04

Date:

07/25/03

BERGER/ABAM
ENGINEERS
2005 FIFTH AVENUE
THIRD FLOOR
SEATTLE, WASHINGTON
98121
VOICE: (206)374-9750
FAX: (206)374-9755

SOUNDTRANSIT

C 710

Scale:
H: 1"=40'; V: 1"=10'Plan View:
c20_l40_kp03.dwg

Contract No.:

07/25/03

LINK LIGHT RAIL PROJECT
SOUTH CORRIDOR
AERIAL STRUCTURE

TRACK PLAN & PROFILE

SHEET 3 OF 3

STA SB 265+52 TO STA SB 274+12.14

Drawing No.:

L40-KP03

Vault Plan No.:

231-710


Sheet No.:

70

Rev.:

A



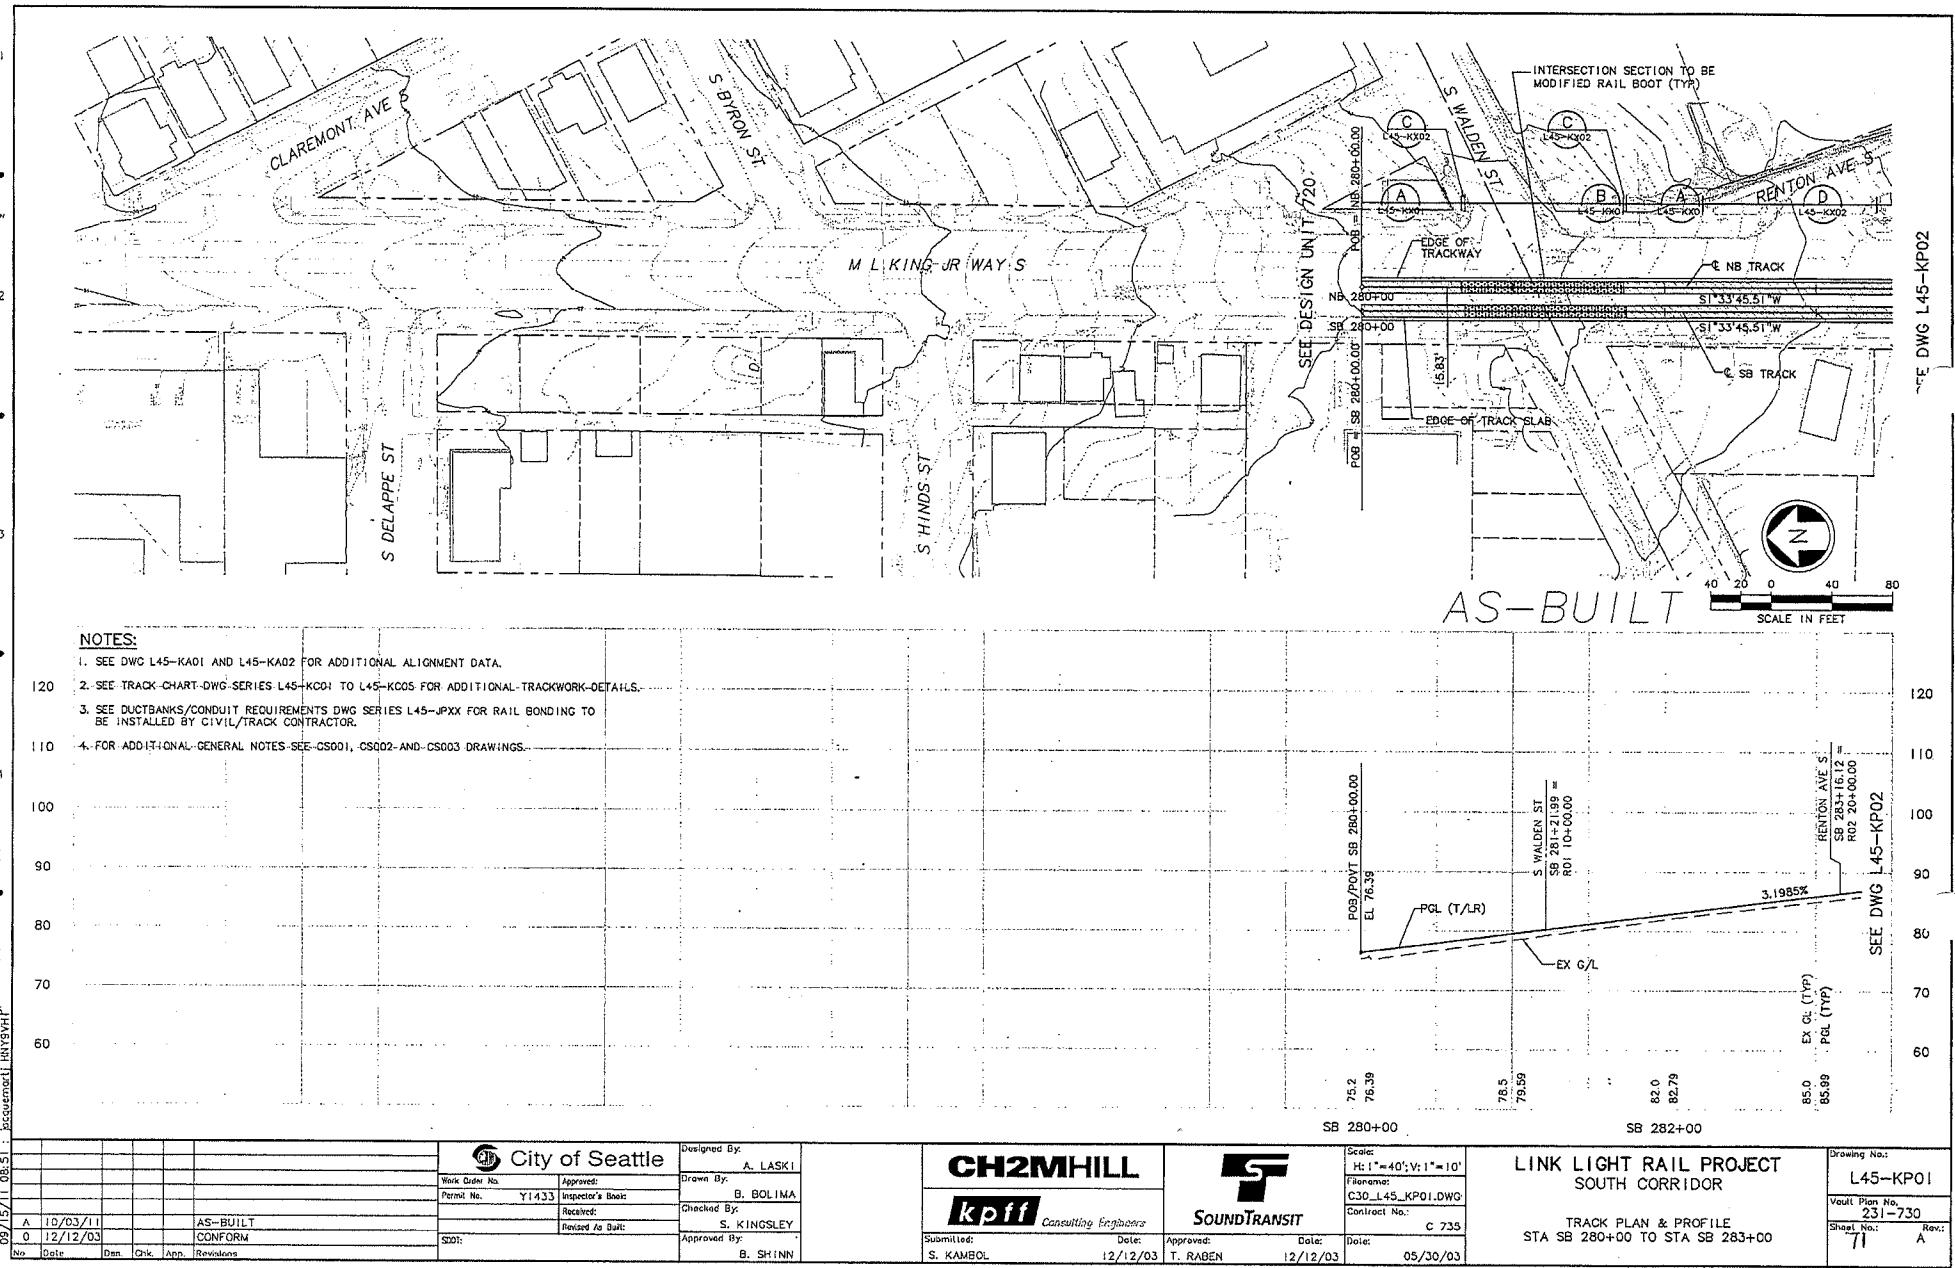

34208
FAULT SERIAL NO.
LAS. KEEBLING

DATA INDEX
LISCALE,
1-1

SHELL
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TG-G20020
-Dusties
C30_I45_RA
C30_R07_RA
C30_R09_RA
C30_R11_RA
X116CN
X116CR
X116FR
X116SF
X118CN
X118CR
X118FX
X118SF
ZG-2234SEARCH
-Unaligned
SI NAMES_C

SEE DWG L45-KP02

SEE DWG L45-KP02

23

CURVE	SB 604	CURVE	NB 804
P.I. STA.	SB 294+19.72	P.I. STA.	NB 294+20.11
R	4000.00	R	4016.00
Lc	73.23	Lc	155.17
Lb1	141.09	Ls1	60.00
Lb2	141.09	Ls2	60.00
Eg	0.25"	Eg	0.25"
Eu	0.98"	Eu	0.98"
V	35 MPH	V	35 MPH


CURVE	SB 806	CURVE	NB 806
P STA.	SB 301+00.44	P STA.	NB 300+96.82
R	1216.00	R	1200.00
Lc	466.61	Lc	433.53
Ls1	80.00	Ls1	105.89
Ls2	80.00	Ls2	105.89
Eg	2.00"	Eg	2.00"
Eu	1.99"	Eu	2.04"
V	35 MPH	V	35 MPH

卷之三

AS-BUILT

20 0 40

CONSTRUCT NB TRACK BASED ON NB PROFILE - SEE L45-KYC

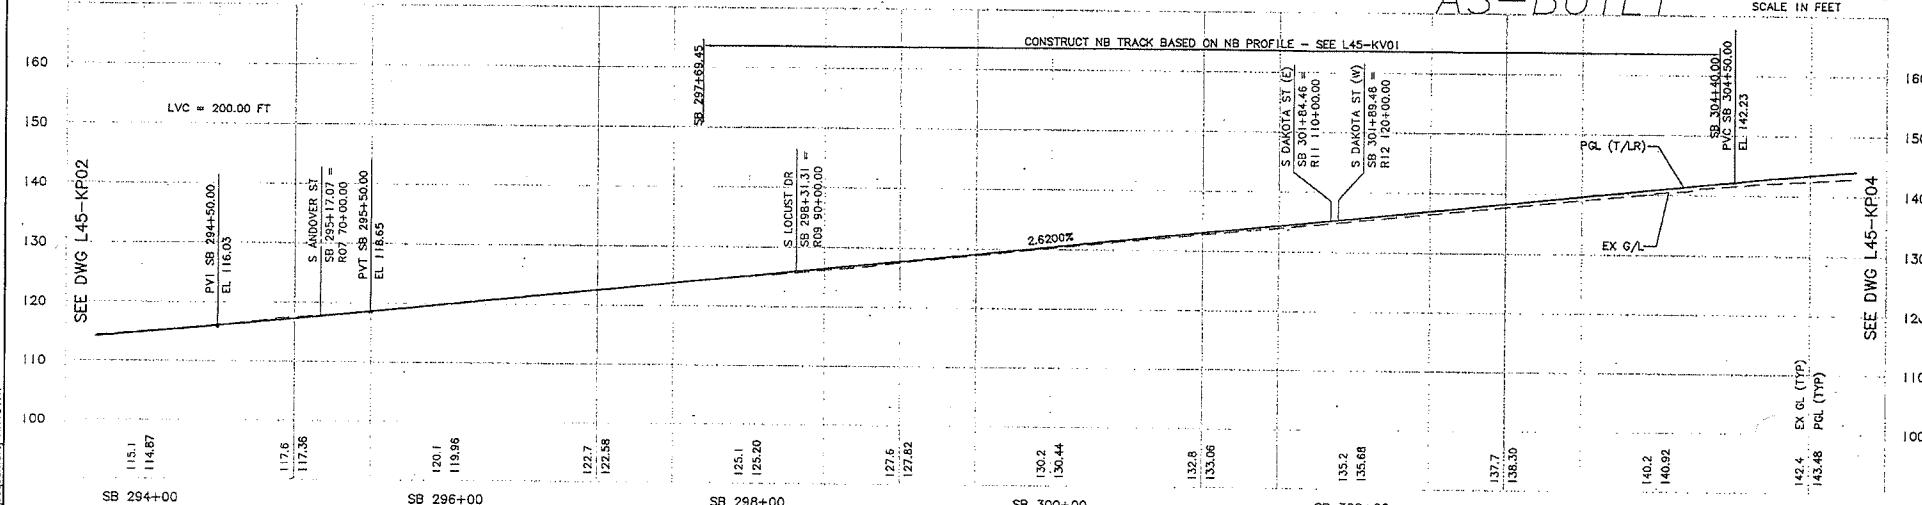

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1142.4

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NECC:  
-ALLDN  
-ZG-C200020  
-Quadrat  
CJD_145_CA  
CJD_173_CA  
CJD_217_CA  
CJD_X19_CA  
X116CH  
X116CR  
X116RS  
X116S  
ZG-223+SEARCH  
-Uncorrected  
ST_NAHTS_C_A
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34208	INT'L SERIAL NO.	DATE	NAME	NATURE	MADE FIRST REV'D	C.R.
S. KELDA TUNIS						

SEARCH
SERIALS
S.C. 10

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Designed By:	A. J.
Drawn By:	B. BO
Checked By:	S. KING
Approved By:	R. S.

LASKI
OLIMA
GSLEY
CHINN

1

CH2M
kptf
itled:
CAMBO

MHILL
Consulting Engineers
Date: 12/12

SOUND

The logo for SF TRANSIT, featuring a stylized 'SF' monogram above the word 'TRANSIT'.

Scale:	
H: 1"=40'; V: 1'	
Filename:	C30_L45_KP0
Contract No.:	
Date:	05/

L

LINK LIGHT
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R

Drawing No.:
L45-K
Vault Plan No.
231-7
Sheet No.:
T4

P04
730
Rev.:
A


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LISCALE
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WING:
-ALLCH
JC-CJ0020
-DOMEX
C30-L45_XA
C30-R21_XA
C30-R20_CA
C30-R27_CA
C30-R29_XA
X136CH
X136GR
X136RY
X165ST
X141CH
X141GR
X141RA
X141ST
JC-7273EACH
SACLESNC
ST NAMES_C240

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34-208
 VAULT SERIAL NO. C-30 DATE 1-5-45 WORK KODAK DWS NATURE MADE FOR REVD
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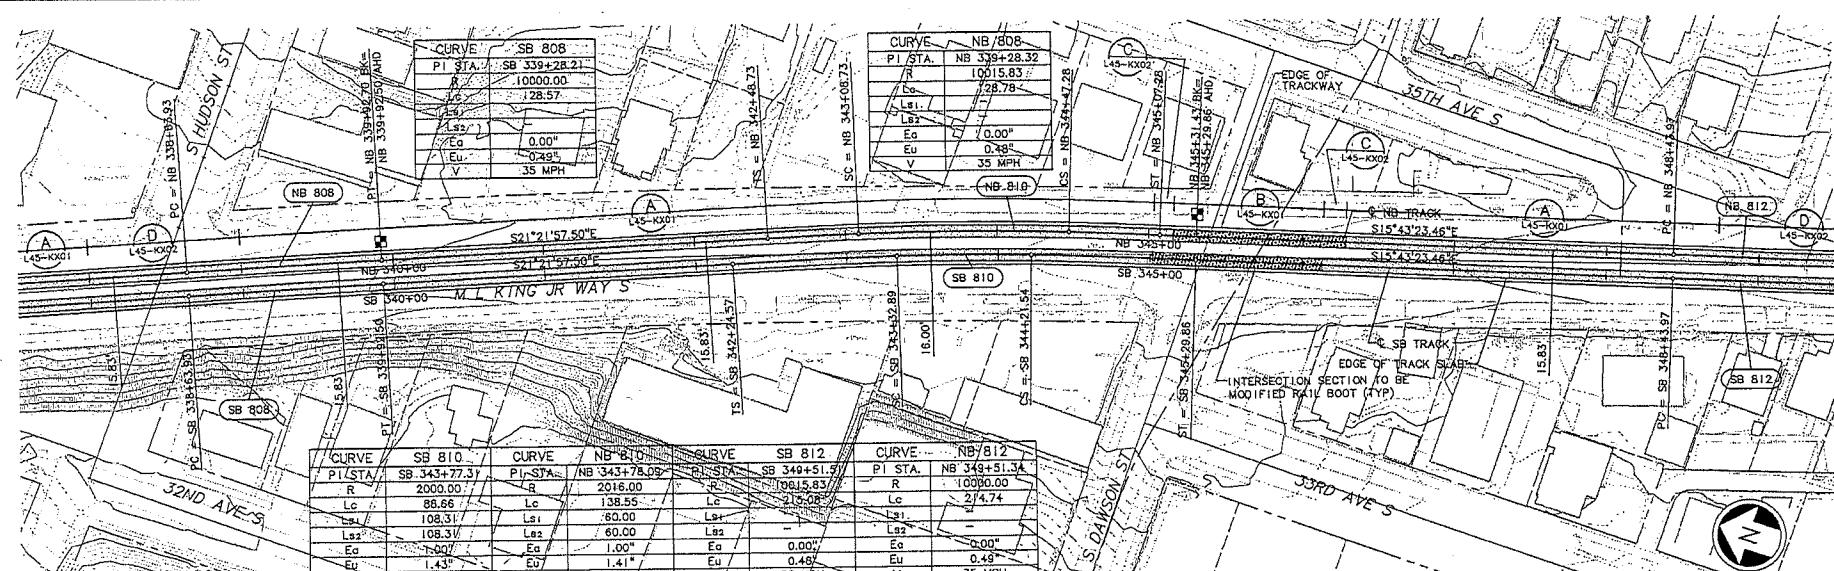
32EE DWG 1-45-KP07

17


				City of Seattle	Designed By: A. LASKI	CH2MHILL	SOUNDTRANSIT	Scale: H: 1" = 40'; V: 1" = 10' C30_L45_KP06.DWG Contract No.: C 735 Date: 05/30/03	LINK LIGHT RAIL PROJECT SOUTH CORRIDOR	Growing No.: L45-KP06
				Work Order No.: Permit No.: Y1433	Approved: Inspector's Book: B. BOLINA	Drawn By: Received: S. KINGSLEY	kpf Consulting Engineers	Filename:	TRACK PLAN & PROFILE STA SB 327+00 TO STA SB 338+00	Vault Plan No.: 231-730
A	10/03/01	AS-BUILT		Revised As Built: CONFORM	Approved By: B. SHINN	Submitted: S. KANBOL	Date: 12/12/03	Approved: T. RABEN	Date: 12/12/03	Sheet No.: 76 A Rev.: A
B	0	12/12/03		No. Date Rev. Chk. Acc. Revisions						



SEE DWG L45-KP06



SEE DWG L45-KP06

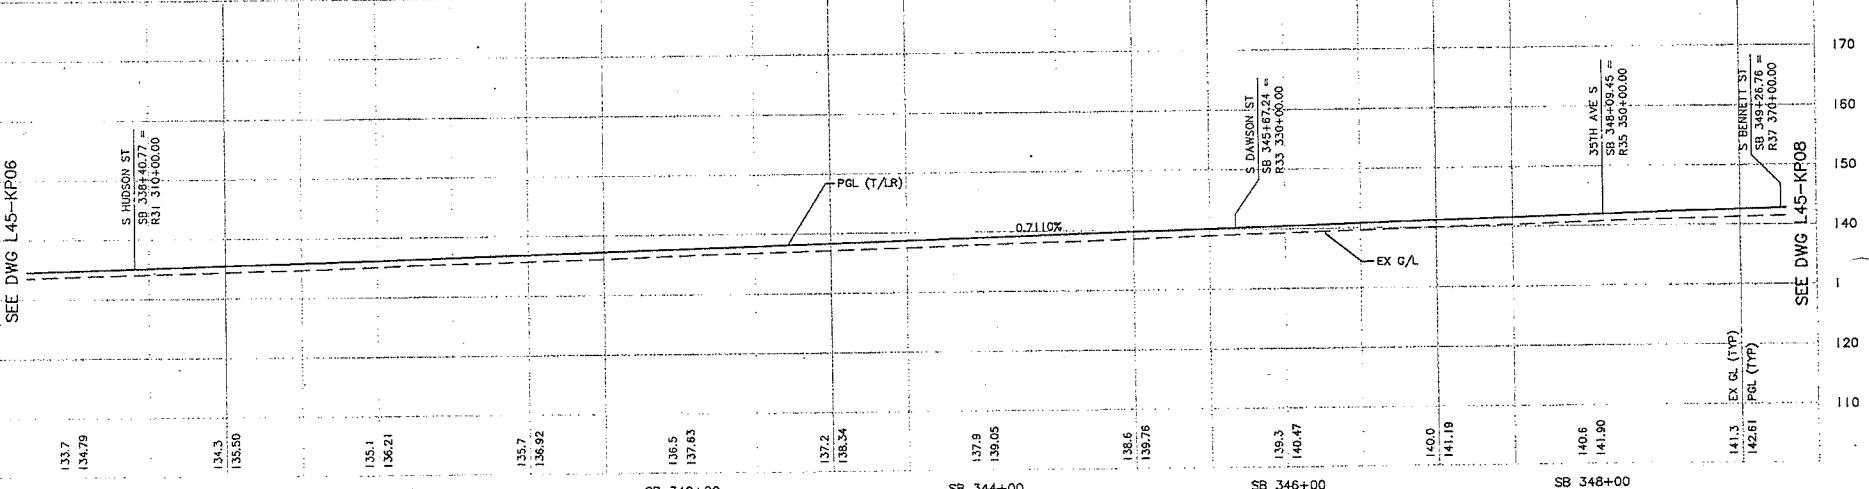

City of Seattle

Work Order No.

Approved:

Permit No.

Inspector's Book:

Received:

Checked By:

S. KINGSLY

Revised As Built:

Approved By:

B. SHINN

CH2MHILL

kptt

Consulting Engineers

Submitted:

Date:

Approved:

Date:

Contract No.:

C 735

Sub:

S. KAMBOL

12/12/03

T. RABEN

12/12/03

Date:

05/30/03

SOUNDTRANSIT

ST

Sound Transit

Submitted:

Date:

Approved:

Date:

Contract No.:

C 735

Sub:

S. KAMBOL

12/12/03

T. RABEN

12/12/03

Date:

05/30/03

LINK LIGHT RAIL PROJECT
SOUTH CORRIDOR

TRACK PLAN & PROFILE
STA SB 338+00 TO STA SB 349+00

Sheet No.: 77 Rev.: A

Drawing No.: L45-KP07

Vault Plan No.: 231-730

Sheet No.: 141.3 Rev.: A

EX GL (typ.)

PCL (typ.)

141.3 142.61

SEE DWG L45-KP08

SEE DWG L45-KP08

77

A


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-Draconis
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C30_332_CA
C30_841_CA
C30_R43_CA
X141CN
A141CR
X141RVS
X141ST
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X143RVS
X143ST
2G_C20020
-Altair
ST_NAMES_20

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SEE DWG L45-KP07




AS-BUILT

SCALE IN FEET

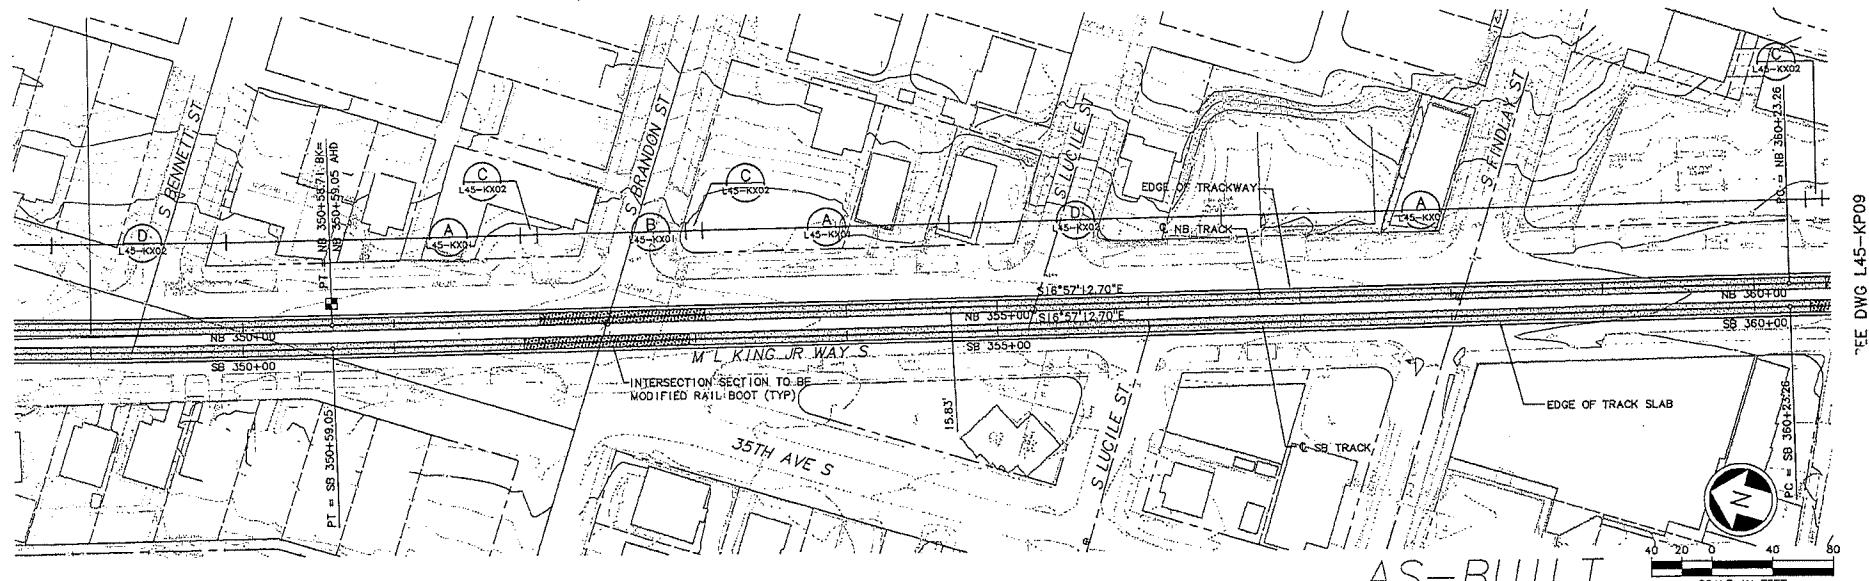EE DWG L45-KP09

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160

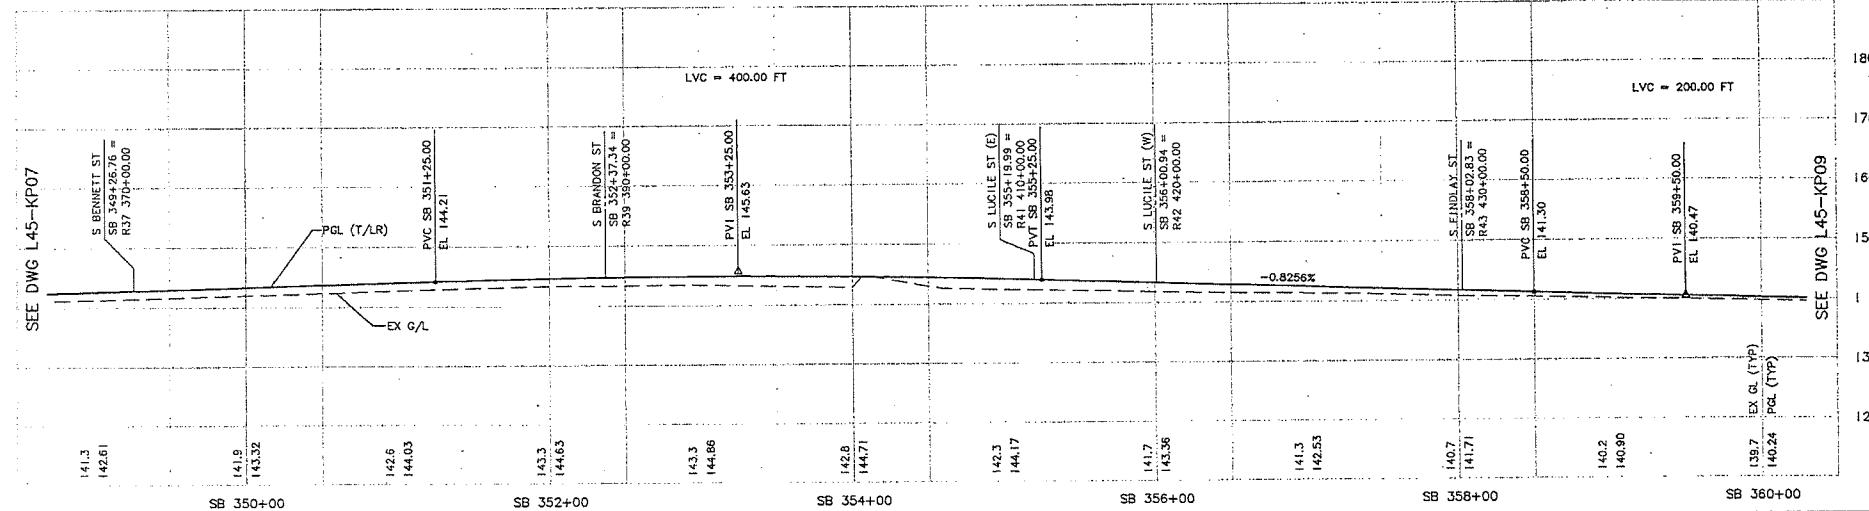

200.00 FT

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City of Seattle

Order No.	Approved:
File No.	Y1433 Inspector's Book:
	Received:
	Revised As Built:

Designed By:	A. LASKI	
Drawn By:	B. BOLIMA	
Checked By:	S. KINGSLEY	
Approved By:		Submitted

CH2MHILL
kpf Consulting Engineers



SOUNDTRANSIT

	Scale: H: 1" = 40'; V: 1" = 10'
	Filename: C30_L45_KP08.DWG
	Contract No.: C 73
Date:	Date: 12/03 - 05/30/0

**LINK LIGHT RAIL PROJECT
SOUTH CORRIDOR**

TRACK PLAN & PROFILE

STA SB 349+00 TO STA SB 360+00

Drawing No.: L45-KP08
Vault Plan No. 231-730
Sheet No.: Rev. A

ONE INCH
LISCALE
1:1
36ECE
-A11002
2G-C20020
-D1020
CJ0-.145-XA
CJ0-.147-CA
CJ0-.149-XA
X14JCN
X14JCR
X14JSX
X14JSF
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SEE DWG L45-KP08


卷之三

CURVE SB 816		CURVE NB 816	
P1 STA.	SB 360+73.18	P1 STA.	NB 367+23.24
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Lc	107.42	Lc	107.53
Ls1	-	Ls1	-
Ls2	-	Ls2	-
Eg	0	Eg	0
Eu	0.32°	Eu	0.32°
V	35 MPH	V	35 MPH

TE DWG L45-KP10

AS-BUILT

SCALE IN FEET

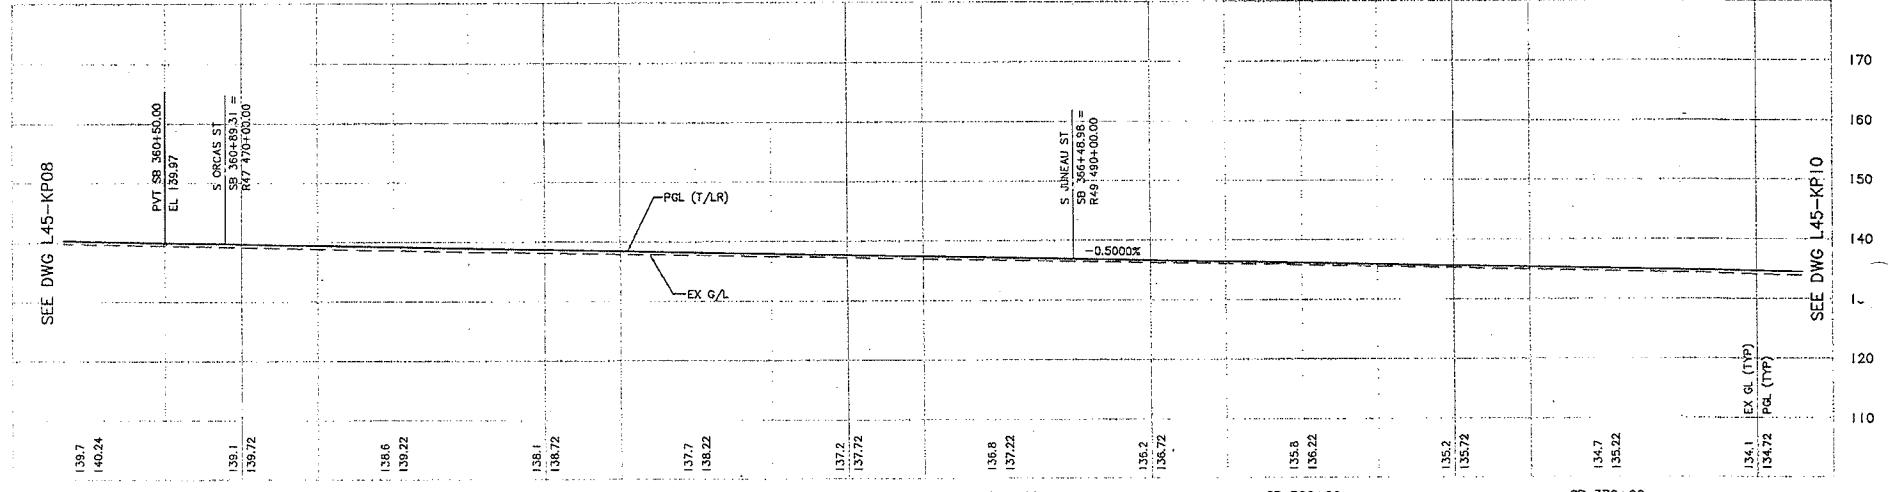

SEE DWG L45-KP

			City of Seattle			Designed By: A. LASKI	CH2MHILL	SOUNDTRANSIT	Scale: H: 1" = 40'; V: 1" = 10' Filename: C30_L45_KP09.DWG Contract No.: C 735	LINK LIGHT RAIL PROJECT SOUTH CORRIDOR			Drawing No.: L45-KP09
			Work Order No.	Approved:		Drawn By: B. BOLIMA							Vault Plan No.: 231-730
			Permit No.	Y1433	Inspector's Book:	Checked By: S. KINGSLY							Sheet No.: 73 Rev.: A
			Received:			Revised As Built:							
						Approved By: B. SHINN							
A	10/03/03	AS-BUILT					Date:	Approved:	Date:	Approved:	Date:	TRACK PLAN & PROFILE STA SB 360+00 TO STA SB 371+00	
O	12/12/03	CONFORM					SUBMITTED: S. KAMBOL	12/12/03	T. RABEN	12/12/03	05/30/03		
Date: 09/03/03			Drawn By:	Chk. App.	Reviewed:								




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-AUG-
ZC-GY0000
ZC-GY0000
CZL-AKA
CZL-AKA
CZL-AKA
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CZL-AKA
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X1-5DX
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ST.HMRC.CA


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INTL SEAL NO. DATE WORK NATURE
10855 : 08/15/2011 READING
345-KP09
345-KP09



SEE DWG L45-KP09

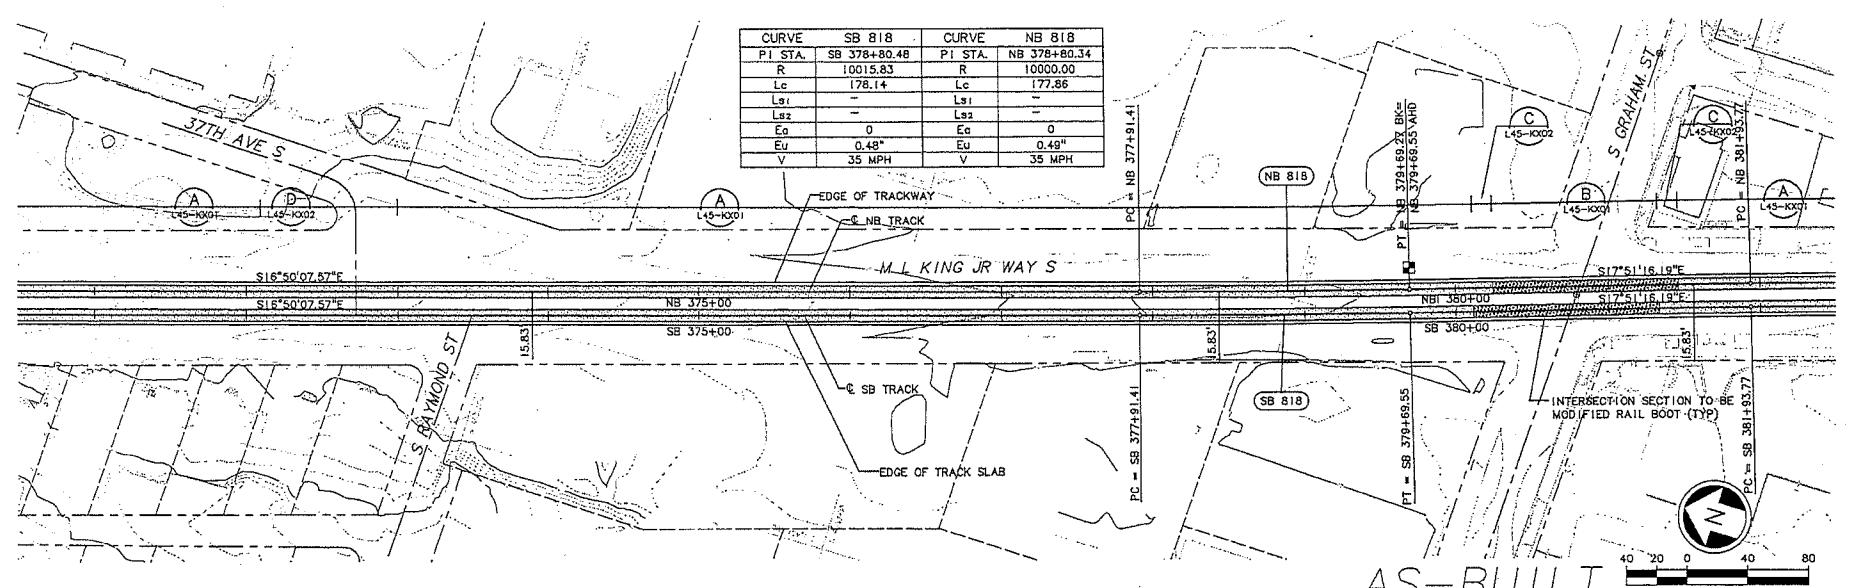

SEE DWG L45-KP11

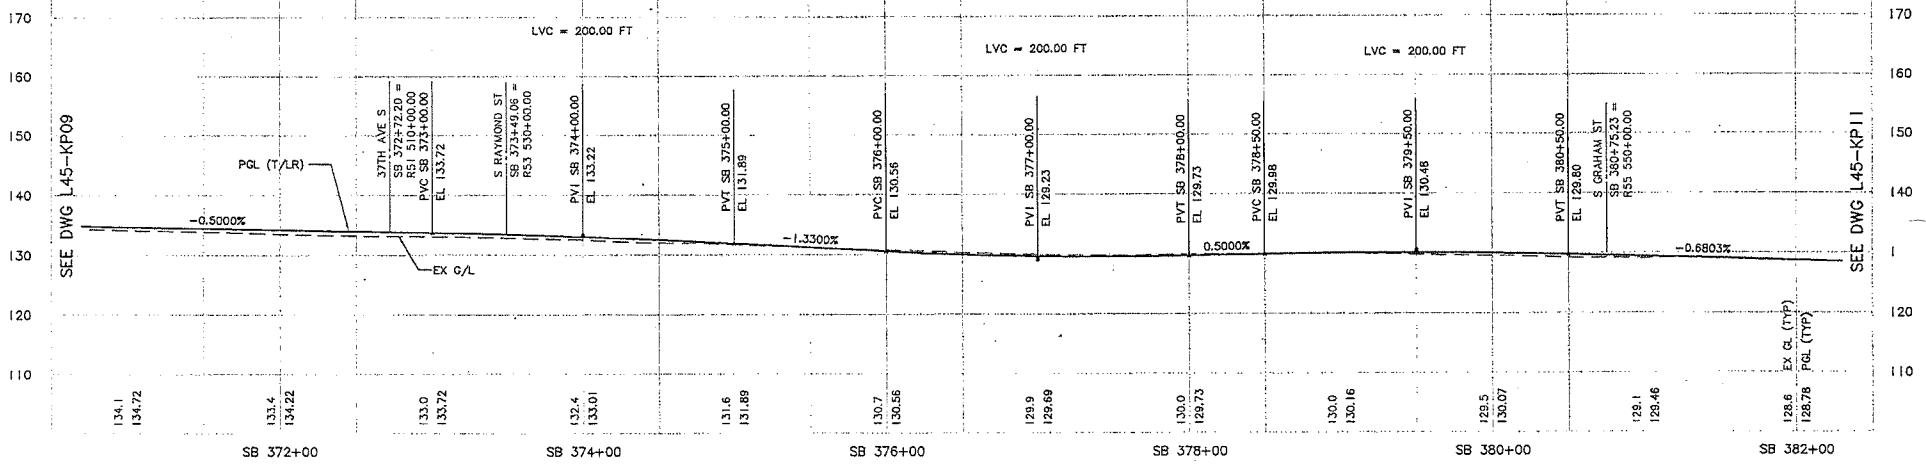

Work Order No.	Approved:	Designed By:	Drawn By:	Submitted:	Scale:	Drawing No.:
Permit No. Y1433	Appointed Inspector's Book:	A. LASKI	B. BOLIMA	PCL SB 378+00.00	H:1'=40'; V:1'=10'	L45-KP10
Received:	Checked By:	S. KINGSLEY	S. KINGSLEY	PCL SB 378+50.00	Filenum:	Vault Plan No. 231-730
Revised As Built:	Approved By:	B. SHINN	S. KAMBOL	PCL SB 379+50.00	Contract No. C 735	Sheet No. 80 Rev. A
No. Date Drawn Chk. App. Revisions	08/12/03	10/03/11	AS-BUILT	12/12/03	12/12/03	05/30/03

City of Seattle

Permit No. Y1433
Received:
Revised As Built:
Approved By:
No. Date Drawn Chk. App. Revisions

Approved:
Inspected & Book:
Checked By:
Approved By:
No. Date Drawn Chk. App. Revisions

Approved:
Received:
Revised As Built:
Approved By:
No. Date Drawn Chk. App. Revisions

CH2MHILL
kpf Consulting Engineers

SOUNDTRANSIT

LINK LIGHT RAIL PROJECT
SOUTH CORRIDOR
TRACK PLAN & PROFILE
STA SB 371+00 TO STA SB 382+00

Drawing No. L45-KP10
Vault Plan No. 231-730
Sheet No. 80 Rev. A

DIG-UNIV
LISCALE
1=1

X0000
-Allison
JC-G20020
-Bretton
CJ0-145_RA
CJO_H57_CA
CJO_H50_CA
CJO_H61_RA
CJO_H63_CA
CJO_H67_CA
CJO_H69_CA
X152CN
X152GW
X152W
JC-223457ACD
-Unmarked
JC0_A00_CA
SI_NAMES_C2

34208 45, KEP. D. W. G. 1-145 NATURE REVISIONS MADE CHD REV'D
ULT SERIAL NO. DATE MARK BY

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SEE DWG L45-KP10

PC = NB 381+93.77

$$PC = SB \cdot 381 + 93.77$$


By:
A. B.
y:
B. BC
By:
S. KING
d By:
B. S.

CH2MHIL
kpf Consulting Engineers

SOUNDTRA

LINK LIGHT RAIL PROJECT
SOUTH CORRIDOR


Drawing No.:	L45-KPI
Vault Plan No.	231-730
Sheet No.:	81 A

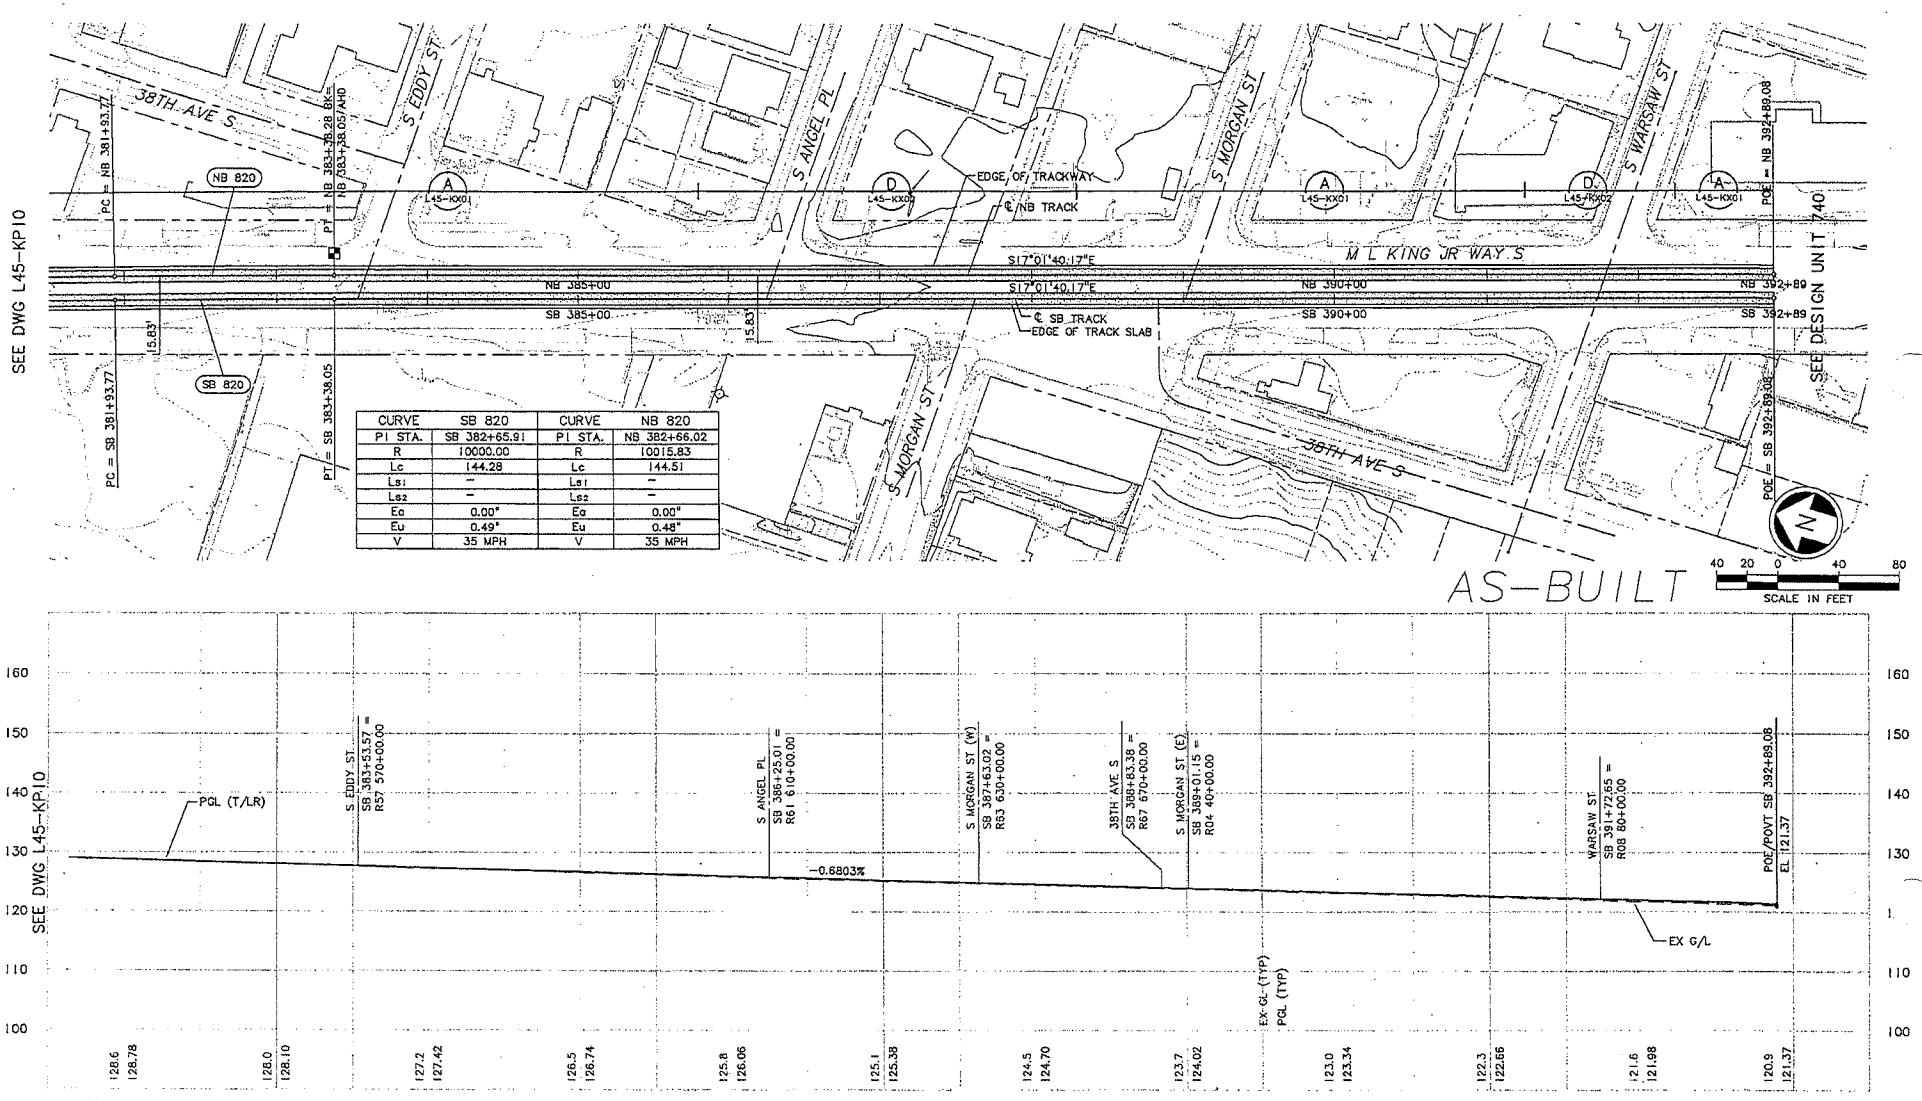

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CBL-LSC-CA
CBL-NCS-CA
F152CH
F152CH
A925
A925
JG-723SEARCH


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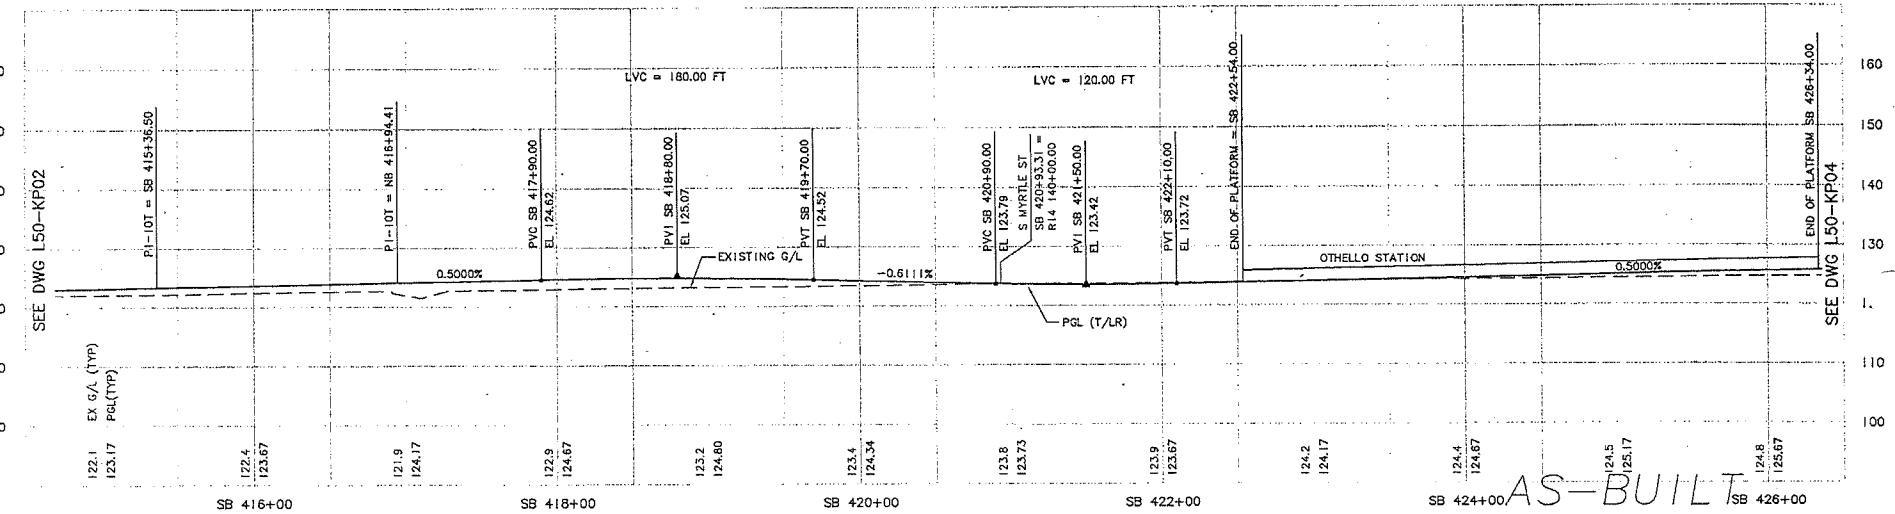
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SEE DWG L50-KP02

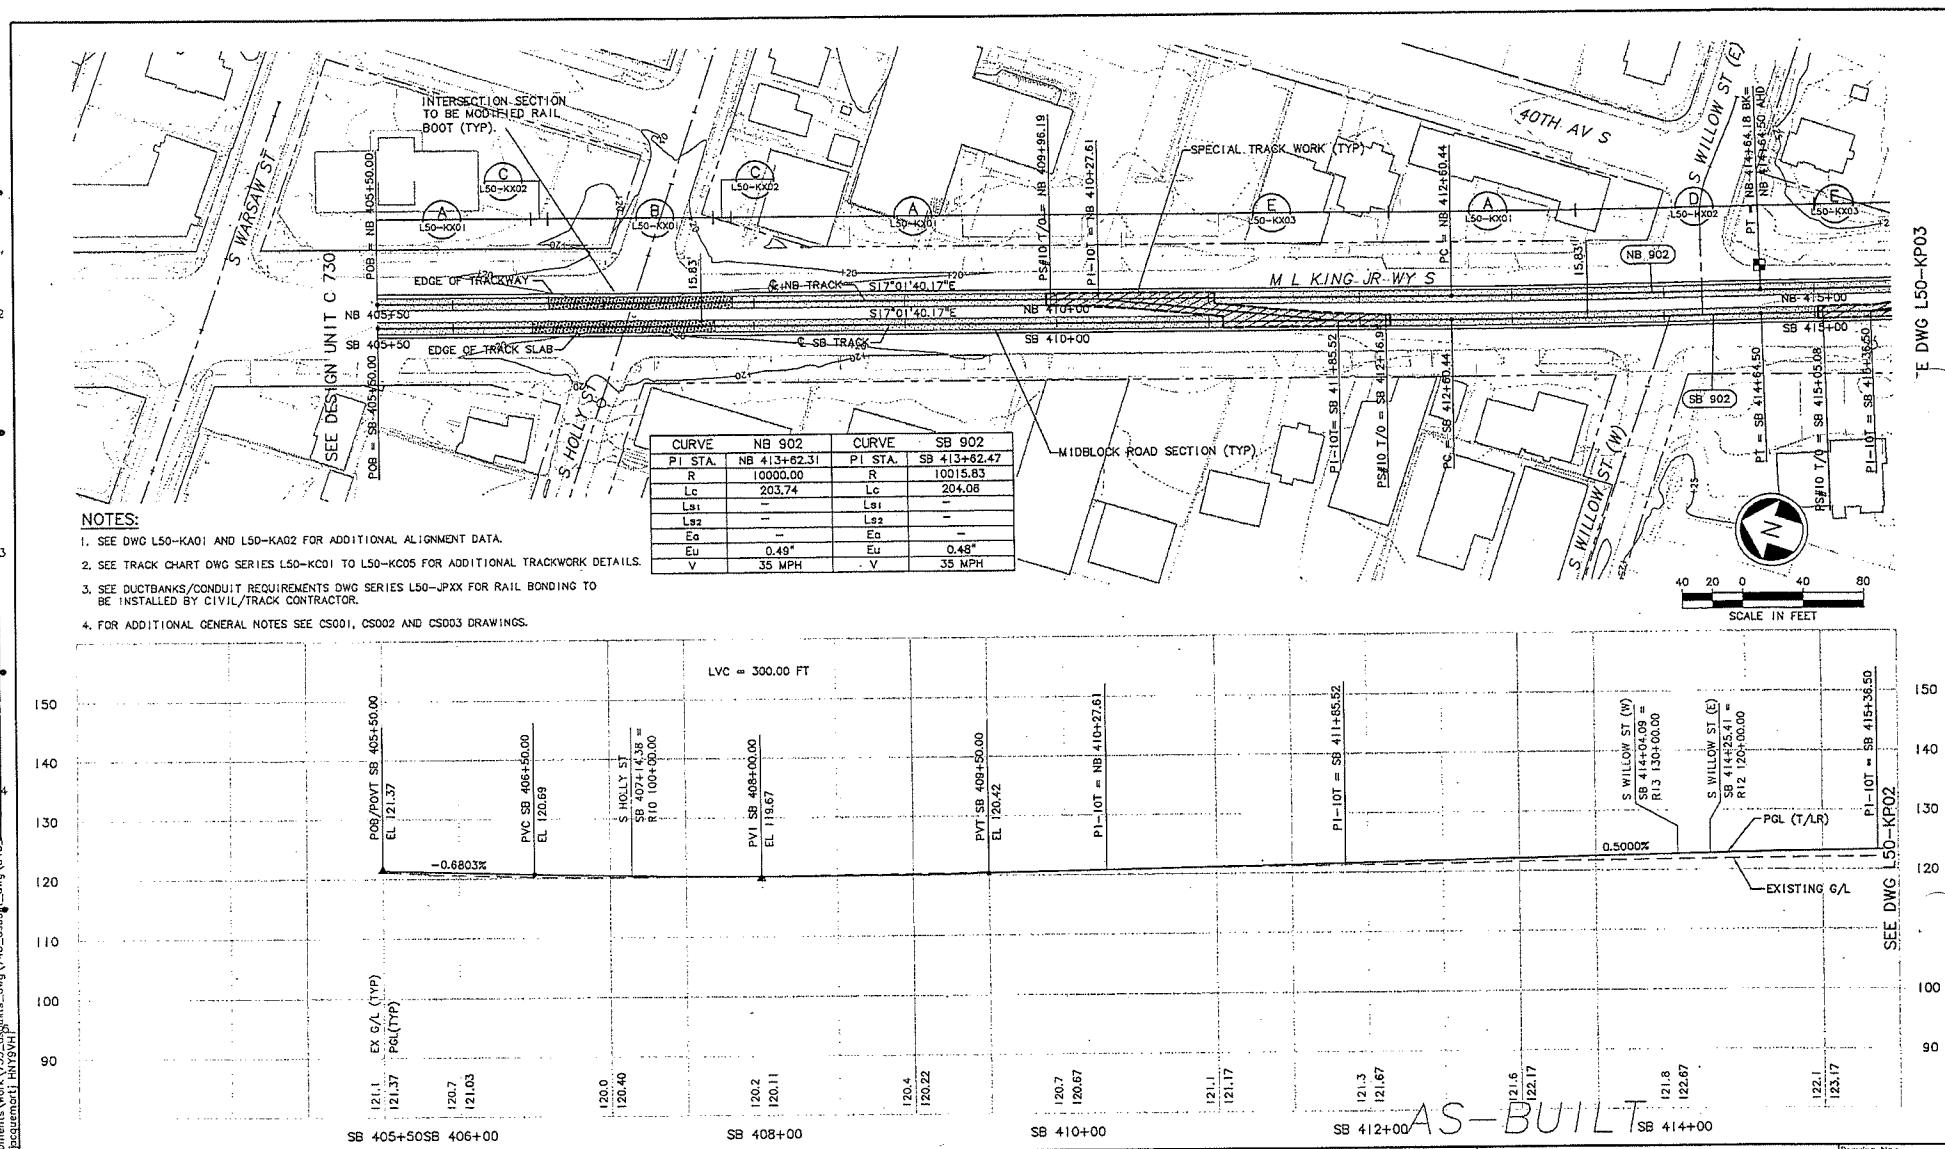

34209 DATE 04/01/03
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RESPONSIBILITY: G


SEE DWG L50-KP02

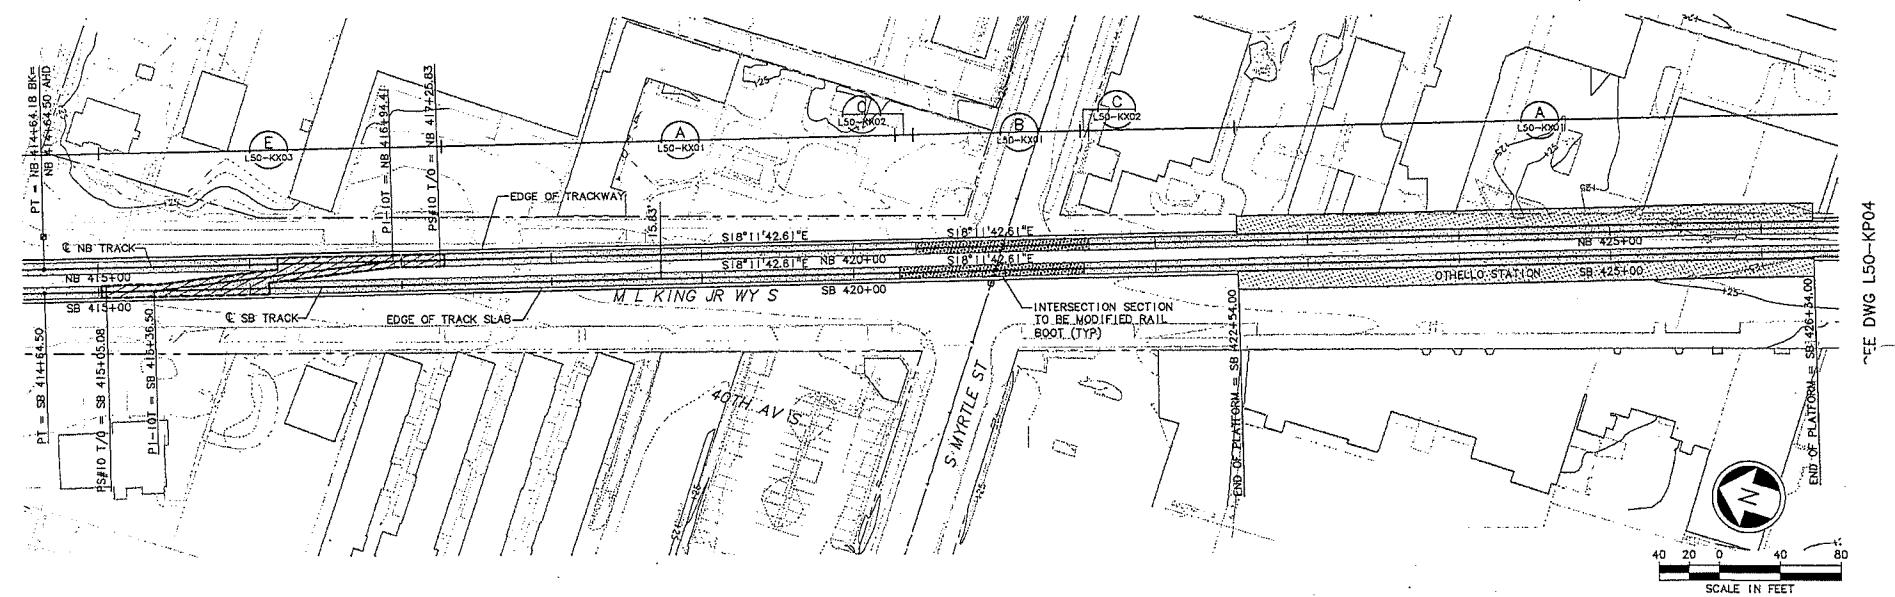

DWG INFO
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INCHES
CITY
JG-CPO030
-Quebec
-Calgary
C40_R16.CA
C40_R17.CA
X13_01
X13_02
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SEE DWG L50-KP03

34209 DATE ISSUED 12/12/03
VALT SERIAL NO. 1231740
Vault Plan No. 231-740
Sheet No. 84 Rev. A

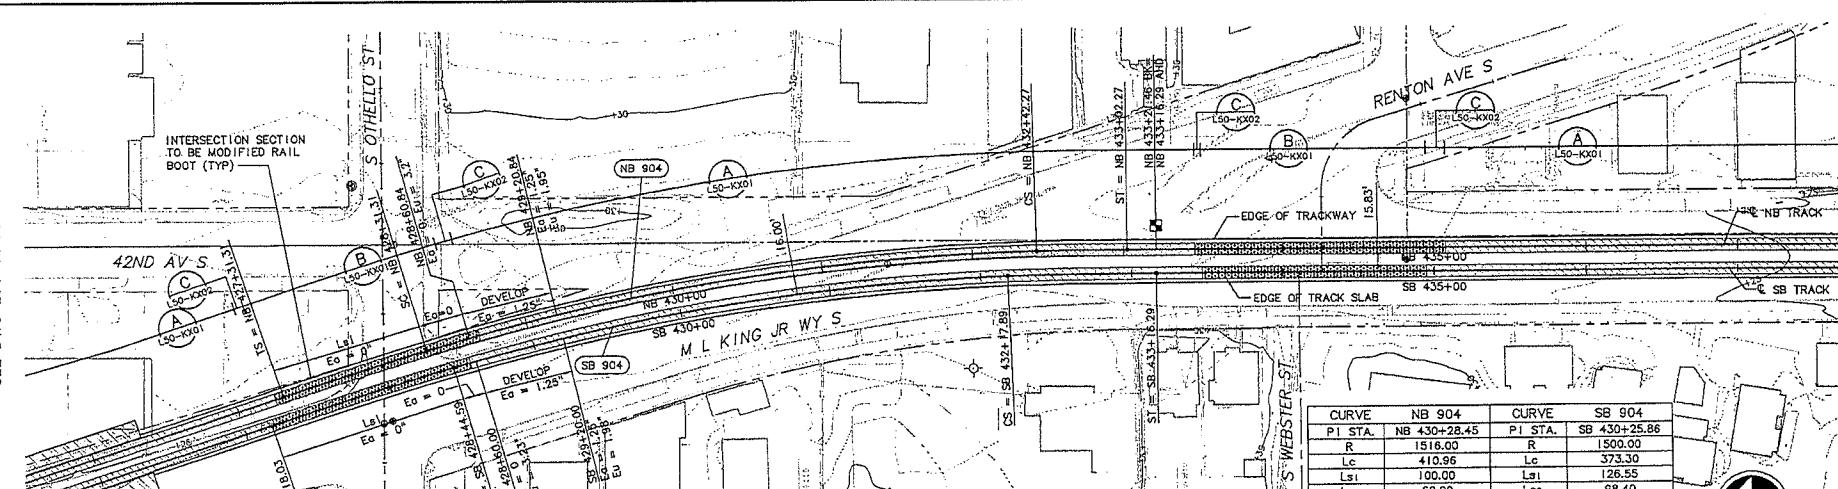


SEE DWG L50-KP04

34209 DATE WORK NATURE PLACE ENG'D REVO
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A	10/03/11	AS-BUILT	Work
O	12/12/03	CONFIRM	Perf.
			500

 City of Seattle

Order No.	Approved:
Alt. No.	Y-434 Inspector's Book
	Received:
	Revised As Built:

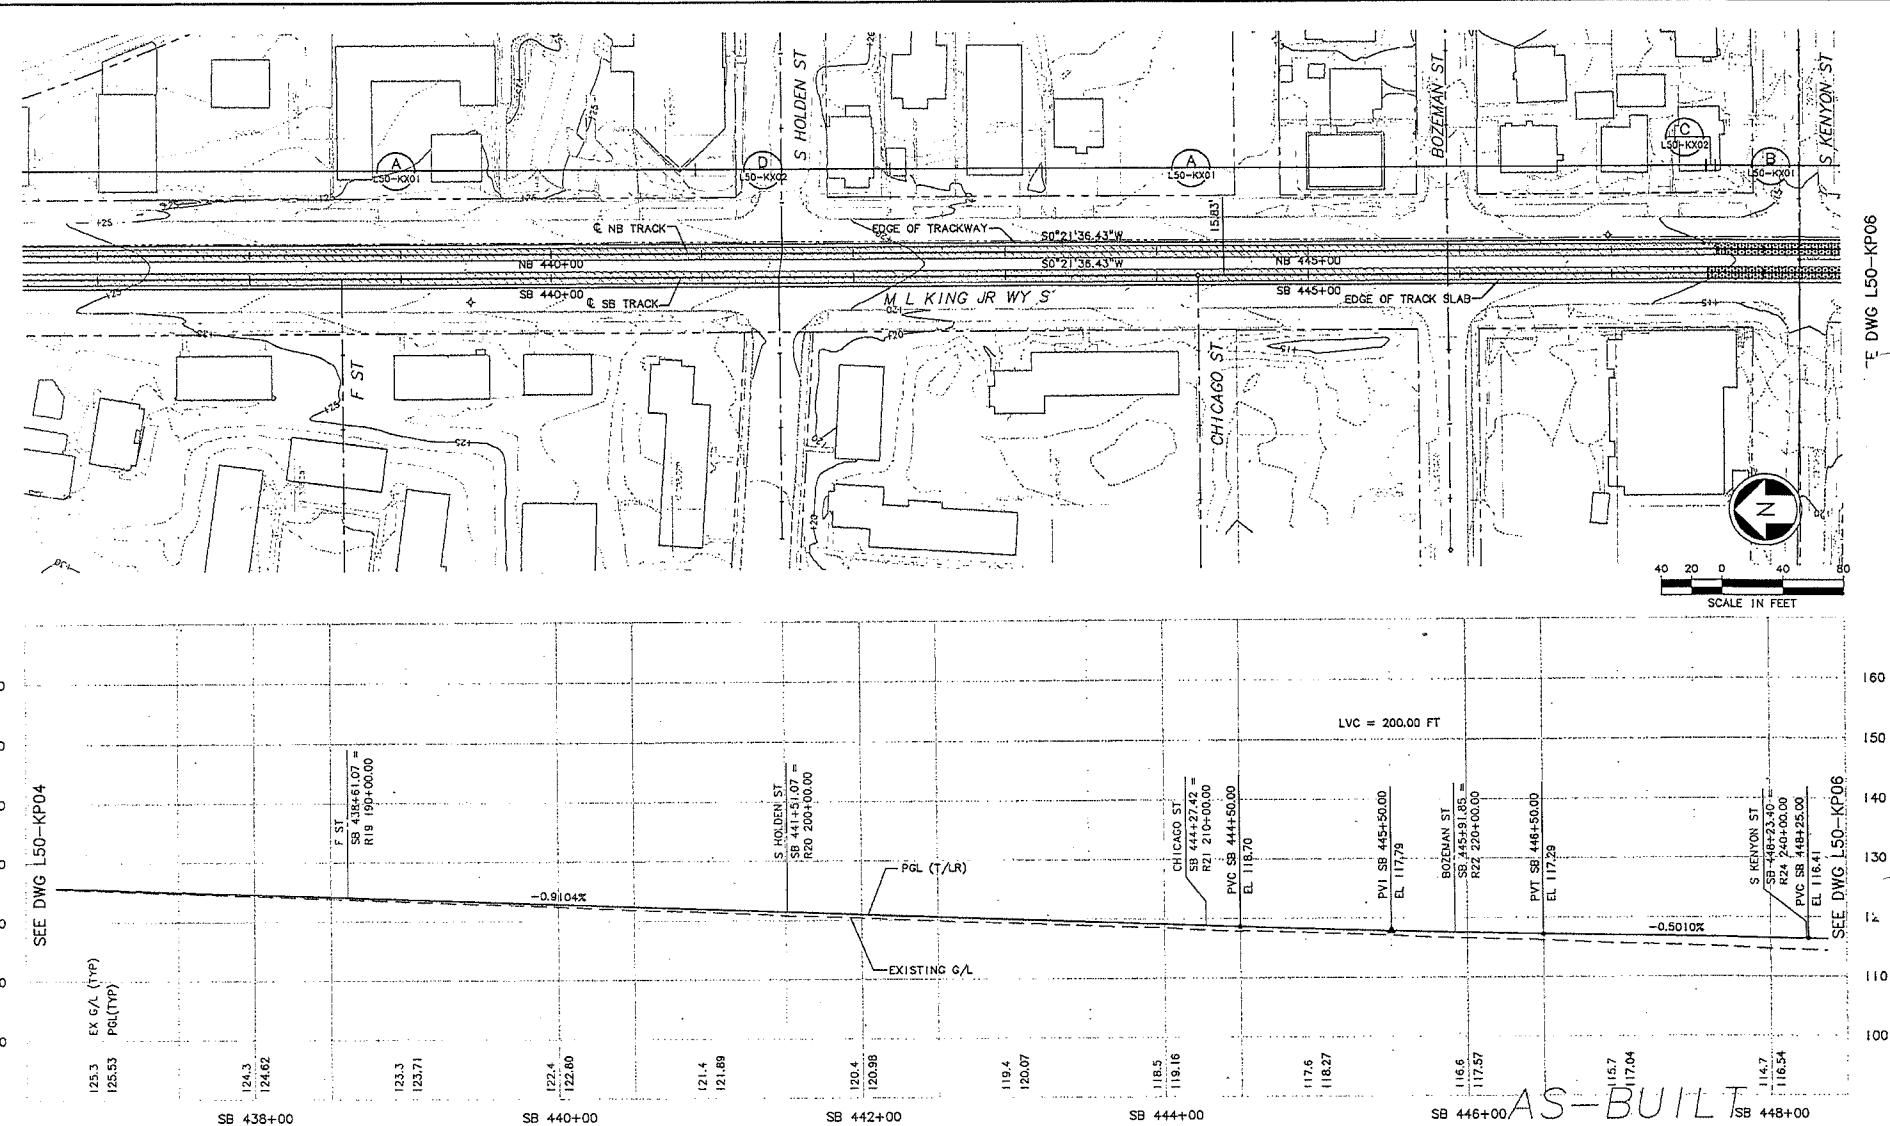Designed By: A. LASKI
Drawn By: B. BOLIMA
Checked By: S. KINGSLEY
Approved By: R. SHINN

CH2MHILL
k p f f Consulting Engineers

Submitted: [REDACTED] Page: [REDACTED]



SOUNDTRANSIT

Approved:

**LINK LIGHT RAIL PROJECT
SOUTH CORRIDOR**

TRACK PLAN & PROFILE
STA SB 437+00 TO STA SB 448+0

Drawing No.:	L50-KP05
Vault Plan No.	231-740
Sheet No.:	Re 85 A

34209
31_NAH

SEE DWG L50-KP05

EE DWG L50-KP07

SEE DWG L50-KP05

LVC = 500.00 FT

PVI SB 450+75.00
EL 115.16

PGL (T/LR)

EXISTING G/L

S. KENTON ST
SB 448+00 =
R24 240+00.00
PVC SB 448+25.00
EL 116.41

SB 448+00
116.54
116.55
113.8
115.85

SB 450+00
112.7
114.53

SB 452+00
110.8
112.54

SB 452+00
107.9
109.90

SB 454+00
106.59
102.82

SB 454+00
101.6
98.82

SB 456+00
98.4
99.08

SB 456+00
95.3
95.74

SB 456+00
92.1
92.80

SB 458+00
89.0
89.92

SB 458+00
85.8
87.04

LVC = 200.00 FT

PVI SB 453+26.00
EL 105.67

S. ELM GROVE ST
SB 453+98.94 =
R26 260+00.00
S. ELM GROVE CT
SB 343+45.45 =
R28 280+00.00
PVC SB 343+50.00
EL 00.92

PVI SB 454+50.00
EL 97.12

PVI SB 455+50.00
EL 94.24

S. ROSE ST
SB 456+70.26 =
R30 300+00.00

SEE DWG L50-KP07

AS-BUILT


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SEE DWG L50-KP07

				City of Seattle		Designed By:	A. LASKI	 	 SOUNDTRANSIT	LINK LIGHT RAIL PROJECT SOUTH CORRIDOR				Drawing No:		
				Work Order No.	Approved:	Drawn By:				H: 1"=40'; V: 1"=10'				L50-KP06		
				Permit No.	Y1434	Inspector's Book:	B. BOLIMA			Filename:				C40_L50_KP06.DWG		
						Received:	Checked By:			Contract No.:				C 735		
						Revised As Built:	S. KINGSLEY									
A 10/03/11		AS-BUILT		Approved By:		B. SHINN										
0 12/12/03		CONFORM		Approved By:		B. SHINN										
No.	Date	Den.	Chk.	App.	Revisions	5001:									Sheet No.:	Rev.:
															231-740	A
															86	
TRACK PLAN & PROFILE STA SB 448+00 TO STA SB 459+00																

DWG INDEX
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AREAS
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C40-K04, CA
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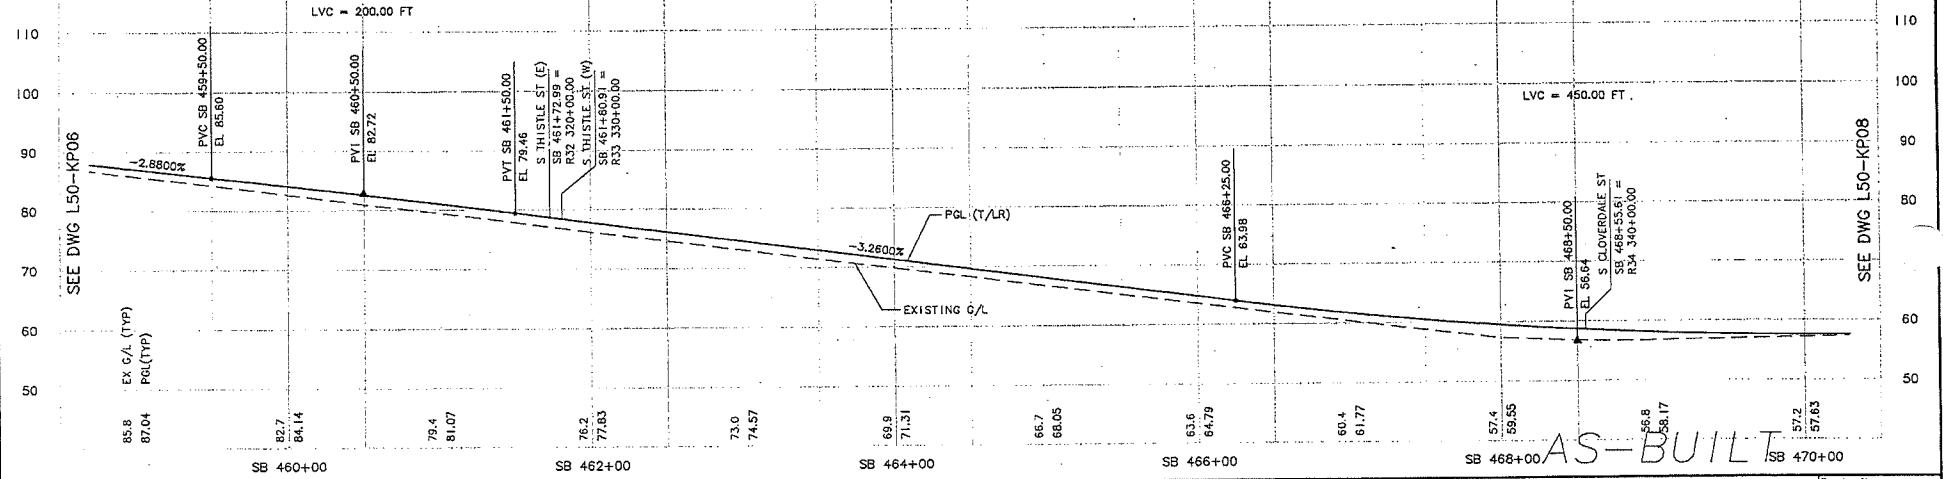
SEE DWG L50-KP06



SEE DWG L50-KP08

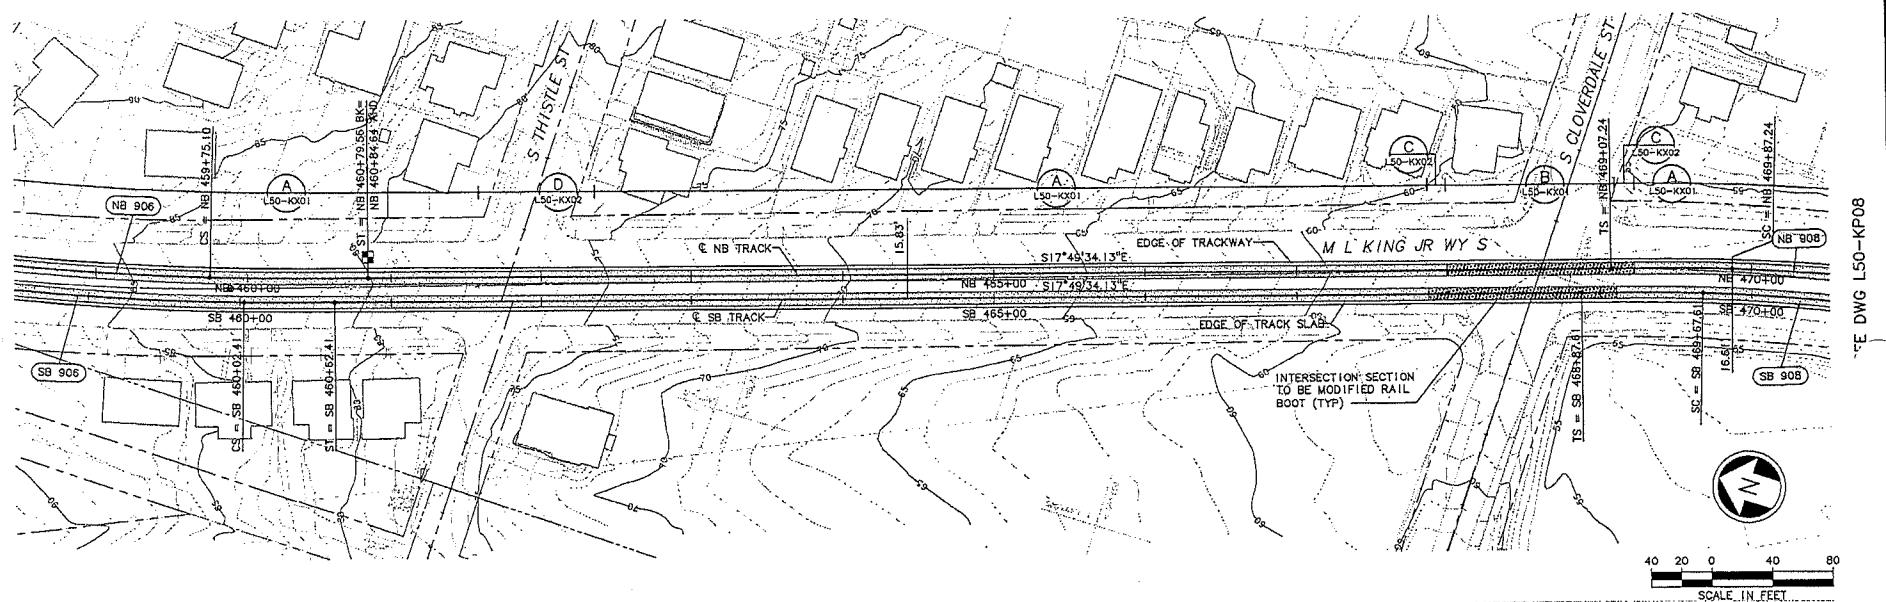34209
VULT SERIAL NO.
DATE WORK
MANUFACTURER
BUREAU
RECORD

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SEE DWG L50-KP08

No.	Date	Des.	Chk.	App.	Revisions	City of Seattle	CH2MHILL	SOUNDTRANSIT	LINK LIGHT RAIL PROJECT SOUTH CORRIDOR	Drawing No.:
0	10/03/11	AS-BUILT				Work Order No. Y1434 Approved:	Designed By: A. LASKI Drawn By: B. BOLINA Checked By: S. KINGSLEY Approved By: B. SHINN	Scale: H: 1" = 40'; V: 1" = 10' File name: C40_L50_KP07.DWG Contract No.: C 735 Date: 05/30/03	TRACK PLAN & PROFILE STA SB 459+00 TO STA SB 470+00	L50-KP07
0	12/12/03	CONFORM				Permit No. Y1434 Inspector's Book: Received: Revised As Built: SDOT:	Submitted: S. KAMBOL Date: 12/12/03 Approved: T. RABEN Date: 12/12/03 Date: 05/30/03	Vault Plan No. 231-740 Sheet No. 87 Rev. A		
0	09/16/11									



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XREFS:
-Allots
ZG-C20020
-Ductors
C40_LSO_KA
C40_R30_CA
C40_R30_CK
X1200N
X1785N
X1785Z
X1795T
X1810H
X1810R
X1810R
X1815F
ZG-2224-SEACH
-Unstabilized
ST NAMES_G-40

SEE DWG L50-KP07

CURVE NB 908

PI STA.	NB 472+87.82	PI STA.	NB 475+00
R	1230.00	R	1230.00
Lc	546.73	Lc	570.70
Ls ₁	80.00	Ls ₁	80.00
Ls ₂	80.00	Ls ₂	80.00
Ea	2.0"	Ea	2.0"
Eu	1.94"	Eu	1.94"
V	35 MPH	V	35 MPH

CURVE SB 908

PI STA.	SB 472+60.82	PI STA.	SB 475+00
R	1230.00	R	1230.00
Lc	546.73	Lc	570.70
Ls ₁	80.00	Ls ₁	80.00
Ls ₂	80.00	Ls ₂	80.00
Ea	2.0"	Ea	2.0"
Eu	1.94"	Eu	1.94"
V	35 MPH	V	35 MPH

CURVE SB 910

PI STA.	SB 478+64.94	PI STA.	SB 476+14.44
R	1000.00	R	1000.00
Lc	154.89	Lc	154.89
Ls ₁	-	Ls ₁	-
Ls ₂	-	Ls ₂	-
Ea	0.00"	Ea	0.00"
Eu	0.49"	Eu	0.49"
V	35 MPH	V	35 MPH

INTERSECTION SECTION TO BE MODIFIED RAIL BOOT (TYP)

EDGES OF TRACKWAY

HENDERSON ST

S FAIRBANKS ST

ML KING JR WY S

STATIONING

CS = NB 475+32.88

ST = NB 476+13.97

PC = SB 476+13.30

END OF PLATFORM = SB 480+14.44

SCALE: 1 IN. = 80 FT

Э-ДВГ 150-КР09

SEE DWG L50-KP07

57.2 EX G/L (TP)
57.63 PGL(TP)

PVT SB 470+75.00
EL 57.77

57.6
57.89

SB 470+00

SB 472+00 0.5000%

SB 474+00 58.0
58.39

58.4
58.89

58.7
59.39

58.89

PVC SB 475+00.00
EL 58.89

S. TRENTON ST (W)
SB 475+36.55 =
R36 340+00.00

S. TRENTON ST (E)
SB 475+45.06 =
R37 370+00.00

PVT SB 476+00.00
EL 60.39

LVC = 200.00 FT

59.7
60.51

PVT SB 477+00.00
EL 61.37

60.3
61.37

PGL (T/LR)

EXISTING G/L

0.9795%

61.7
62.35

S. HENDERSON ST
SB 478+16.84 =
R38 380+00.00

63.1
63.53

END OF PLATFORM = SB 480+44.44

HENDERSON STATION

63.3
65.29

SB 470+00

SB 472+00

SB 474+00

SB 476+00

SB 478+00 AS-BUILT SB 480+00

SEE DWG L50-KP09

SEEF DWG L50-KP09

					 City of Seattle	Designed By: A. LASKI
				Work Order No.	Approved:	Drawn By:
				Permit No.	Y1434 Inspector's Initials	B. BOLIMA
					Received:	Checked By:
A	10/03/11	AS-BUILT			Revised As Built:	S. KINGSLEY
O	12/12/03	CCNFORM			SDOT:	Approved By: B. SHINN
		Date	Chk.	App.	Revisions	

CH2MHILL
k piff Consulting Engineers




SOUNDTRANS

LINK LIGHT RAIL PROJECT
SOUTH CORRIDOR


TRACK PLAN & PROFILE
STA SB 470+00 TO STA SB 481+00

Drawing No.: L50-KP08
Vault Plan No. 231-740
Sheet No.: Rev.
88 A

SEE DWG L50-KP08

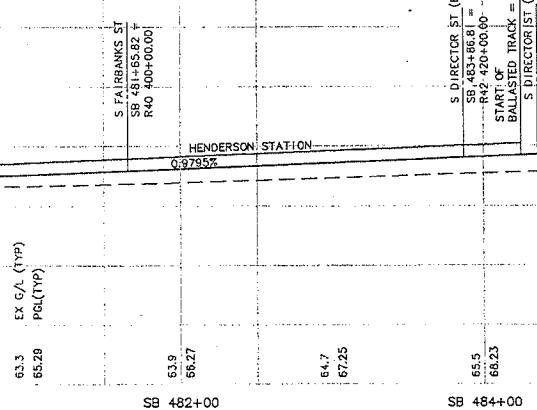

SEE DWG L50-KP08

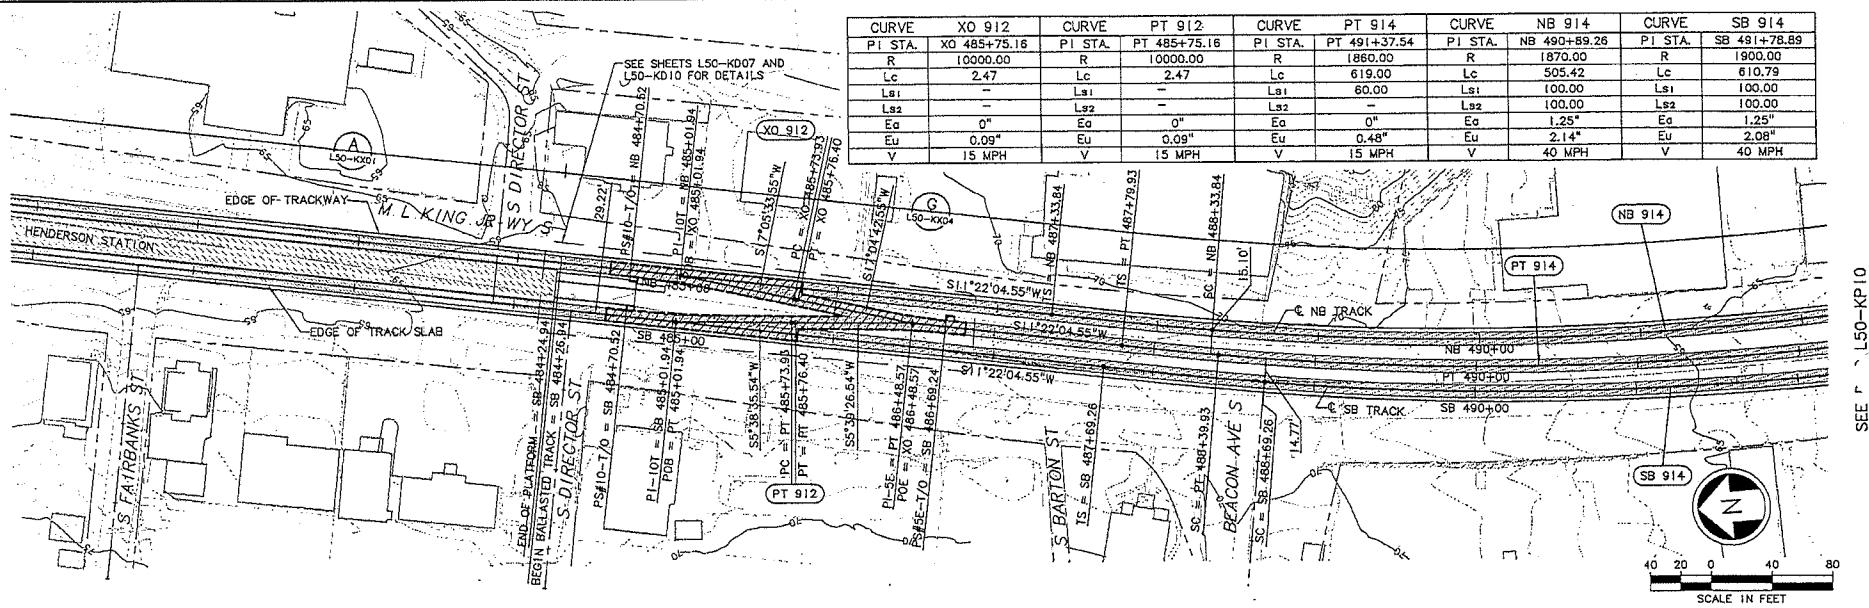

SEE r L50-KP10



City of Seattle

B	10/03/11	AS-BUILT	Designed By:	A. LASKI
A	08/04/06	ISSUED FOR CONSTRUCTION-CONFORM	Approved By:	B. BOLIMA
		Permit No. Y1434	Drawn By:	B. BOLIMA
		Inspector's Book	Revised:	S. KINGSLEY
O	12/12/03	RFI #1064A	Checked By:	S. KINGSLEY
No.	Date	SDOT:	Approved By:	B. SHINN

CH2MHILL
kpff Consulting Engineers


SOUNDTRANSIT

 Scale:
 H: 1"-40'; V: 1"-10'
 File name:
 C40_L50_KP09.DWG
 Contract No.:
 C 735
 Date: 05/30/03


 LINK LIGHT RAIL PROJECT
 SOUTH CORRIDOR
 TRACK PLAN & PROFILE
 STA SB 481+00 TO STA SB 492+00

 Drawing No.: L50-KP09
 Vault Plan No.: 231-740
 Sheet No.: B
 Rev.: B
 89

SEE DWG L60-KP008

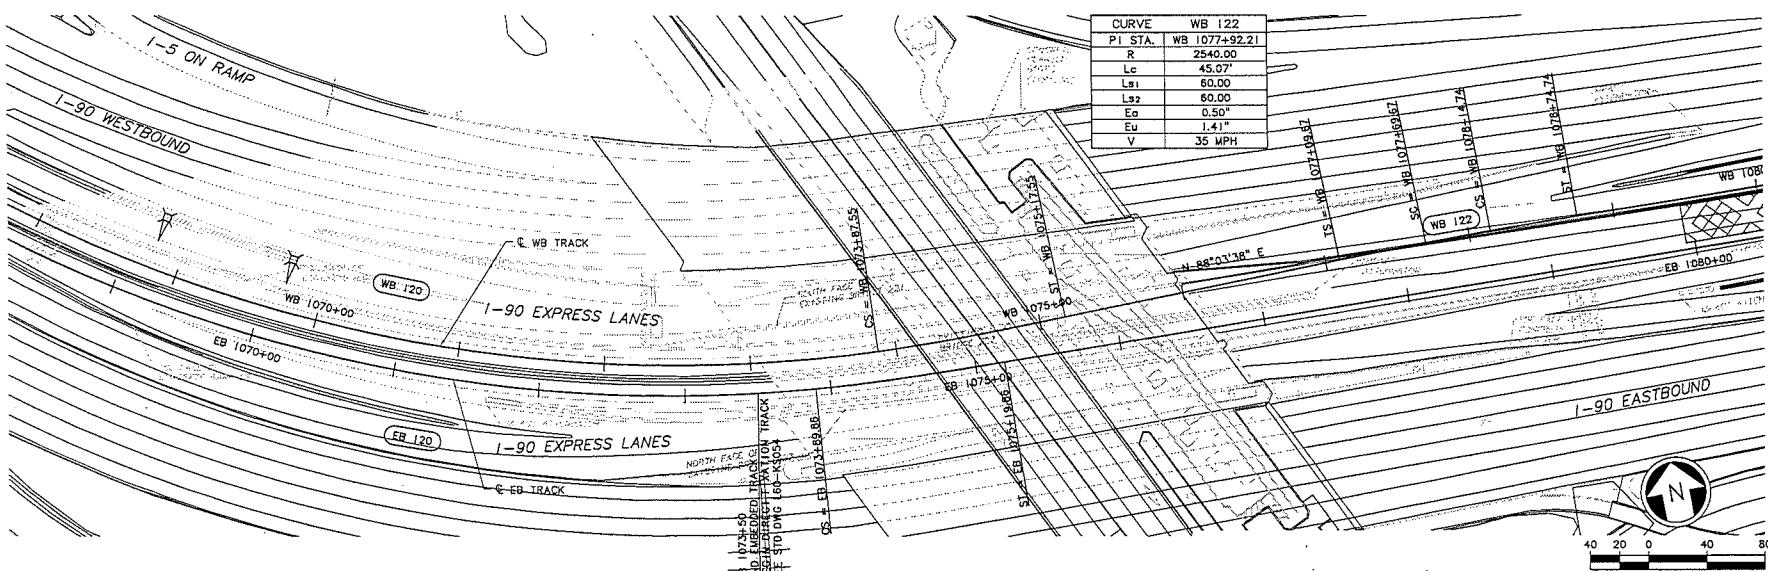



SEE DWG L60-KP010

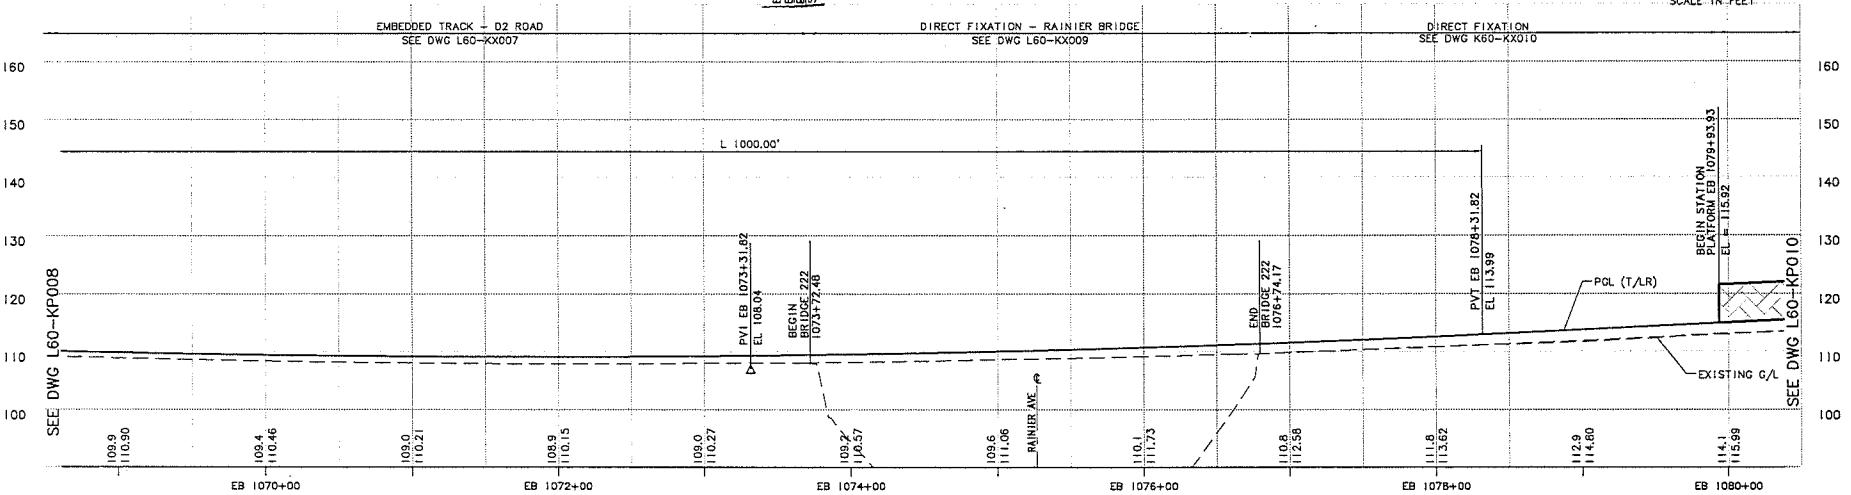

Designed By: A. BASTASCH	Drawn By: F. BOLIMA	Checked By: S. METZ	Approved By: T. MUDAYANKAVIL	CH2MHILL	BOLIMA DRAFTING & DESIGN INC.	SOUNDTRANSIT	Scale: H: 1"=40'; V: 1"=10' Filename: ELA_L60_KP009.dwg Contract No.: Project EB 1079+93.33 Station EB 1079+93.33 El. H: 115.92	LINK LIGHT RAIL PROJECT EAST CORRIDOR SEGMENT A TRACK PLAN & PROFILE STA EB 1069+00 TO STA EB 1080+00	Drawing No.: L60-KP009 Sheet No.: 101 Rev.:
Date:	Date:	Date:	Date:	Submitted:	Date:	Approved:	Date:	1/28/11	
No.	Des.	Drawn	Chkd	Appv.	Revisions	Final PE	Half Scale	1/28/11	



SEE DWG L60-KP09

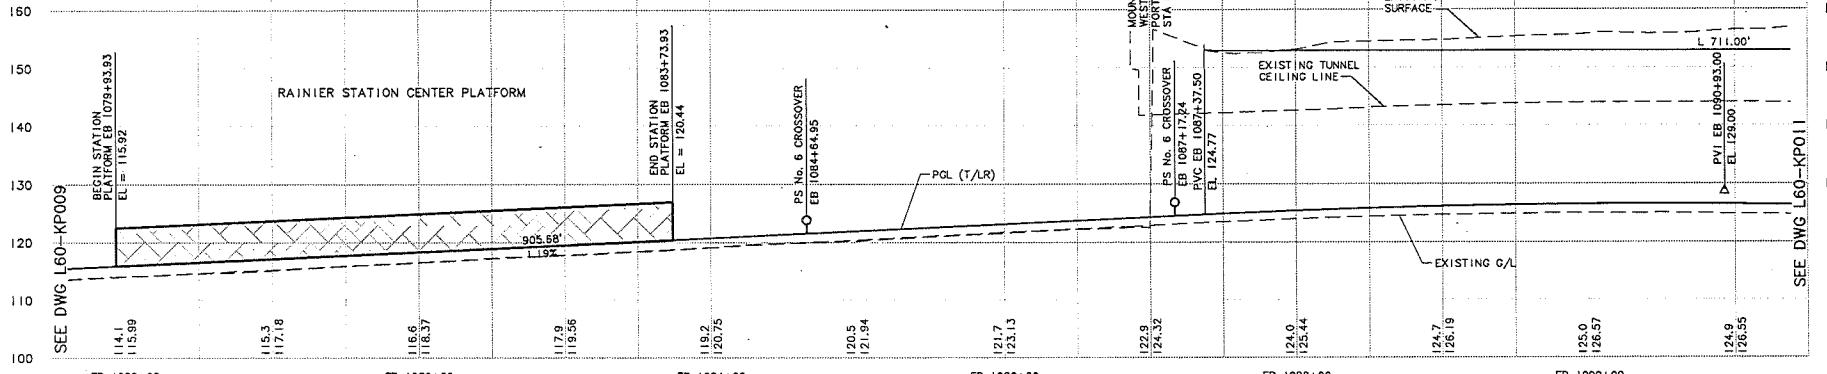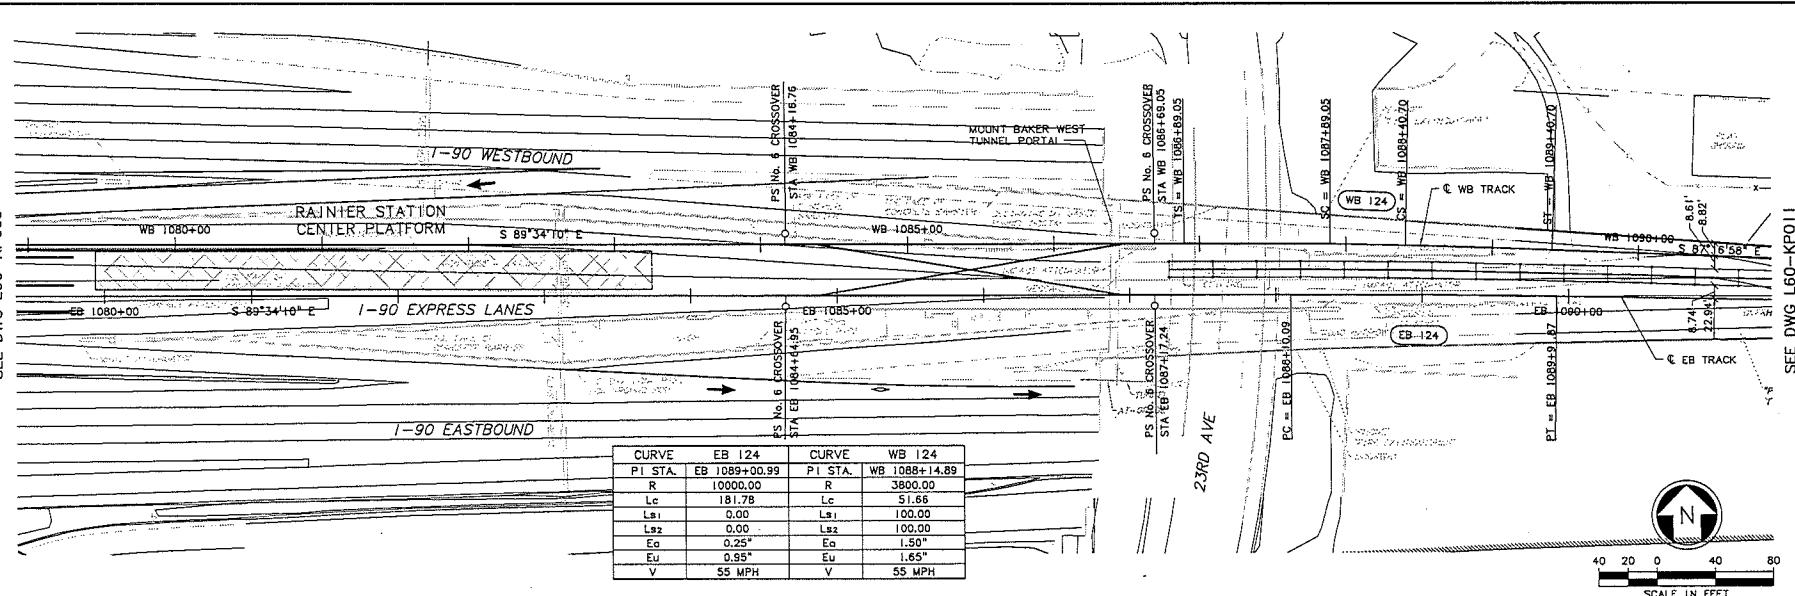

No	Date	Des.	Chk.	App.	Revisions	Designed By: A. BASTASCH	Drawn By: F. BOLIMA	Checked By: S. NETZ	Approved By: T. MUDAYANKAVIL	CH2MHILL <small>CH2MHILL CONSULTING ENGINEERS INC. FINAL PE</small>	BOLIMA <small>BOLIMA DRAFTING & DESIGN INC.</small>	SOUNDTRANSIT	Scale: H: 1" = 40'; V: 1" = 10' Filename: ELA_L60_KP010.dwg Contract No.: I-28/11	LINK LIGHT RAIL PROJECT EAST CORRIDOR SEGMENT A TRACK PLAN & PROFILE STA EB 1080+00 TO STA EB 1091+00	Drawing No.: L60-KP010 Sheet No.: 102



Q.M.G.
LSSC
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XRT
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-Qso
ELA
ELA...
REC
SLD
Zg...
Zg...
z781
z781
z811
z811
-1kpc
Surv
ELA
ELA...
key

SEE DWG L60-KP012

SEE DWG L60-KP0|4

CURVE	EB 132	CURVE	WB 132
PI STA.	EB 1123+40.03	PI STA.	WB 1121+96.80
R	2600.00	R	3680.00
Lc	146.50	Lc	282.91
Ls1	130.00	Ls1	110.00
Ls2	130.00	Ls2	110.00*
Eo	2.50"	Eo	1.50*
Eu	2.11"	Eu	1.76*
V	55 MPH	V	55 MPH

DIRECT FIXATION - TUNNEL
SEE DWG L60-KX020

DIRECT FIXATION - TUNNEL
SEE DWG L60-KX021

DIRECT FIXATION - TUNNEL
SEE DWG L60-KX022

DIRECT FIXATION - BRIDGE SEE DWG L60-KX023

SEE DWG L60-KP012

EXISTING TUNNEL CEILING LINE

PCL (T/LR)

EXISTING C/L

L 500.00'

EL 98.59

EL 97.39

EL 97.27

EL 96.03

EL 94.6

EL 92.36

EL 90.8

EL 92.26

EL 89.72

EL 88.1

EL 86.75

EL 85.3

EL 83.41

EL 81.9

EL 83.36

FB 1114+00

FB 1115+00

FB 1118+00

FB 1120+00


FB 1121+00

FB 1124+00


SEE DWG L60-KP014

EB 1114+00	EB 1114+00	EB 1116+00	EB 1120+00	EB 1122+00	EB 1124+00
Designed By: A. BASTASCH Drawn By: F. BOLIMA Checked By: S. METZ Approved By: T. MUDAYANKAVIL	 CH2MHILL	 BOLIMA DRAFTING & DESIGN INC.	 SOUNDTRANSIT		 LINK LIGHT RAIL PROJECT EAST CORRIDOR SEGMENT A TRACK PLAN & PROFILE STA EB 1113+00 TO STA EB 1124+00
No Date Chk Ans Revisions	Submitted:	Date:	Approved:	Date:	Date: 1/26/11
FINAL PE					
					Drawing No.: L60-KP013
					Sheet No.: Rev. 105

DEP: LINDA
LPC: LINDA
ATTN: DEPARTMENT OF PLANNING
DRAFTS: DRAFTS
ATC: ATC
DATE: DATE
X=223m
Y=223m
Z=223m
J=1990
A=1990
C=1990
G=1990
H=1990

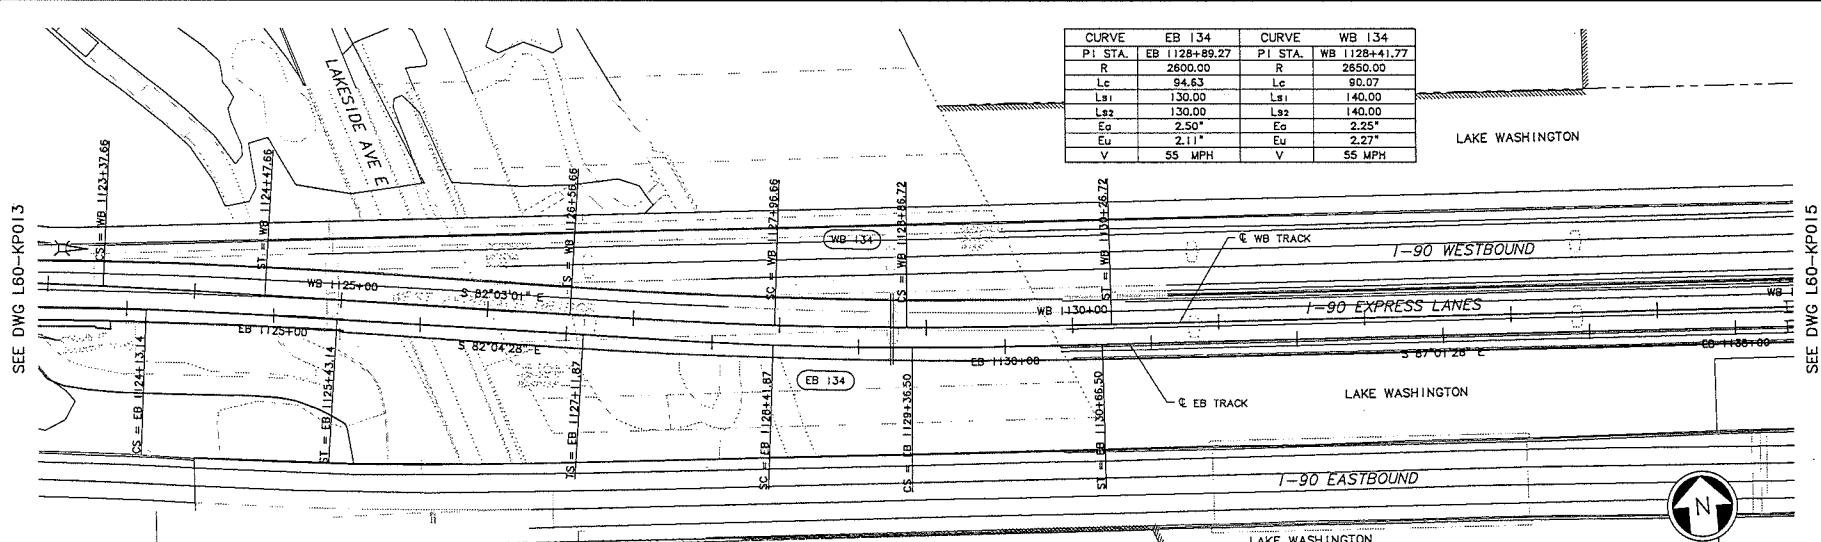

SEE DWG L60-KP015


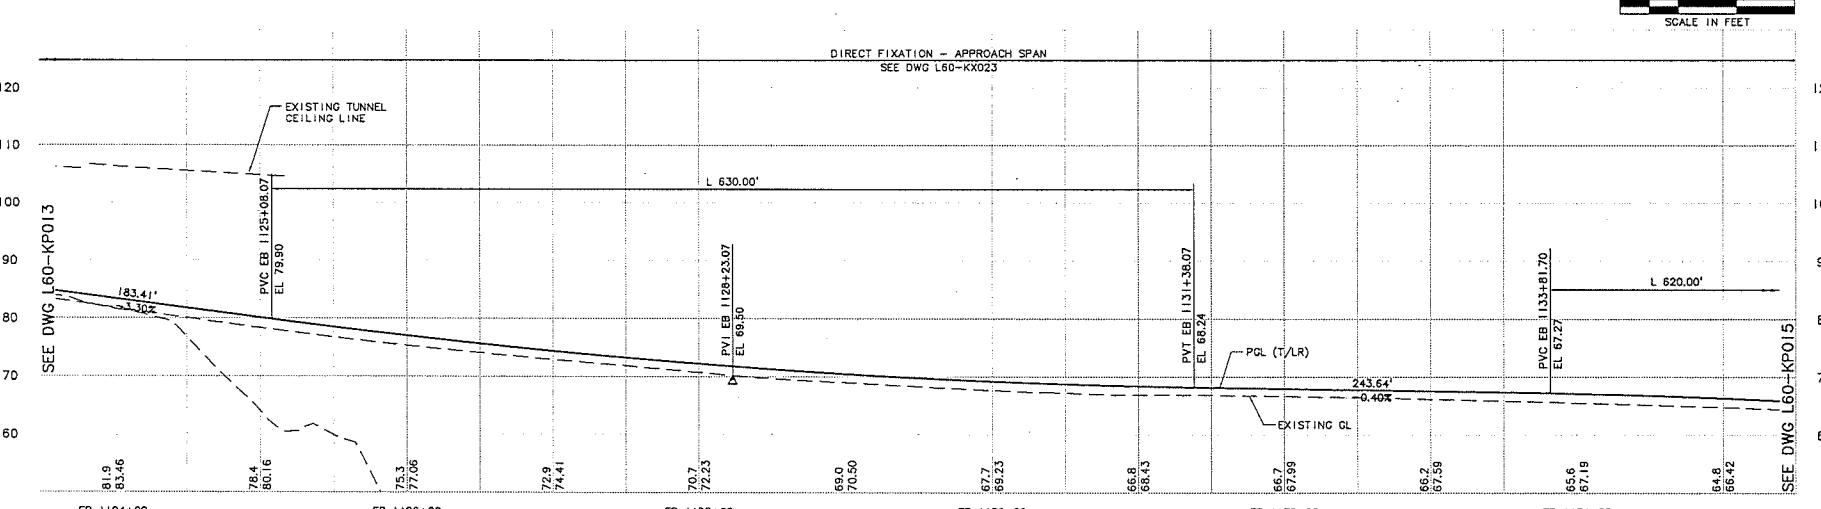


SEE DWG L60-KP013

Designed By:		Drawn By:		Checked By:		Approved By:		Submitted:		Approved:		Date:		Scale:		LINK LIGHT RAIL PROJECT		Drawing No.:		
A. BASTASCH		F. BOLIMA		S. METZ		T. MUDAYANKAVIL										1:40; V: 10'	EAST CORRIDOR	L60-KP014		
	CH2MHILL															1:40; V: 10'	SEGMENT A			
FINAL PE																	TRACK PLAN & PROFILE	STA EB 1124+00 TO STA EB 1135+00		
No.	Date	Des.	Chk.	App.	Revisions												Sheet No.:	106	Rev.:	



SEE DWG L10-KP120

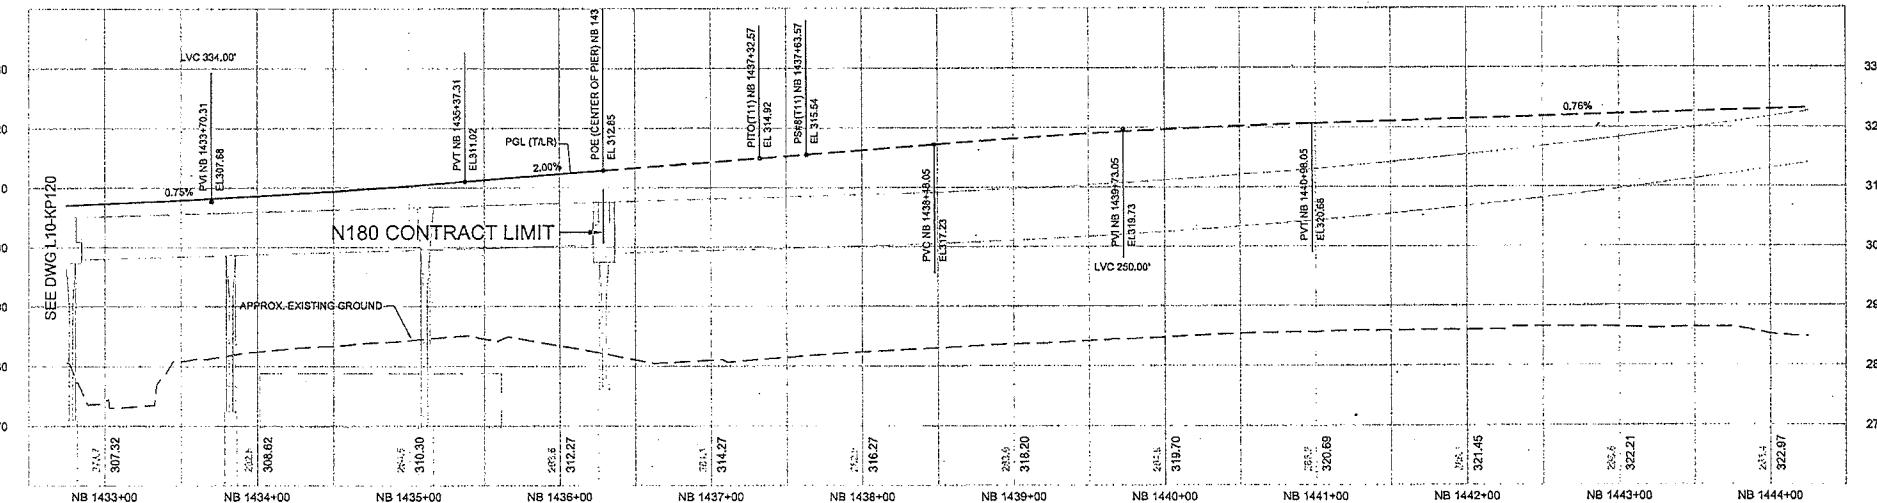
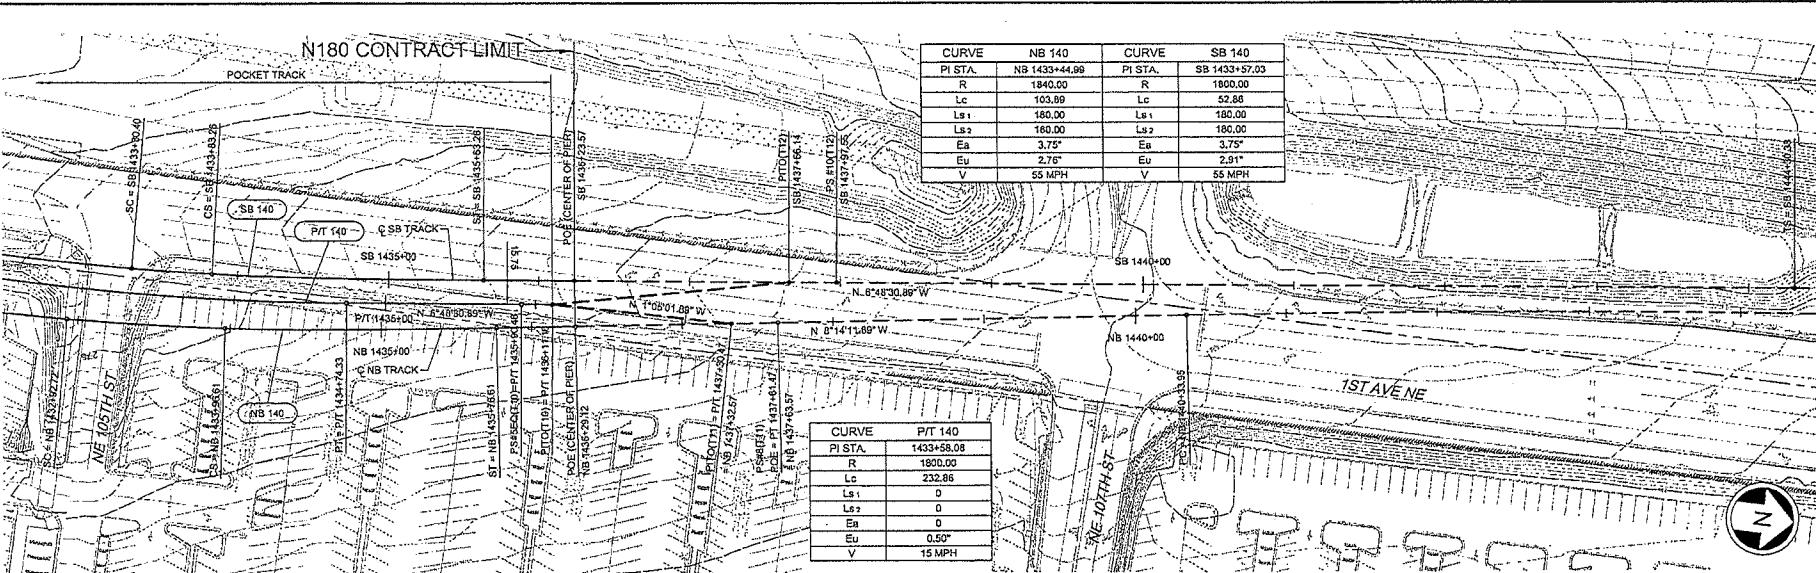


City of Seattle	Designed By: J. GACIARZ	Scale: H:1=40'; V:1=10'	LINK CONTRACT N160 NORTHGATE STATION & Elevated Guideway	Drawing No.: L10-KP121
Work Order No.: Parish No.: Received: Reviewed As Built:	Approved: Drawn By: T. STEWART	File Name: N09_L10_KP121.dwg		Vault Plan No.
SDOT:	Checked By: E. LIBERMAN	Control No.: N160		Sheet No.: 1
Date: 05/10/12	Approved By: A. MARWAHA	Submitted: 10/05/12	Date: 10/05/12	Rev. No.: 0
Date: 05/10/12	Approved By: S. AL-TAMIMI	Date: 10/05/12		


JACOBS ASSOCIATES
Engineering Consultants

**PARSONS
BRINCKERHOFF**
Engineering for Progress


SOUNDTRANSIT

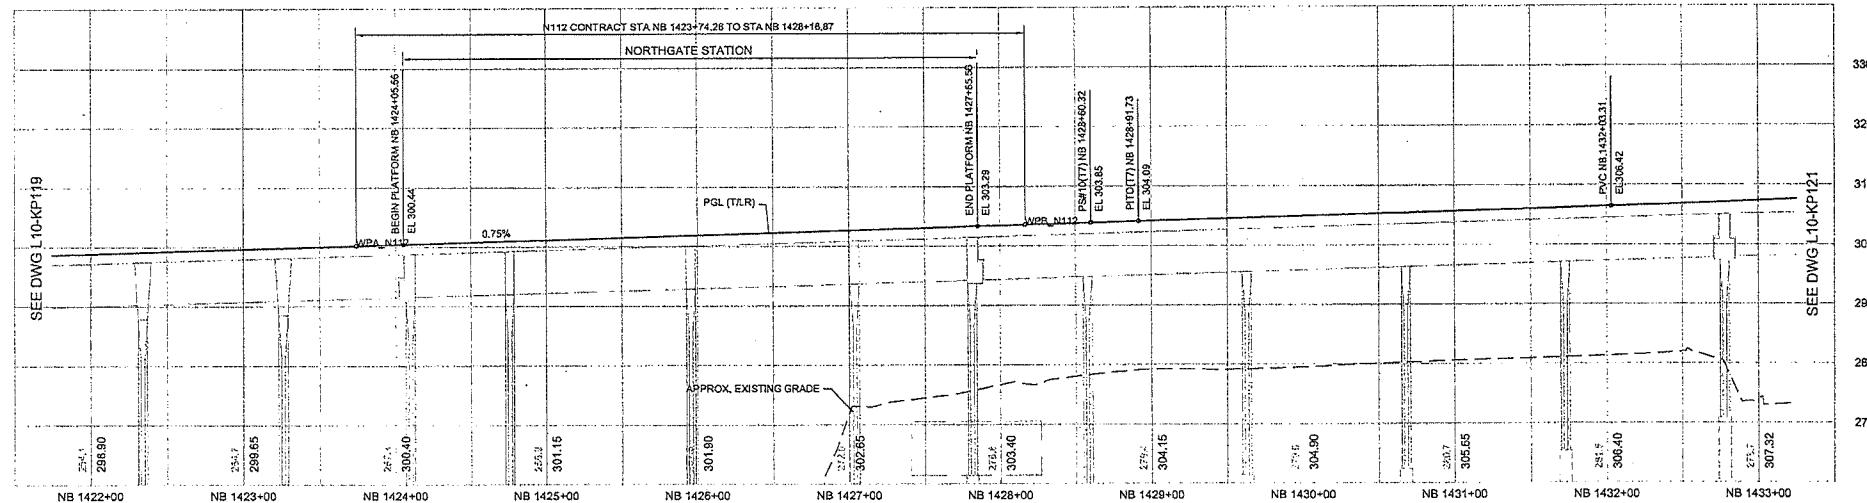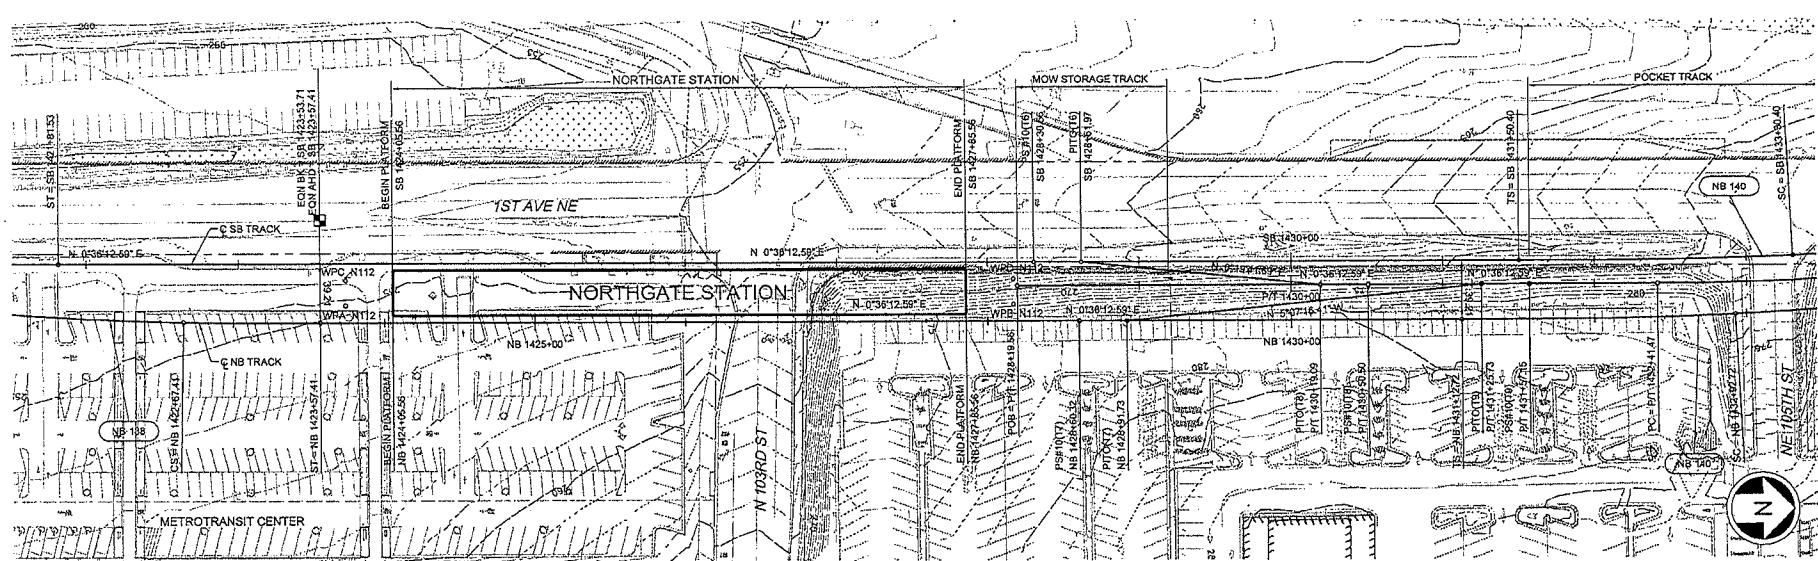

SEE DWG L10-KP118

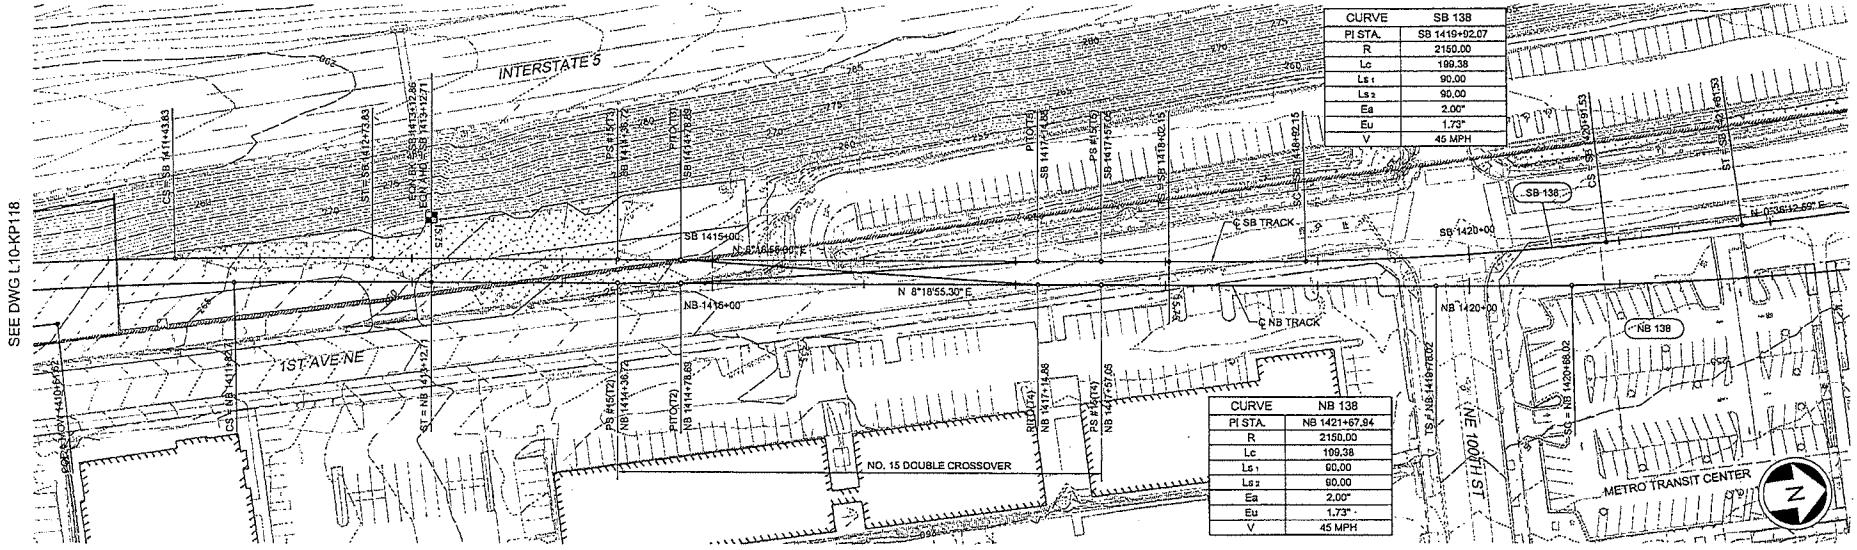

SEE DWG L10-KP120

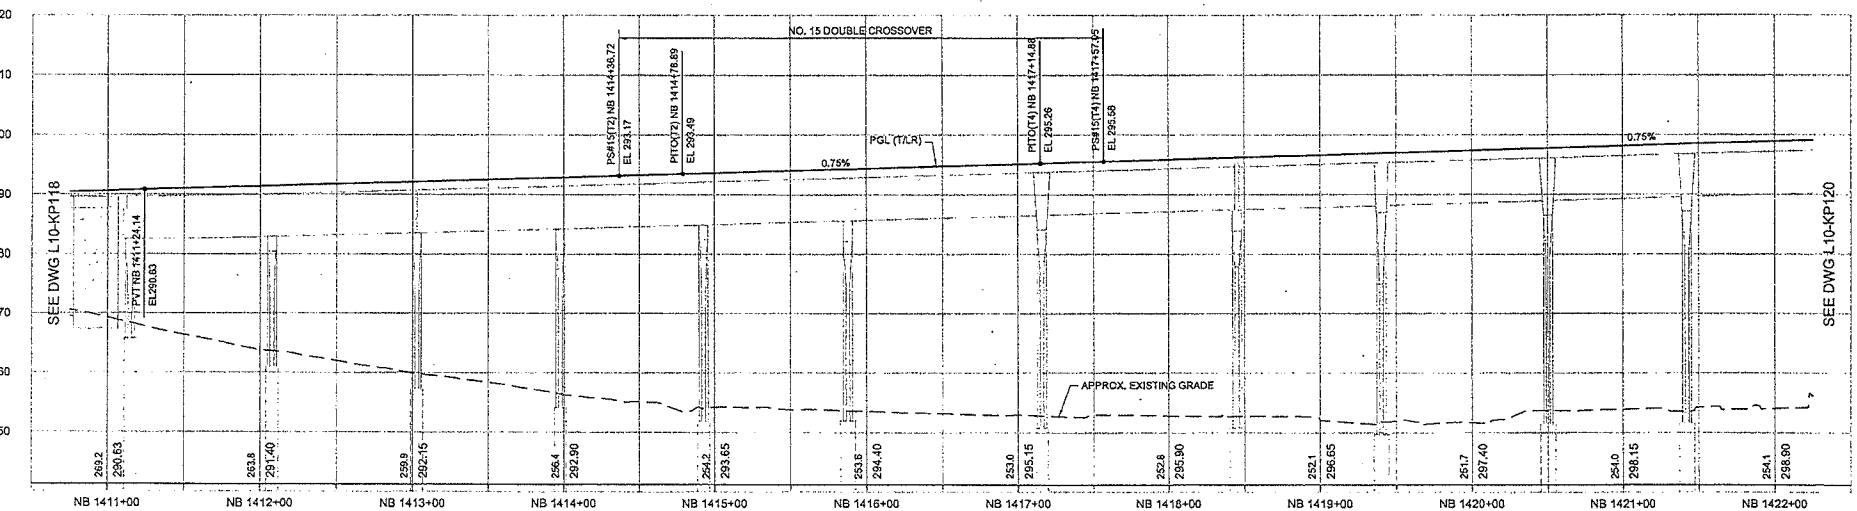


SEE DWG L10-KP120


City of Seattle		Designed By:	J. GACIARZ	Drawn By:	T. STEWART	Engineers/Consultants:	JACOBS ASSOCIATES	Scale:	H:1"=40'; V:1"=10'	LINK CONTRACT N160	Drawing No.:
Work Order No.:	Approved:	Permit No.:	Inspector's Book:	Drawn:	Checked By:	Parsons Brinckerhoff	Sound Transit	File Name:	N00_L10_KP119.dwg	Northgate Station & Elevated Guideway	L10-KP119
Permit No.:	Received:	Revised:	Revised As Built:	Approved:	Approved:	60% SUBMITTAL	60% SUBMITTAL	Contract No.:	N160	TRACK PLAN AND NB PROFILE	Sheet No.:
No.	Date	Drawn	Check	Approved	Revised	Revised As Built	Submitted:	Date:	Approved:	Date:	Row No.:
							I. LAMB	10/05/12	S. AL-TAMMI	10/05/12	0
											3



SEE DWG L10-KP117


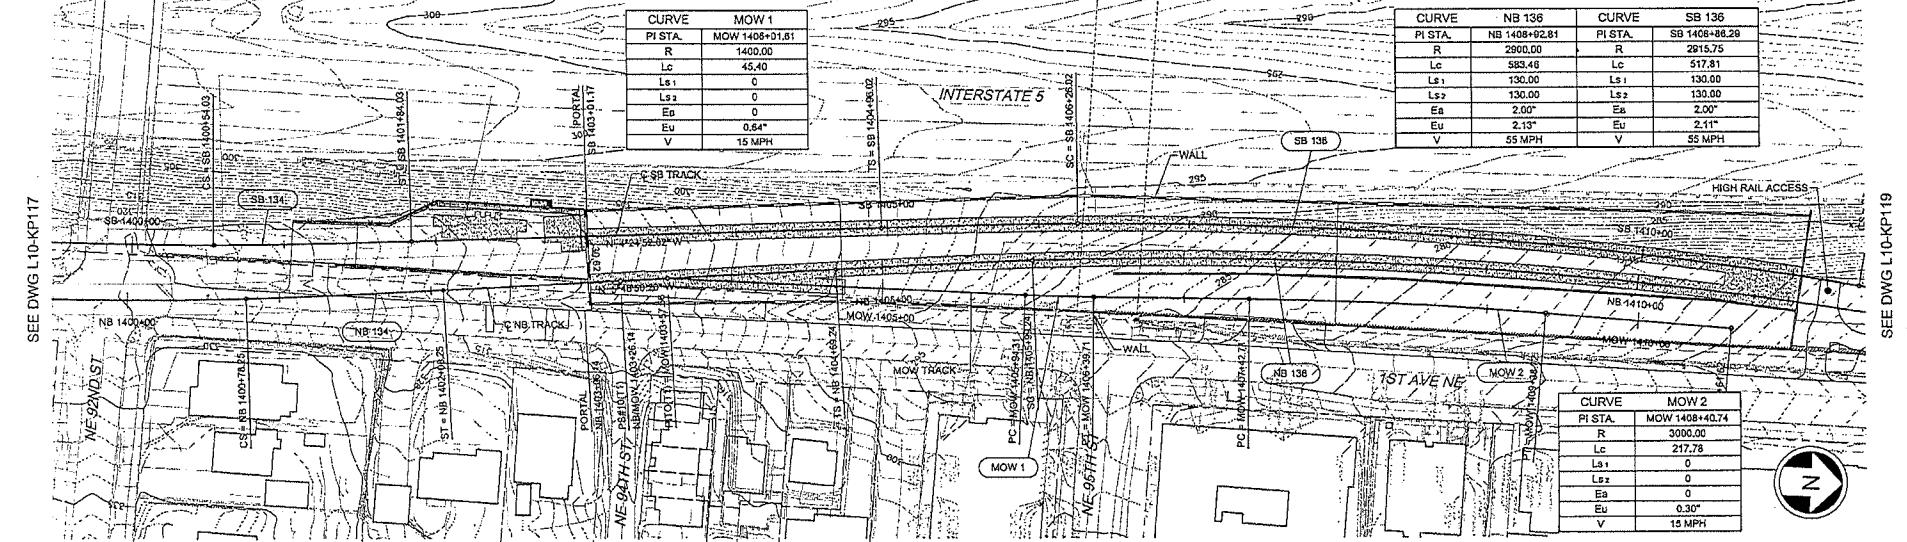


SEE DWG L10-KP119

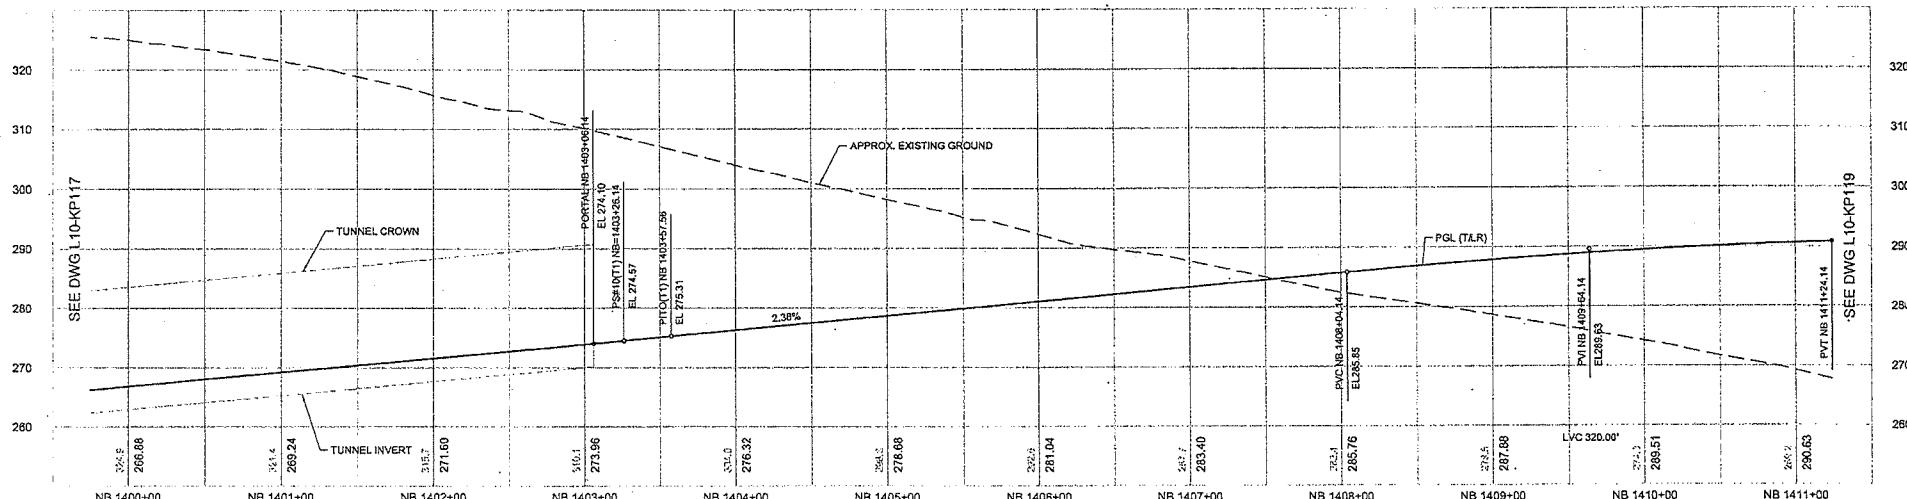

		City of Seattle		Designed By:		JACOBS ASSOCIATES		Scale:		LINK CONTRACT N160		Drawing No.		
Work Order Num.	Approved:	J. GACIARZ		Drawn By:	T. STEWART	Parsons Brinckerhoff	Engineers/Consultants	H:1"=40' V:1"=10'		NORTHGATE STATION & Elevated Guideway		L10-KP118		
Permit No.	Inspector's Book:			Checked By:	E. LIBERMAN	SOUNDTRANSIT	Interim Final Submittal	File Name:	N80_L10_KP118.dwg	Contract No.:	N160	Vault Pkg No.		
				Revised At Audit:	A. MARWAHA	Submitted:	Date:	Approved:	Date:	Date:	10/05/12	Short No.:	4	
SDOT:		Approved By:		Date:		Date:		Date:		Rev. No.:		0		
No.	Date	Doc.	Chk	App.	Revisions									




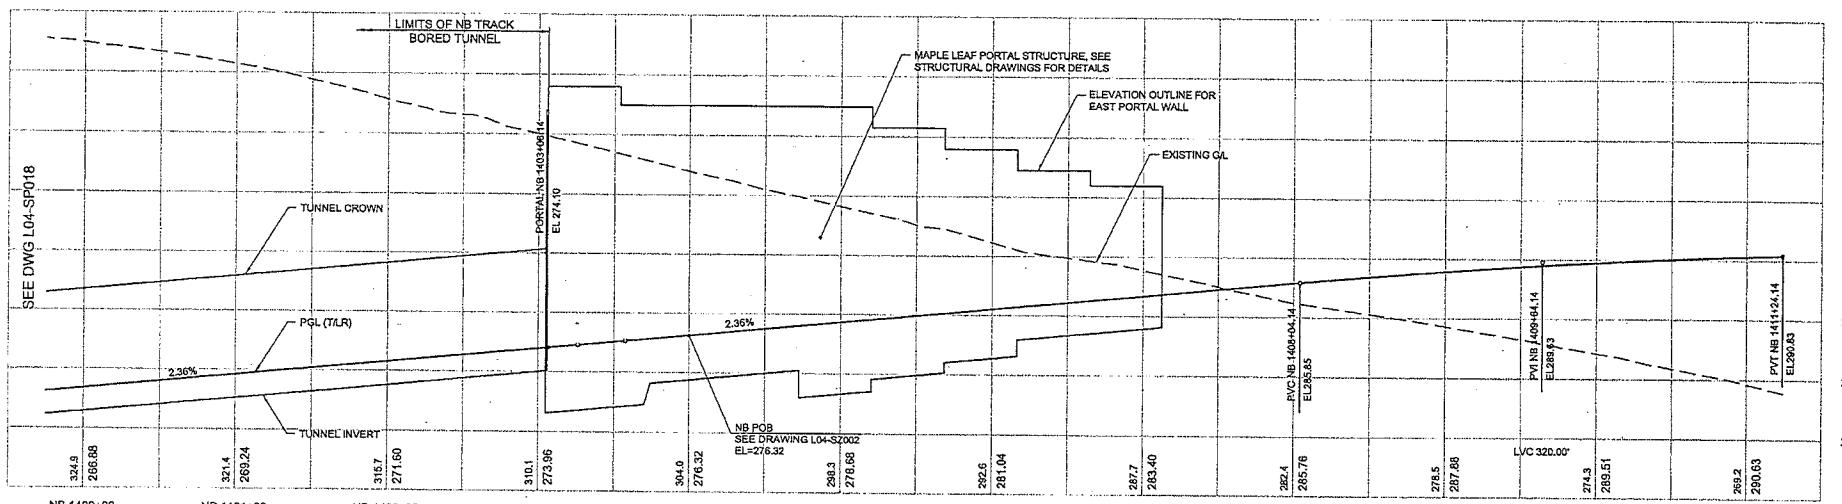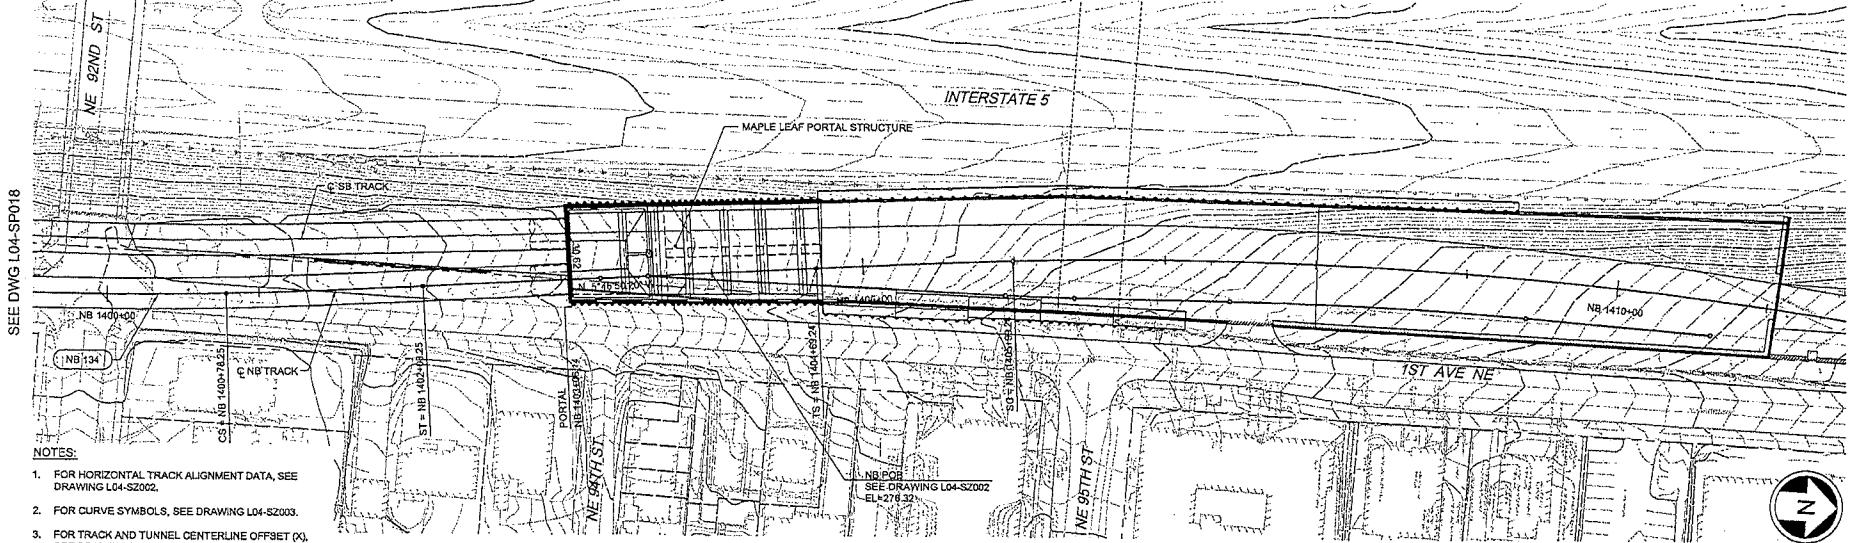


<p>City of Seattle</p> <p>Designed By: S. NJOLOMA Drawn By: A. BYERS Permit No.: Inspector's Doc#: _____ Received: _____ Revised As Built: _____ SDOT: _____ Approved By: A. MENCKE 90% SUBMITTAL</p> <p>JACOBS ASSOCIATES Engineers/Consultants BOLIMA DRAFTING & DESIGN INC. SOUNDTRANSIT</p> <p>Scale: H:1=40' V:1=10' Filename: N25_L04_SP019.dwg Contract No.: N125 Submitted: I. LAMB Date: 09/06/12 Approved: S. AL-TAMIMI Date: 09/06/12</p>												LINK CONTRACT N125 TUNNELS, PORTAL AND STATION EXCAVATIONS	Drawing No. L04-SP019 Vault Plan No. Sheet No. 0 Rev. No. 0		
No.	Date	Des.	Chk.	App.	Revisions										



SEE DWG L04-SP017

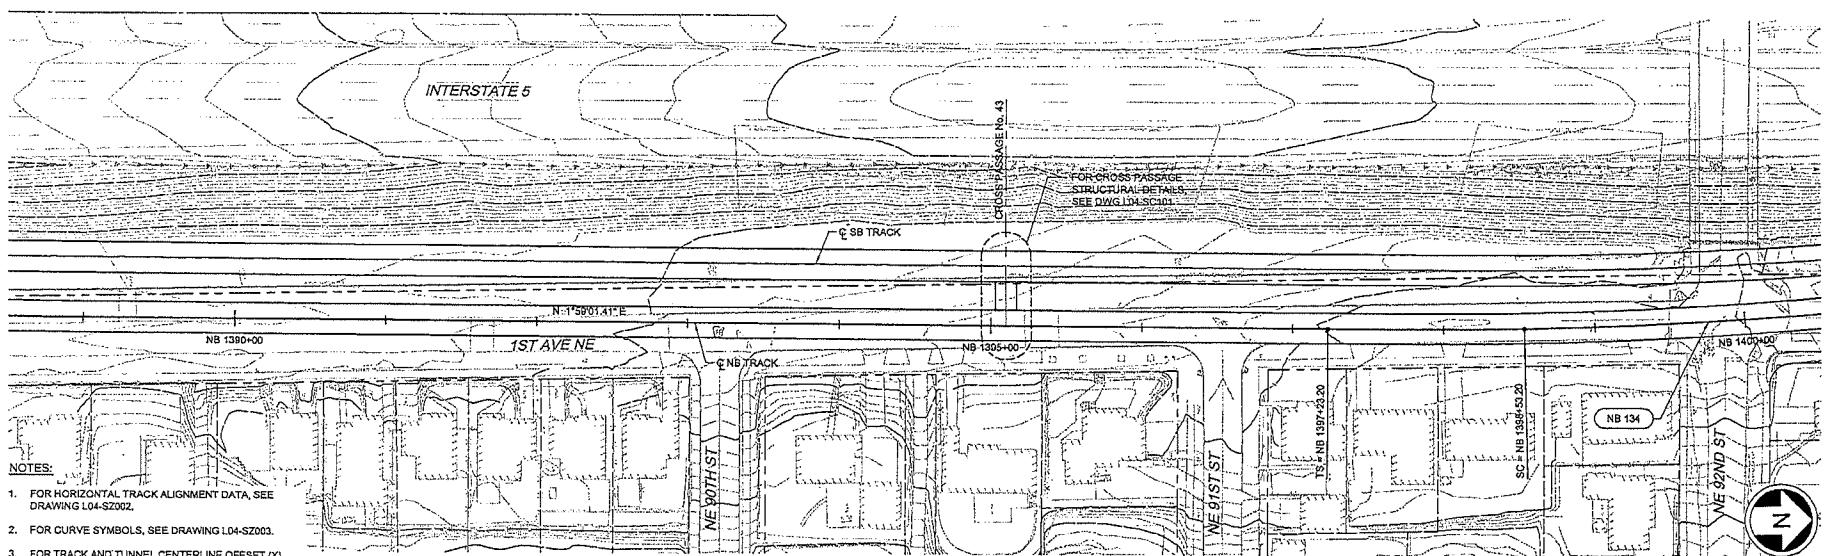

SEE DWG L04-SP019

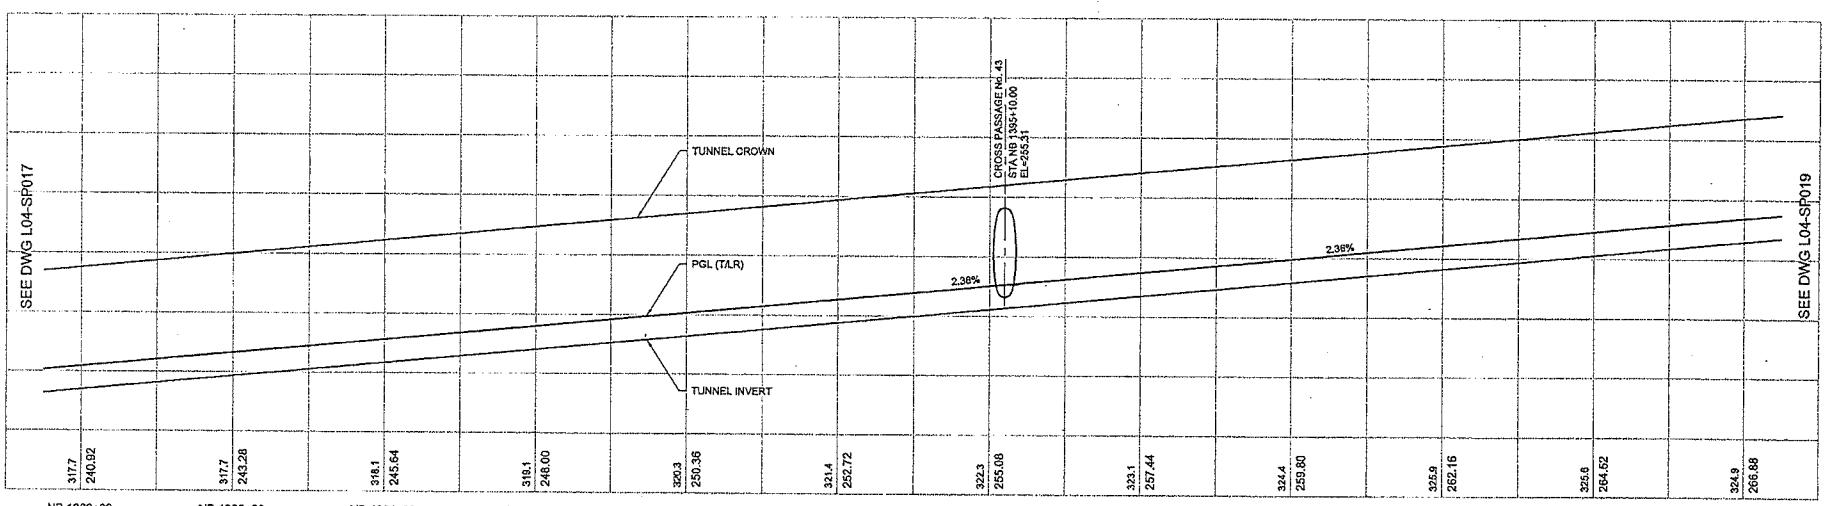

300

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NB 1389+00 NB 1390+00 NB 1391+00 NB 1392+00 NB 1393+00 NB 1394+00 NB 1395+00 NB 1396+00 NB 1397+00 NB 1398+00 NB 1399+00 NB 1400+00

317.7 240.92 319.7 245.64 318.1 246.00 319.1 246.00 320.3 250.36 321.4 252.72 322.3 255.08 323.1 257.44 324.4 259.80 325.0 262.16 325.6 264.62 324.9 265.88

NB 1389+00 NB 1390+00 NB 1391+00 NB 1392+00 NB 1393+00 NB 1394+00 NB 1395+00 NB 1396+00 NB 1397+00 NB 1398+00 NB 1399+00 NB 1400+00

317.7 240.92 319.7 245.64 318.1 246.00 319.1 246.00 320.3 250.36 321.4 252.72 322.3 255.08 323.1 257.44 324.4 259.80 325.0 262.16 325.6 264.62 324.9 265.88

City of Seattle		Designed by:	JACOBS ASSOCIATES	Scale:	LINK CONTRACT N125		Drawing No.
Work Order No.	Approved:	Drawn by:	Engineering/Consultants	H:1"=40'; V:1"=10'	TUNNELS, PORTAL AND STATION EXCAVATIONS	L04-SP018	
Permit No.	Inspector's Book	Checked by:	BOLIMA	Filename:	TUNNEL STRUCTURE		Permit Plan No.
Received:		Revised As Built:	SOUND TRANSIT	Contract No:	STA NB 1389+00 TO STA NB 1400+00		Sheet No.
SDOT:	Approved by:	I. LAMB	Submitted:	Date:	Approved:	Date:	Rev No.
No.	Date	Dim	Clerk	App	Revisions	A. MENCKE	0
						S. AL-TAMIMI	0
				08/06/12		08/06/12	



SEE DWG L04-SP016

CROSS PASSAGE No. 41


FOR CROSS PASSAGE
STRUCTURAL DETAILS
SEE DWG L04-SC101

INTERSTATE 5

FOR CROSS PASSAGE
STRUCTURAL DETAILS
SEE DWG L04-SC101



SEE DWG L04-SP018

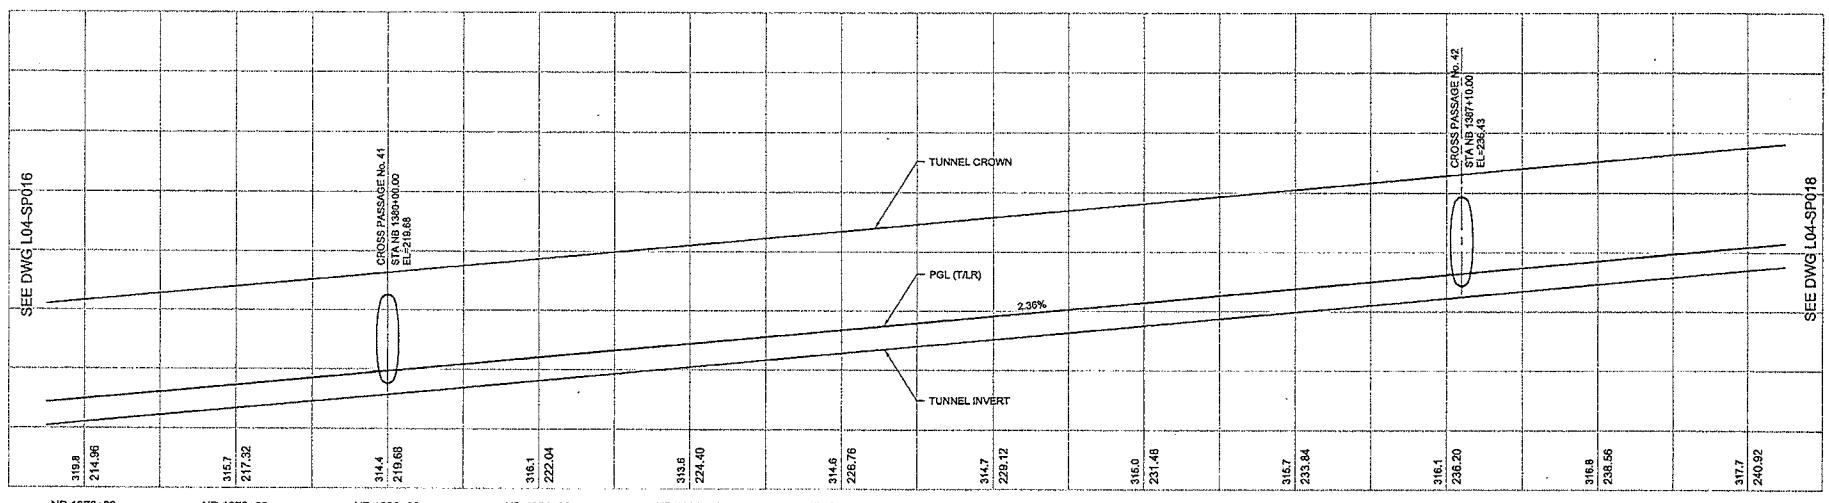

PROJECT NO. DATE DRAWN DRAWER'S NAME

REVISIONS

5

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7

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10

City of Seattle

Work Order No.

Approved:

Designed By:

S. NJOLOMA

Drawn By:

A. BYERS

Permit No.:

Inspector's Book:

Received:

Reviewed:

Revised As Built:

Approved By:

A. MENCKE

Checked By:

A. MENCKE

Approved By:

A. MENCKE

Approved By:

A. MENCKE

Submitted:

I. LAMB

Date:

09/06/12

Approved:

S. AL-TAMIMI

Date:

09/06/12

Date:

09/06/12



JACOB'S ASSOCIATES

Engineers/Consultants

BOLIMA

DRAFTING & DESIGN INC.

90% SUBMITTAL

H-1: H=40'; V=1'=10'

File Name:

N25_L04_SP017.dwg

Contract No.:

N125

SOUNDTRANSIT

Scene:

H:

1:

V:

1:

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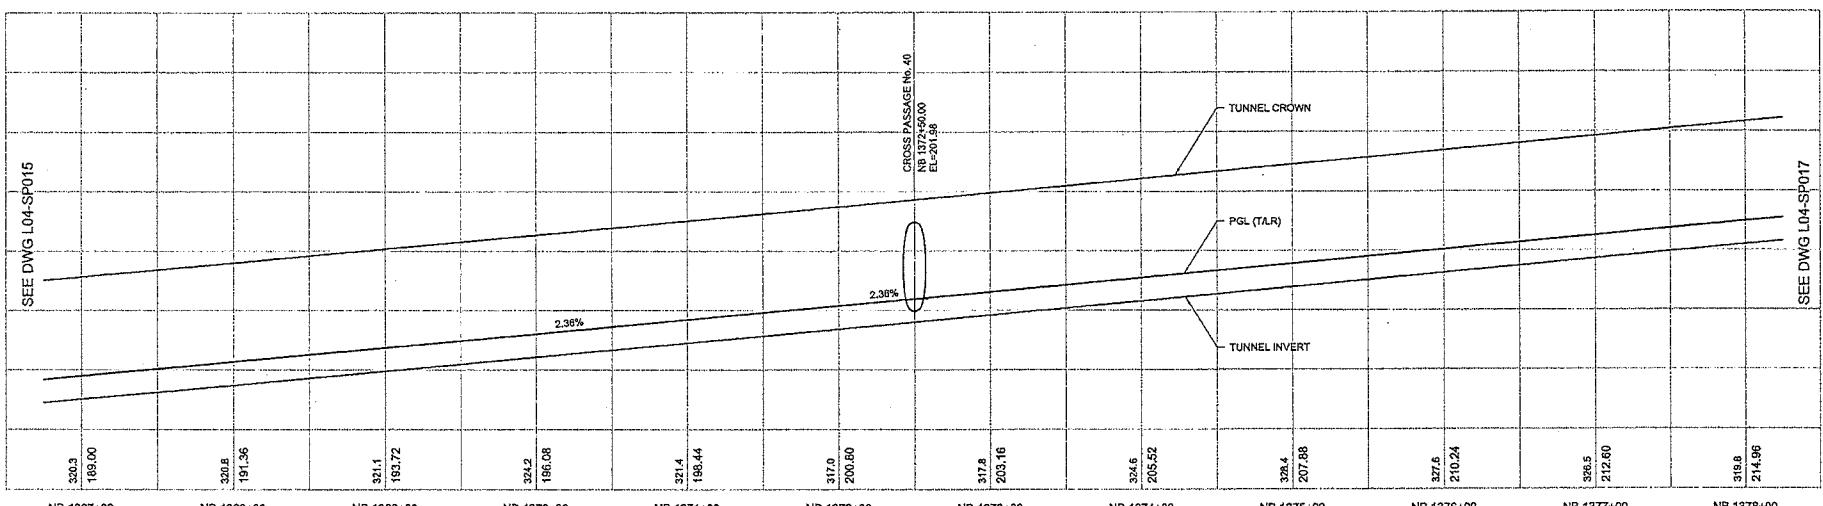
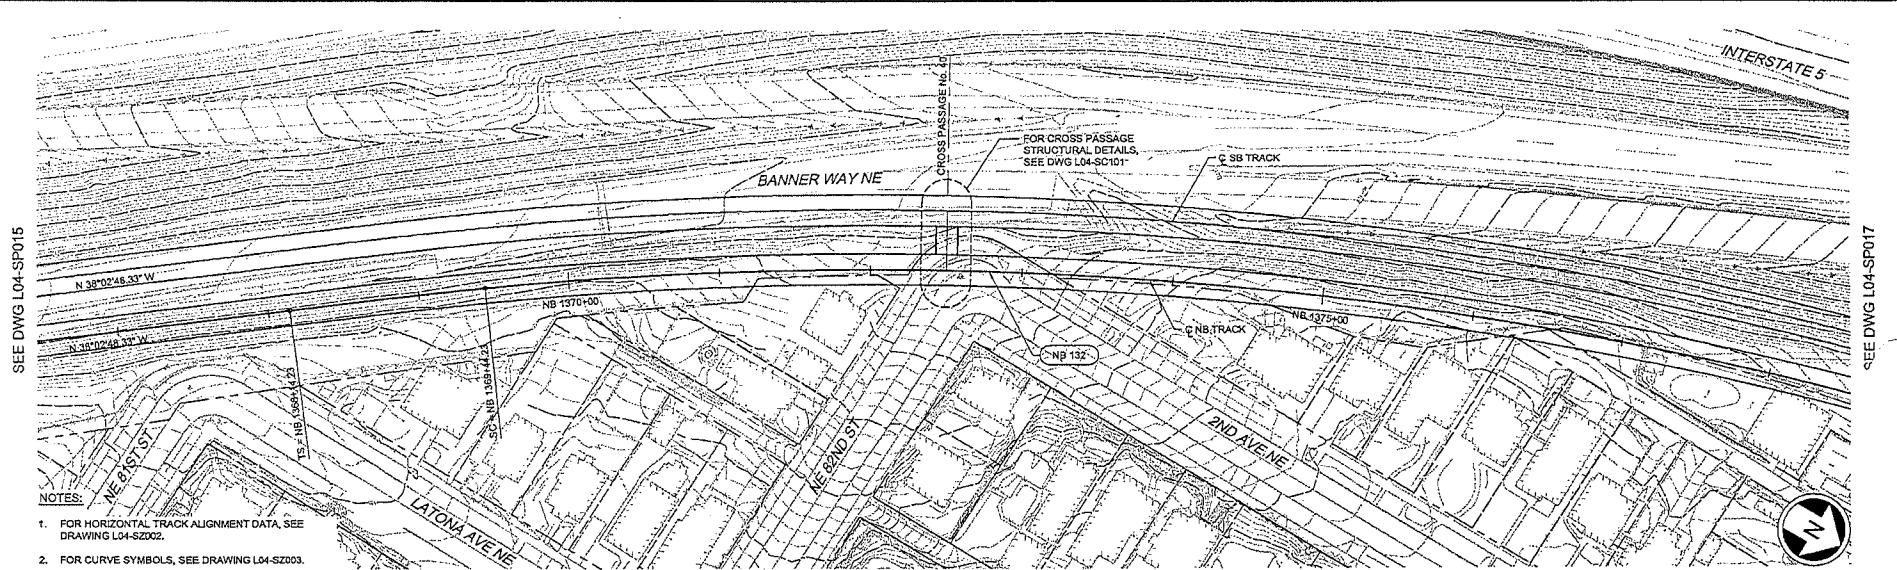
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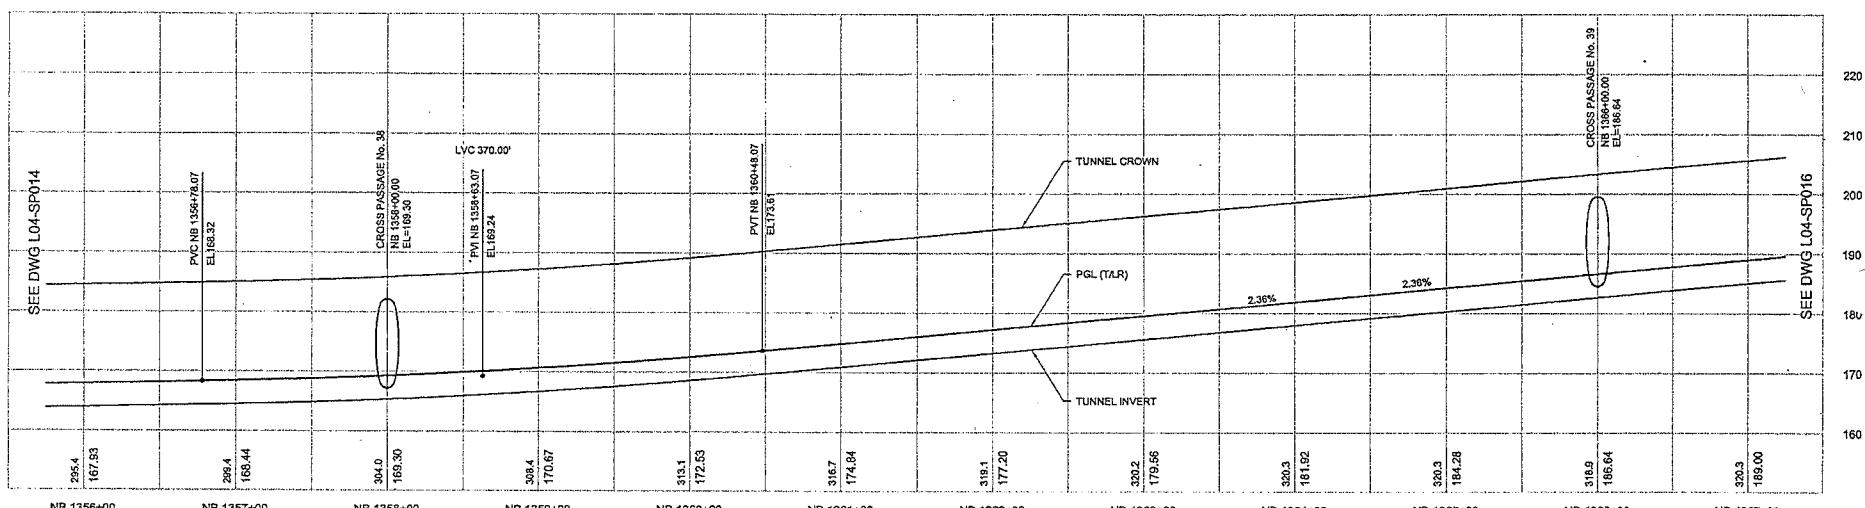
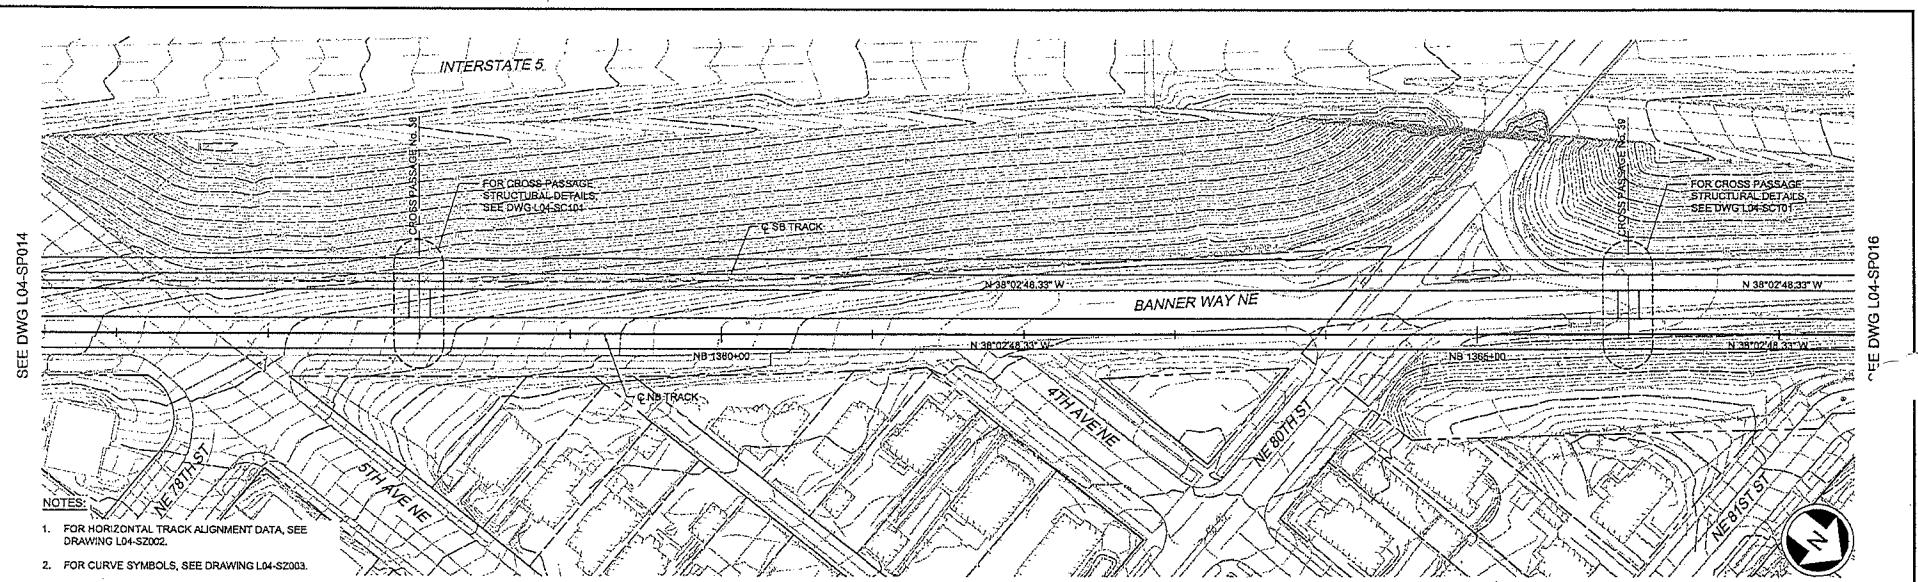
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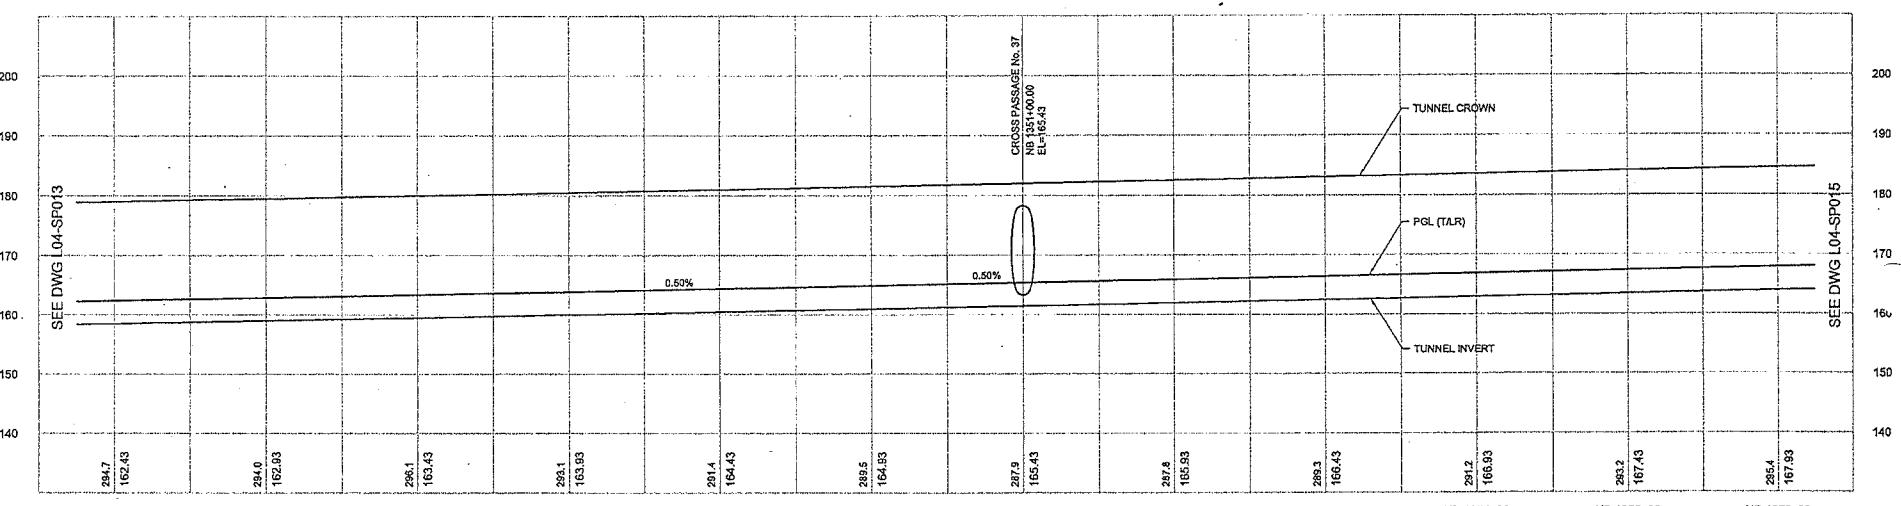
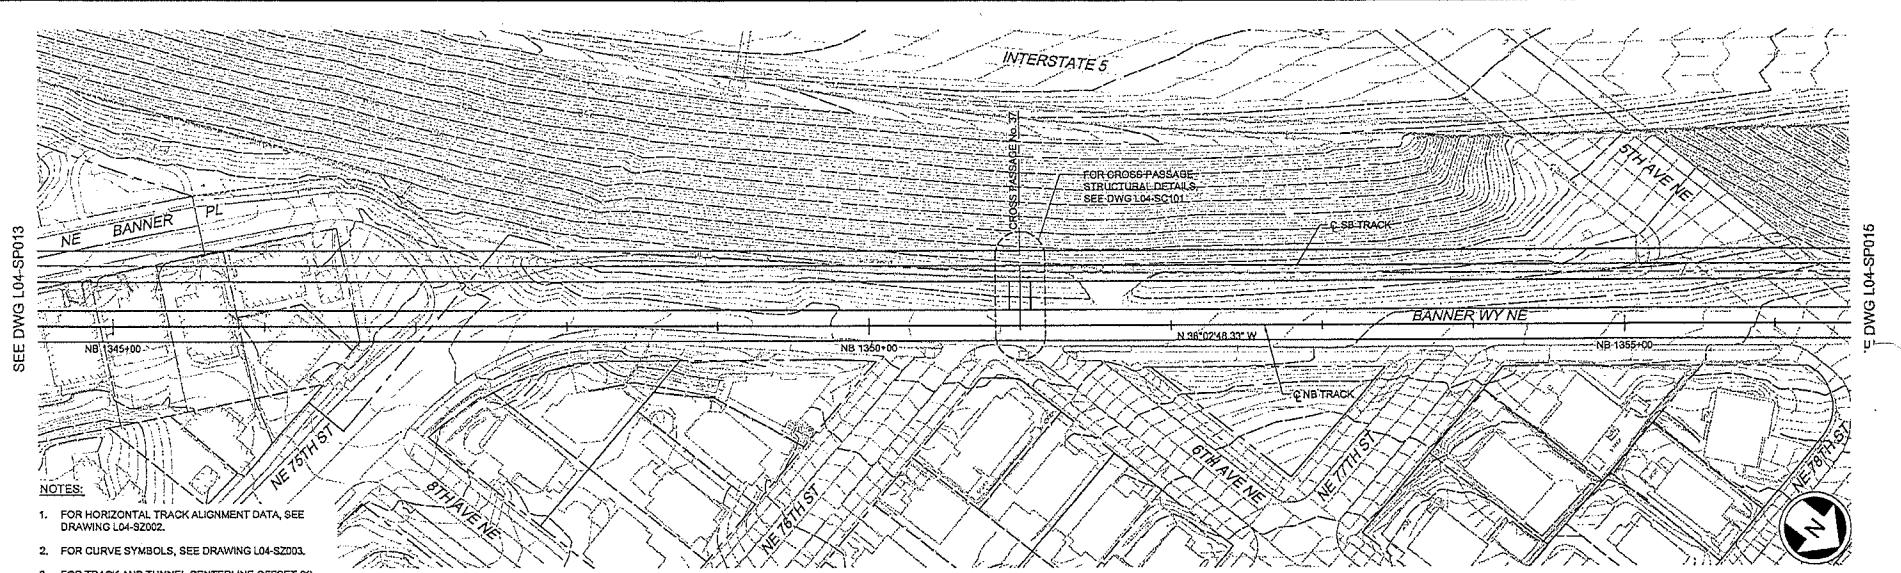


City of Seattle		Designed By: S. NIJOLOMA	JACOBS ASSOCIATES Engineers/Consultants	Scale: H:1"=40' V:1"=10'	LINK CONTRACT N125 TUNNELS, PORTAL AND STATION EXCAVATIONS		Drawing No.: L04-SP016
Work Order No.	Approved:	Drawn By: A. BYERS	BOLIMA DRAFTING & DESIGN INC.	File Name: N125_L04_SP016.dwg	Contact No.: N125	Vault Plan No.	
Permit No.	Inspector's Initials	Checked By: A. MENCKE	Submitted: I. LAMB	Date: 09/06/12	Date: 09/06/12	Sheet No.: 00	
Reviewed As Built:	Approved By: A. MENCKE						
SDOT:							
No.	Date	Drawn	Clerk	App.	Revisions		





City of Seattle				Designed By:	S. NJOLOMA	Drawn By:	A. BYERS	Engineering/Consultants	JACOBS ASSOCIATES	Scope:	H:1"=40'; V:1"=10'	LINK CONTRACT N125	Drawing No.
Work Order No:	Approved:			Permit No:	Inspector's Book:	Received:	Checked By:	BOLIMA DRAFTING & DESIGN INC.	SOUND TRANSIT	Link Contract N125	TUNNELS, PORTAL AND STATION EXCAVATIONS	L04-SP015	
								90% SUBMITTAL	90% SUBMITTAL	File Name:	N25_L04_SP015.dwg	Vault Plan No.	
SDOT:								1. LAMB	Submitted:	Control No:	N125		
No.	Date	Due	Chk	App	Revisions				Date:	Approved:	Date:	STA NB 1356+00 TO STA NB 1367+00	Sheet No. 0 Rev. 0
									09/08/12	S. AL-TAMIMI	09/08/12		



City of Seattle		Designed by: S. NIJOLOMA	<p>JACOBS ASSOCIATES Engineers/Consultants BOLIMA DRAFTING & DESIGN INC.</p> <p>90% SUBMITTAL</p> <p>Submitted: L. LAMB Date: 09/06/12 Approved: S. AL-TAMINI Date: 09/06/12</p> <p>Scale: H:1"=40' V:1"=10' Plan/Sec: N25_L04_SP014.dwg Contract No: N125</p>	LINK CONTRACT N125 TUNNELS, PORTAL AND STATION EXCAVATIONS	Drawing No. L04-SP014	
Work Order No:	Approved:	Drawn by: A. BYERS			Vault Plan No.	
Permit No:	Inspector's Book:	Received:				
		Checked by: A. MENCKE				
		Revised As Date:				
SDOT:	Approved By:	A. MENCKE				
Date:	Drawn:	Chk:		Appr:	Revisions:	

10/2012 15:07:24 PM
DRAFTING & DESIGN INC. DRAFTING & DESIGN INC.

10 0

SEE DWG L04-SP012

CROSS PASSAGE No. 35

FOR CROSS PASSAGE
STRUCTURAL DETAILS,
SEE DWG L04-SC101

NE 71ST ST

NE 72ND ST

(SR 522)

NE 73RD ST

NE 74TH ST

NE 75TH ST

NE 76TH ST

NE 77TH ST

NE 78TH ST

NE 79TH ST

NE 80TH ST

NE 81ST ST

NE 82ND ST

NE 83RD ST

NE 84TH ST

NE 85TH ST

NE 86TH ST

NE 87TH ST

NE 88TH ST

NE 89TH ST

NE 90TH ST

NE 91ST ST

NE 92ND ST

NE 93RD ST

NE 94TH ST

NE 95TH ST

NE 96TH ST

NE 97TH ST

NE 98TH ST

NE 99TH ST

NE 100TH ST

NE 101ST ST

NE 102ND ST

NE 103RD ST

NE 104TH ST

CROSS PASSAGE No. 35

NB 1334+00

EL= 156.83

NB 1335+00

EL= 157.43

NB 1336+00

EL= 157.93

NB 1337+00

EL= 158.43

NB 1338+00

EL= 158.93

NB 1339+00

EL= 159.43

NB 1340+00

EL= 159.93

NB 1341+00

EL= 160.43

NB 1342+00

EL= 160.93

NB 1343+00

EL= 161.43

NB 1344+00

EL= 161.93

NB 1345+00

EL= 162.43

NB 1346+00

EL= 162.93

NB 1347+00

EL= 163.43

NB 1348+00

EL= 163.93

NB 1349+00

EL= 164.43

NB 1350+00

EL= 164.93

NB 1351+00

EL= 165.43

NB 1352+00

EL= 165.93

NB 1353+00

EL= 166.43

NB 1354+00

EL= 166.93

NB 1355+00

EL= 167.43

NB 1356+00

EL= 167.93

NB 1357+00

EL= 168.43

NB 1358+00

EL= 168.93

NB 1359+00

EL= 169.43

NB 1360+00

EL= 169.93

NB 1361+00

EL= 170.43

NB 1362+00

EL= 170.93

NB 1363+00

EL= 171.43

NB 1364+00

EL= 171.93

NB 1365+00

EL= 172.43

NB 1366+00

EL= 172.93

NB 1367+00

EL= 173.43

NB 1368+00

EL= 173.93

NB 1369+00

EL= 174.43

NB 1370+00

EL= 174.93

NB 1371+00

EL= 175.43

NB 1372+00

EL= 175.93

NB 1373+00

EL= 176.43

NB 1374+00

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NB 1375+00

EL= 177.43

NB 1376+00

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NB 1377+00

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NB 1393+00

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NB 1400+00

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NB 1433+00

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NB 1435+00

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NB 1436+00

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NB 1437+00

EL= 208.43

NB 1438+00

EL= 208.93

NB 1439+00

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NB 1441+00

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NB 1443+00

EL= 211.43


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NB 1445+00

EL= 212.43


NB 1



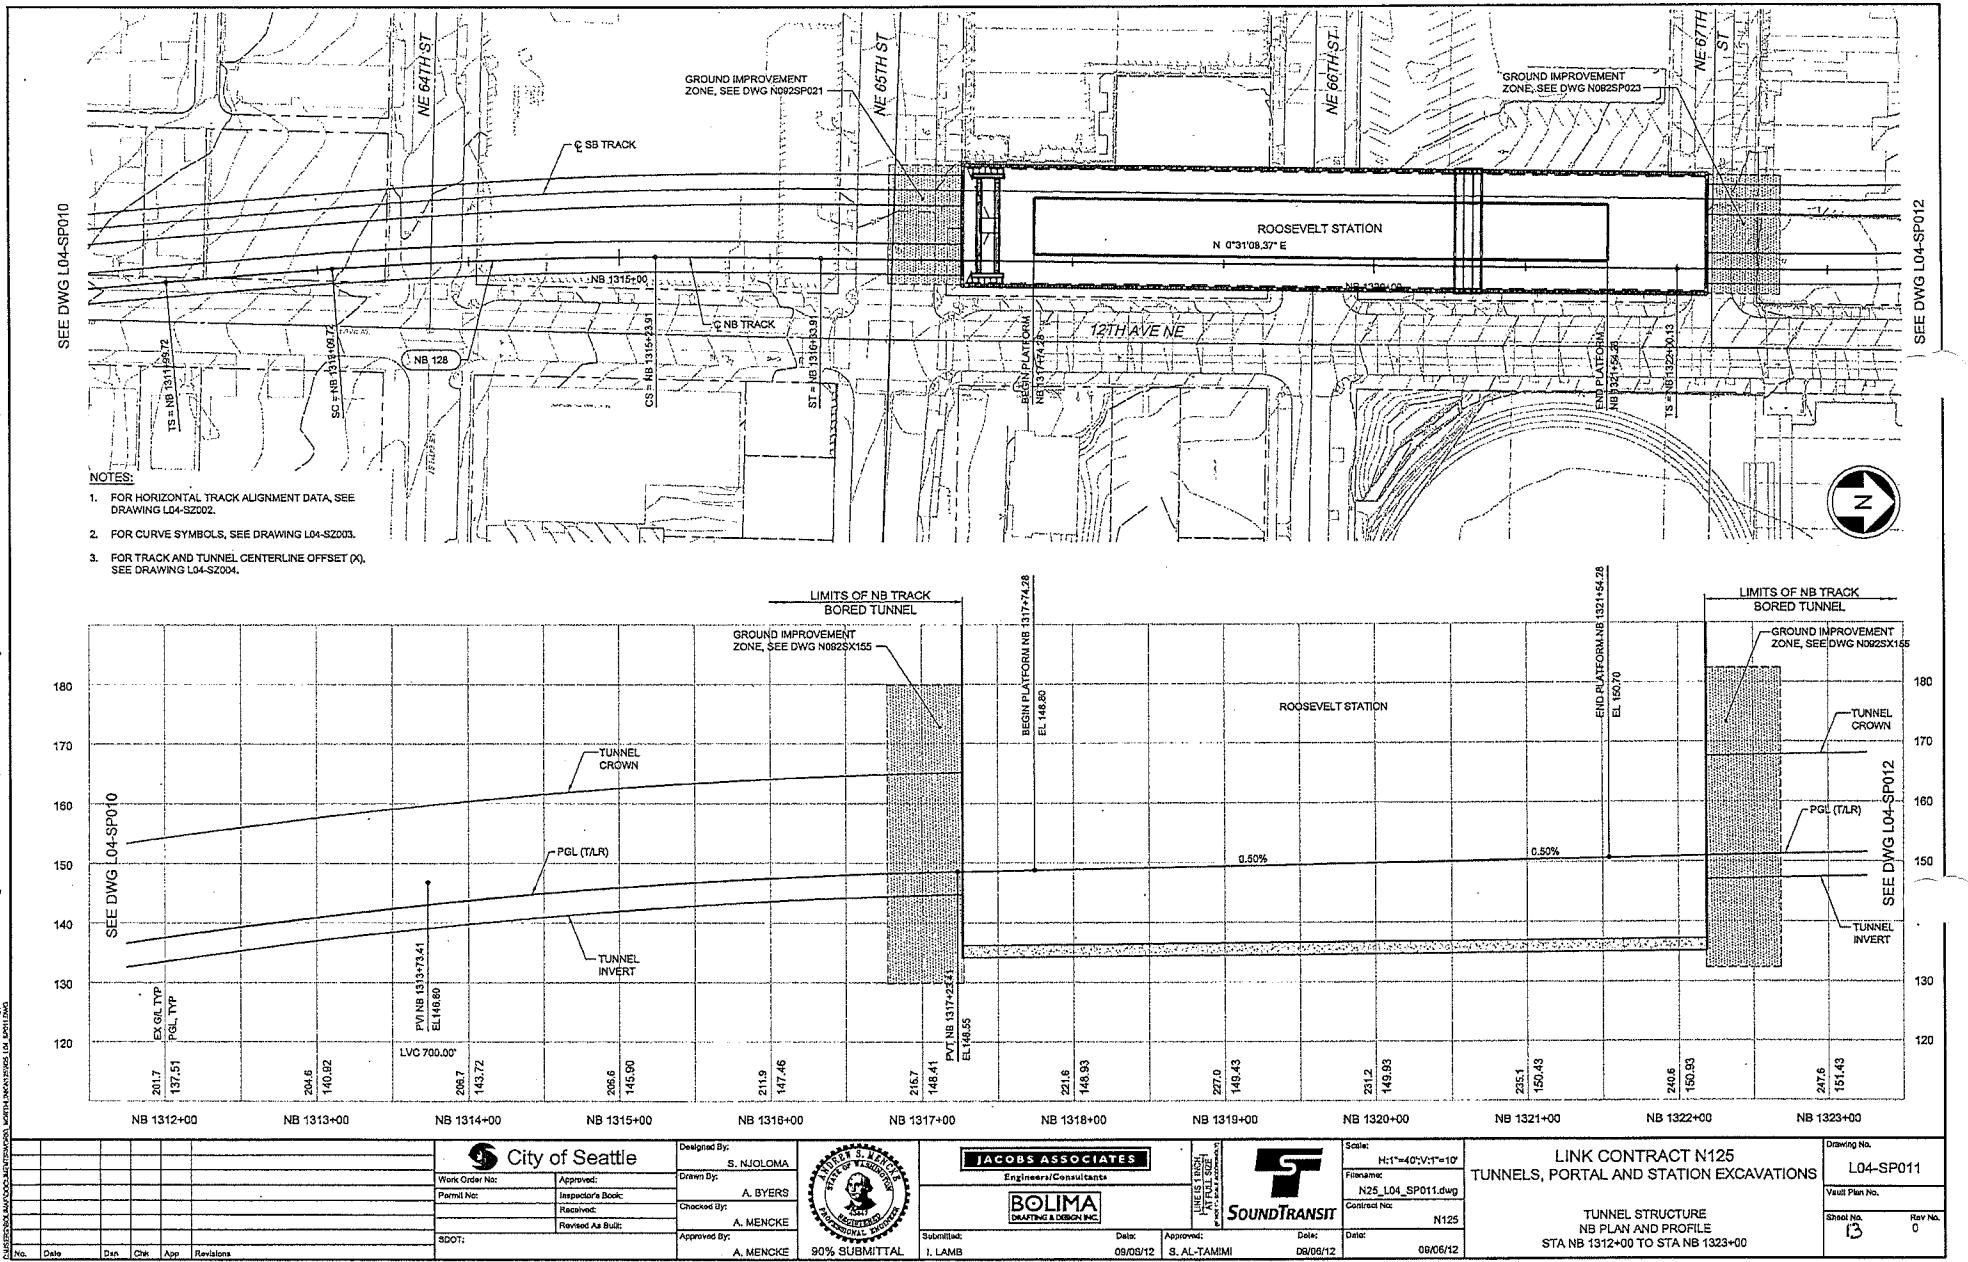

NOTES:

1. FOR HORIZONTAL TRACK ALIGNMENT DATA, SEE DRAWING L04-S2002.
2. FOR CURVE SYMBOLS, SEE DRAWING L04-S2003.
3. FOR TRACK AND TUNNEL CENTERLINE OFFSET (X), SEE DRAWING L04-S2004.

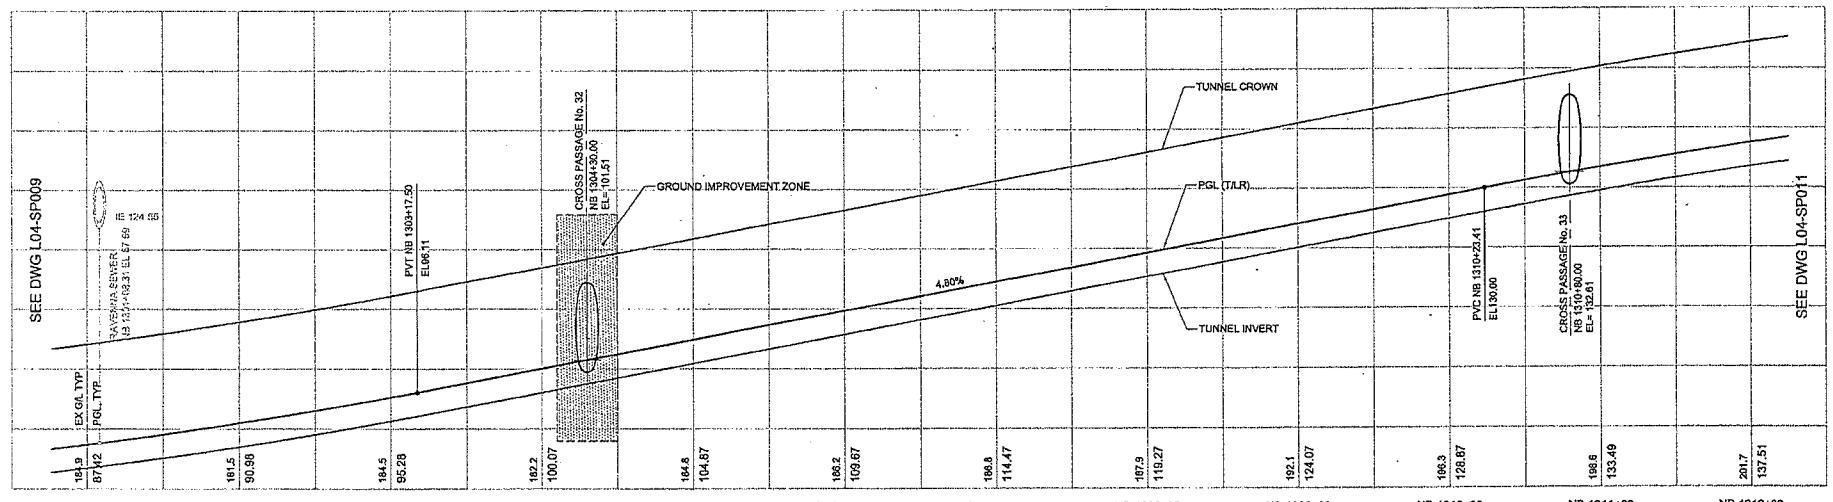

City of Seattle		Designed By: S. NJOLOMA	Drawn By: A. BYERS	JACOBS ASSOCIATES Engineers/Consultants	Submitted By: BOLIMA DRAFTING & DESIGN INC.	Reviewed By: A. MENCKE	Approved By: A. MENCKE	Date: 09/06/12	Approved: S. AL-TAMIMI	Date: 09/06/12	Date: 09/06/12	LINK CONTRACT N125 TUNNELS, PORTAL AND STATION EXCAVATIONS TUNNEL STRUCTURE NB PLAN AND PROFILE STA NB 1301+00 TO STA NB 1312+00	Drawing No.: L04-SP010				
Work Order No:	Approved:	Drawn By:	A. BYERS	JACOBS ASSOCIATES Engineers/Consultants	BOLIMA DRAFTING & DESIGN INC.	Reviewed By:	A. MENCKE	Submitted:	I. LAMB	Date:	09/06/12	Approved:	S. AL-TAMIMI	Date:	09/06/12	Date:	09/06/12
Permit No:	Inspectors Book:	Received:	Checked By:	Approved By:	90% SUBMITTAL	Revised As Built:	Approved By:	Submittal:	I. LAMB	Date:	09/06/12	Approved:	S. AL-TAMIMI	Date:	09/06/12	Date:	09/06/12

842011 12:14 PM
Engineering and Construction Services





SEE DWG L04-SP011

SEE DWG L04-SP011


Rev. No.
0

Sheet No.
14

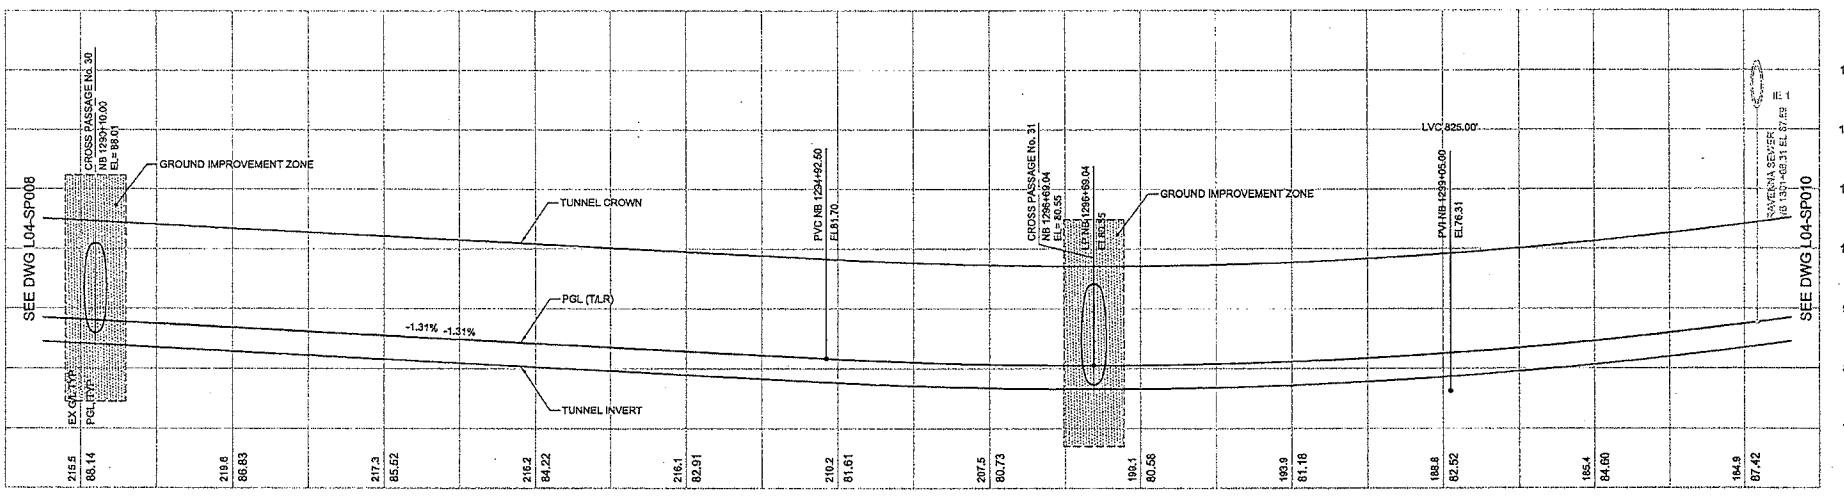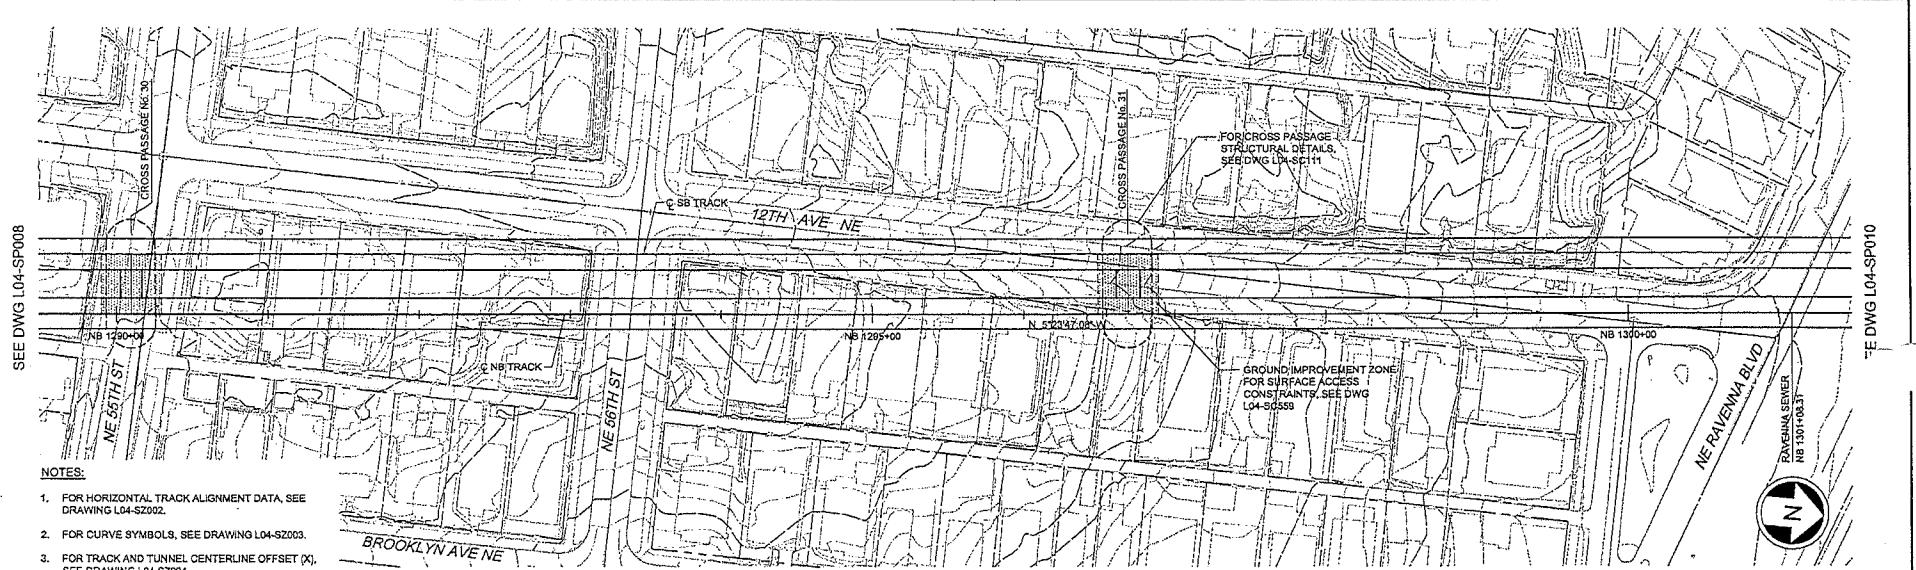

REMARKS		DRAWING NUMBER									
64-2012 12-24-12 PM		LINK CONTRACT N125 TUNNELS, PORTAL AND STATION EXCAVATIONS									
ECLIPSE DOCUMENT MANAGEMENT SYSTEM - DO NOT ALTER		Drawing No. L04-SP009									
Vault Plan No.		Vault Plan No.									
Date	Des	Chk	App	Revisions	SDOT:	Approved By: A. MENCKE	Submitted: I. LAMB	Date: 09/06/12	Approved: S. AL-TAMIMI	Date: 09/06/12	Date: 09/06/12
Designed by: S. NIJOLIMA	Approved: A. BYERS	Drawn by: A. BYERS	JACOBS ASSOCIATES Engineers/Consultants		H:11°40'0" V:1°10"		LINK CONTRACT N125 TUNNELS, PORTAL AND STATION EXCAVATIONS		Drawing No. L04-SP009		
Work Order No:	Inspector's Book:	Checked by:	BOLIMA DRAFTING & DESIGN INC.		File Name: N125_L04_SP009.dwg		Contract No: N125		Vault Plan No.		
Permit No:	Race Line:	Revised As Built:	SUBMITTAL DATE: 09/06/12		Date: 09/06/12		Date: 09/06/12		Sheet No. 15		
Reviewed by: A. MENCKE	Approved by: A. MENCKE	90% SUBMITTAL	Date: 09/06/12		Approved: S. AL-TAMIMI		Date: 09/06/12		Rev No. 0		



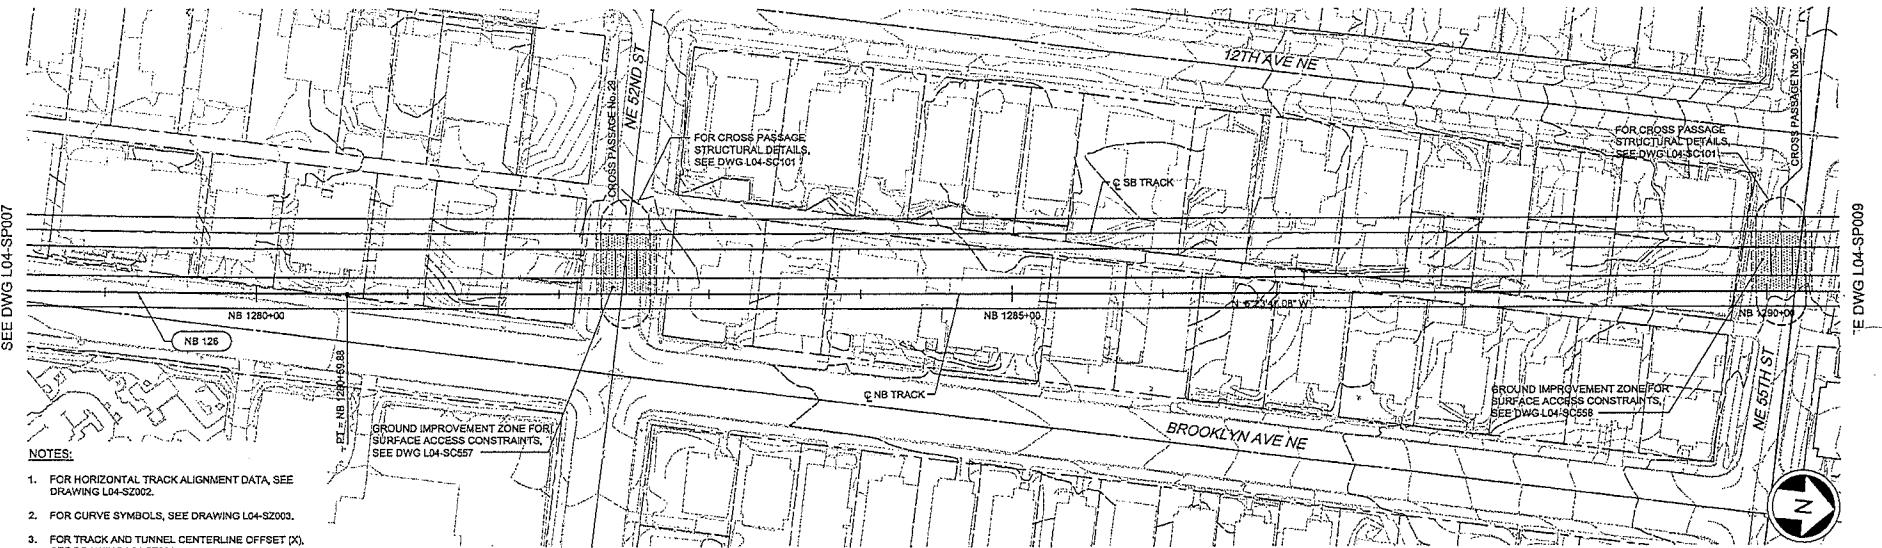


SEE DWG L04-SP007

NOTES:

1. FOR HORIZONTAL TRACK ALIGNMENT DATA, SEE DRAWING L04-S2002.
2. FOR CURVE SYMBOLS, SEE DRAWING L04-S2003.
3. FOR TRACK AND TUNNEL CENTERLINE OFFSET (X), SEE DRAWING L04-S2004.

TE DWG L04-SP009

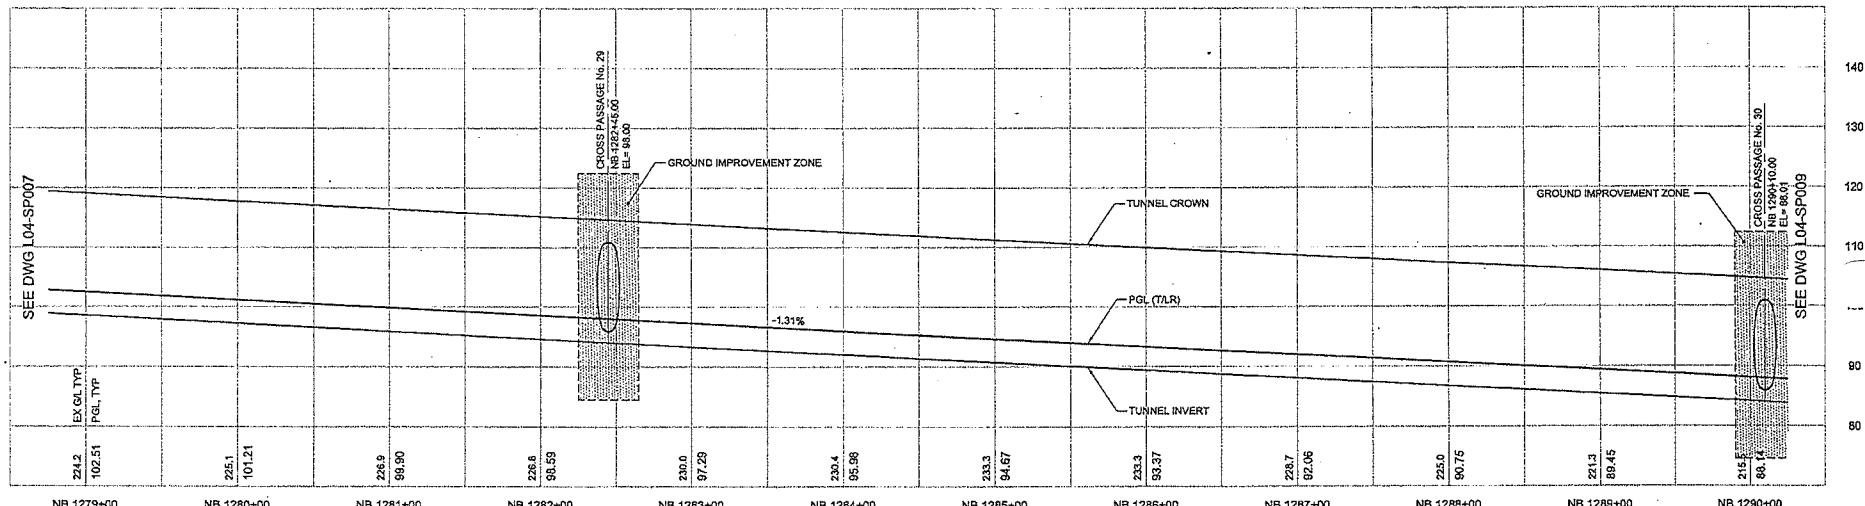

SEE DWG L04-SP007

CROSS PASSAGE No. 30
NB 1287+00
El = 88.00

SEE DWG L04-SP009

LINK CONTRACT N125
TUNNELS, PORTAL AND STATION EXCAVATIONS
TUNNEL STRUCTURE
NB PLAN AND PROFILE
STA NB 1279+00 TO STA NB 1290+00


Drawing No.
L04-SP008
Vault Plan No.
Sheet No. 16
Rev No. 0

City of Seattle

Work Order No:	Approved
Permit No:	Inspector's Book:
	Received:
	Revised As Built:
SDOT:	Approved By:


Designed by: S. NJOLOMA	Drawn by: A. BYERS
Reviewed by: A. MENCKE	Approved by: A. MENCKE
90% SUBMITTAL	

JACOBS ASSOCIATES Engineers/Consultants	SOUNDTRANSIT Contract No. N125
BOLIMA DRAFTING & DESIGN INC.	
Submitted by: I. LAMB	Date: 09/06/12
	Approved: S. AL-TAMIMI
	Date: 09/06/12

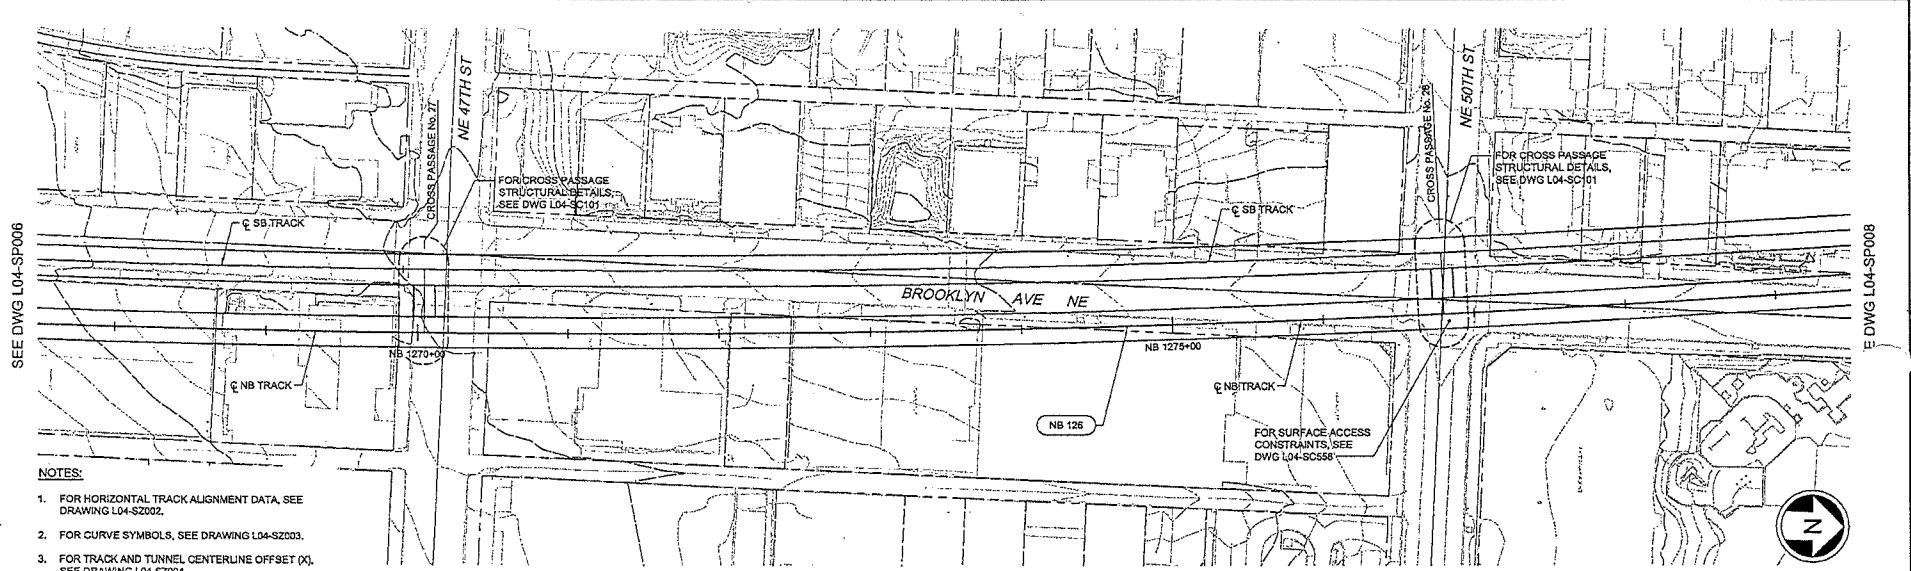


NOTES:

1. FOR HORIZONTAL TRACK ALIGNMENT DATA, SEE DRAWING L04-SZ002.
2. FOR CURVE SYMBOLS, SEE DRAWING L04-SZ003.
3. FOR TRACK AND TUNNEL CENTERLINE OFFSET (X), SEE DRAWING L04-SZ004.

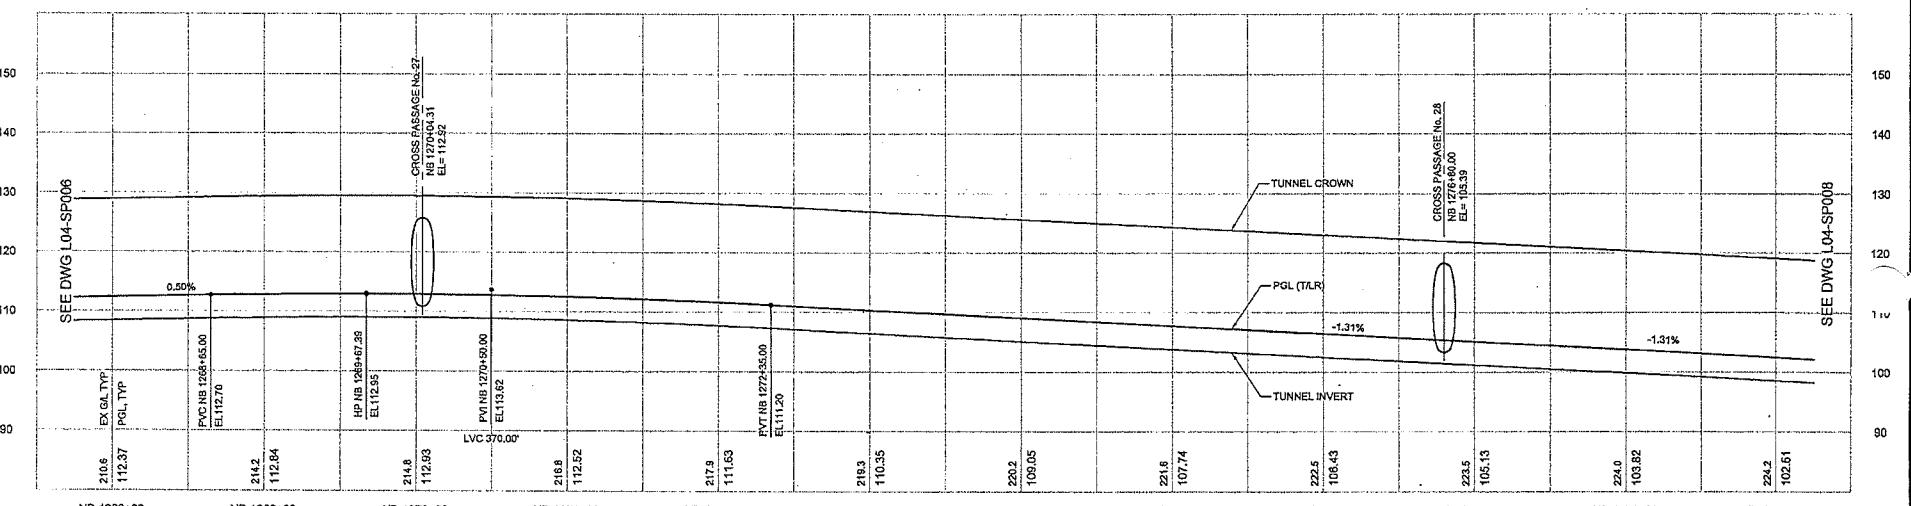

City of Seattle		Designed By:	S. NJOLOMA	Drawn By:	A. BYERS	Approved By:	A. MENCKE	JACOBS ASSOCIATES	Engineers/Consultants	BOLIMA	LINK CONTRACT N125	TUNNELS, PORTAL AND STATION EXCAVATIONS	Drawing No.
Work Order No:	Approved:	Drawn By:		Patent No:	Inspector's Book:	Received:	Revised As Built:	Submitted:	Date:	Approved:	Contract No:	Link Contract N125	L04-SP007
								I. LAMB	09/06/12	S. AL-TAMIMI	N125	TUNNEL STRUCTURE	Vault Plan No.
SDOT:												STA NB 1268+00 TO STA NB 1278+00	Sheet No.
No.	Date	Date	Chk	App	Revisions								Rev No.



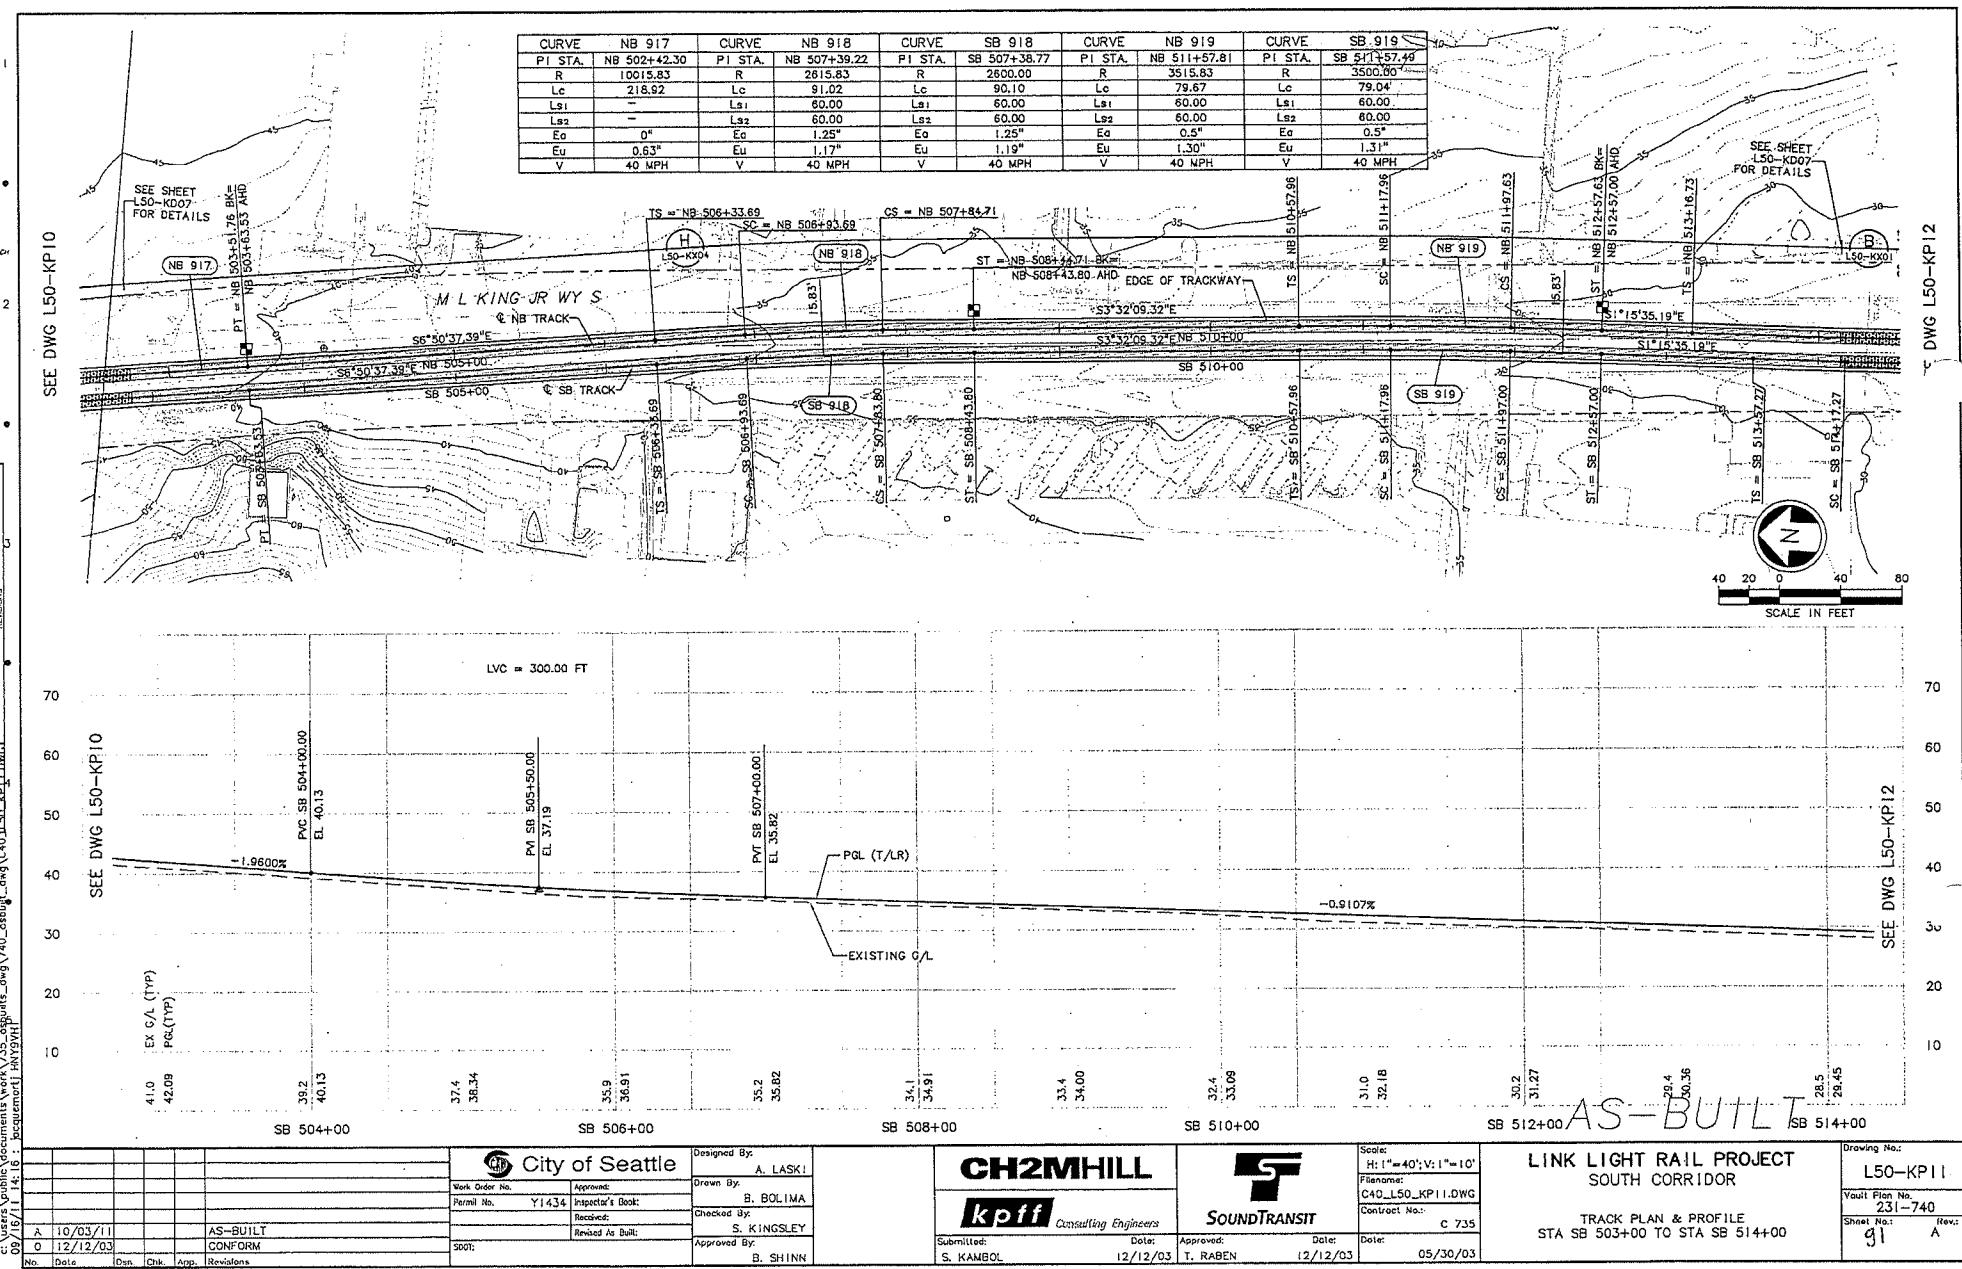


DING-DONG
LISCALE:
1-1
RECALL:
-Alloc
1C-G20020
-Proteas
C40_150_MA
C40_R40_CA
X200CN
X200CR
X200RX
X200SF
1C-77345EAC
-Microphones

[مکتبہ ملک نویں] ۷۶۵ سے ۷۸۰ تک مکتبہ ملک نویں

SEE DWG L50-KP11

40
30
20

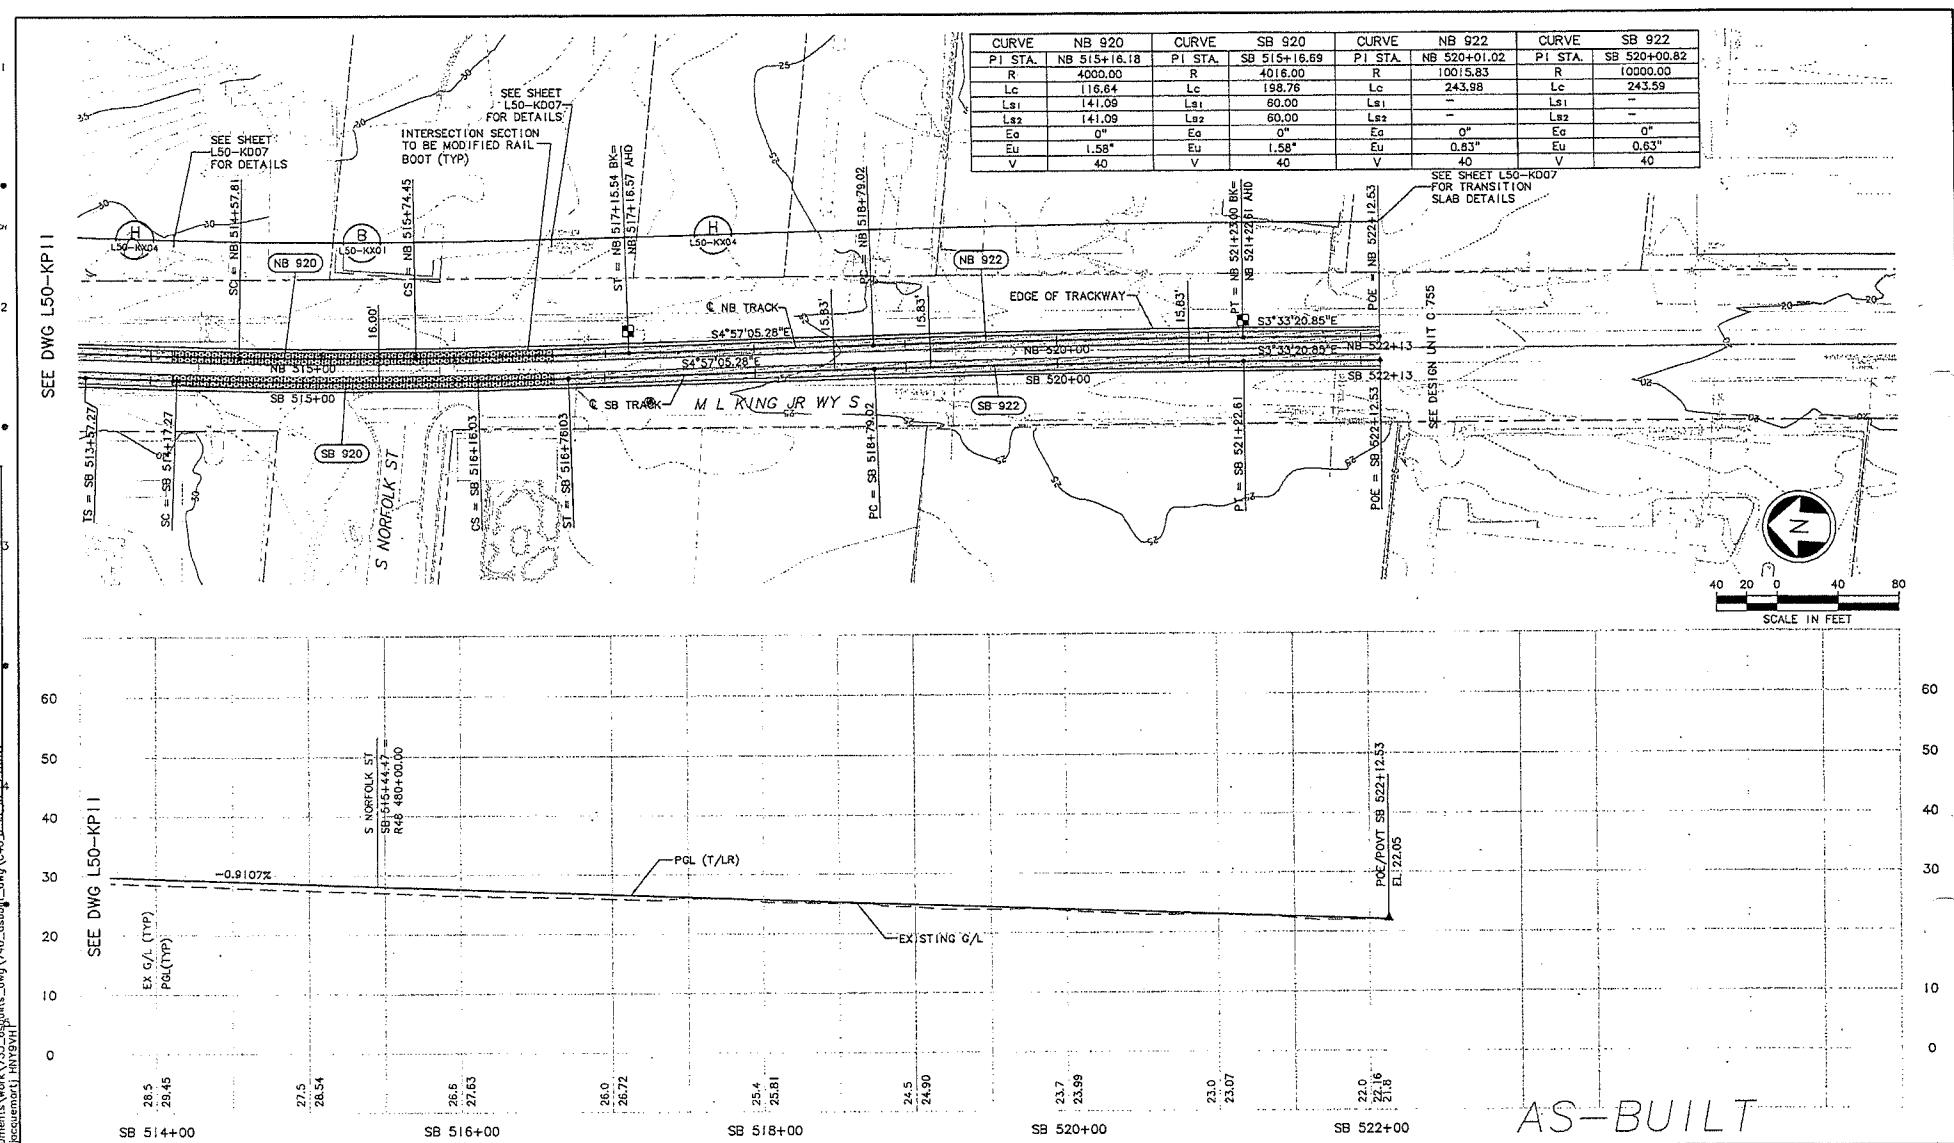

						 City of Seattle
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						Permit No. <input type="text" value="Y1434"/> Inspector's Book# <input type="text"/>
						Received: <input type="text"/>
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A	10/03/11	AS-BUILT				
O	12/12/03	CONFORM				
Mod.	Date	Des.	Chk.	App.	Responsible	SDOT:



	Scale: H: 1" = 40'; V: 1" = 1'
	Filename: C40_L150_KP12.DWG
T	Contract No.: C 73
Date:	Date: /12/03 05/30/06

AS-BUILT

**LINK LIGHT RAIL PROJECT
SOUTH CORRIDOR**

Drawing No.:	L50-KP12
YVault Plan No.	231-740
Sheet No.:	Rav. 92 A


SEE DWG L60-KP002

INCOR
SCALE:
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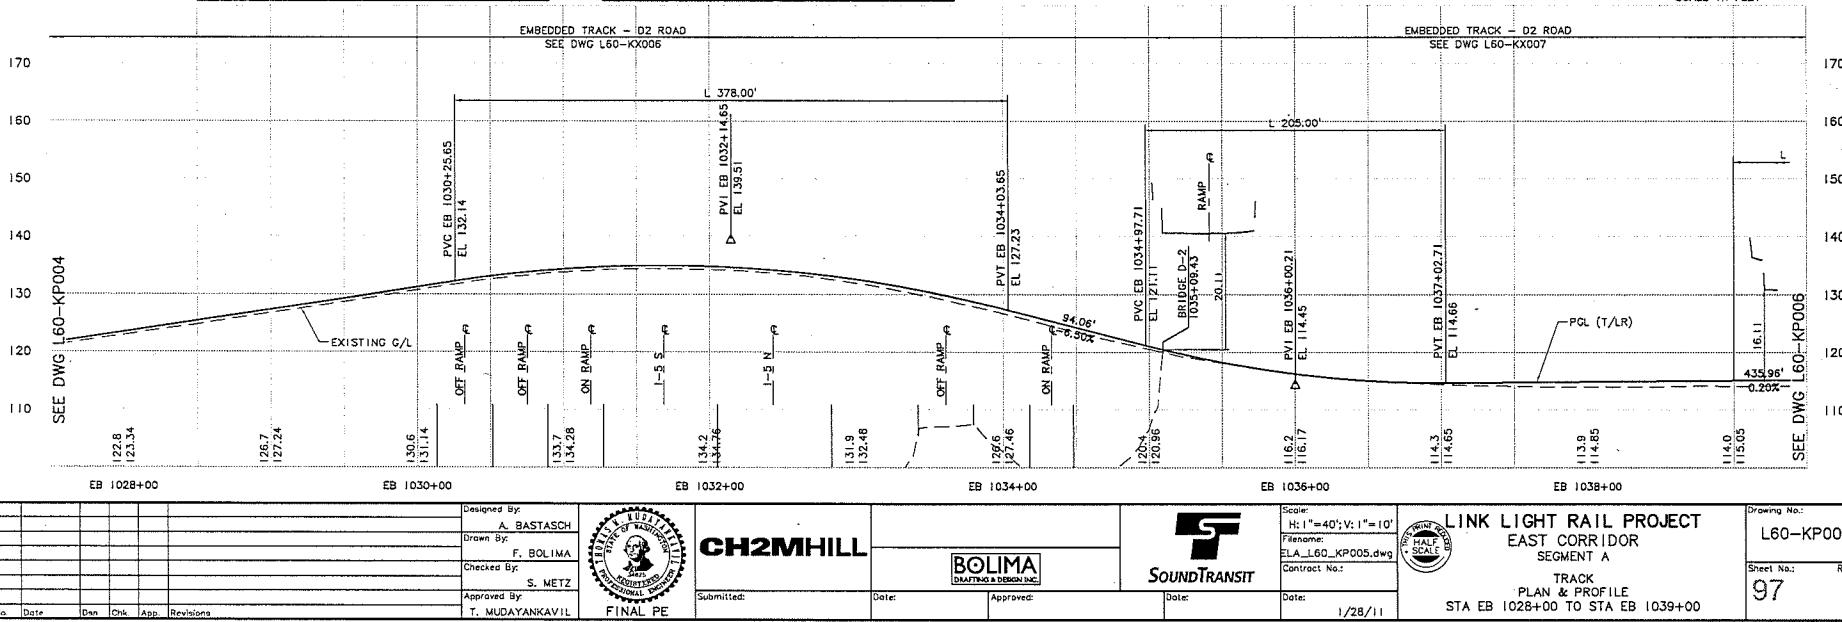
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Aircraft
Direction
A_160_K
CC-FVM
D-INTR
J-2234H
K-02020
L-9222R
M-9229F
N-7222R
O-7222S/
P-Accessories
Q-910A
R-A_160_K
S-A_160_Z
T-p_Fast

15/12/2008 : 00 : 33


SEE DWG L60-KP004

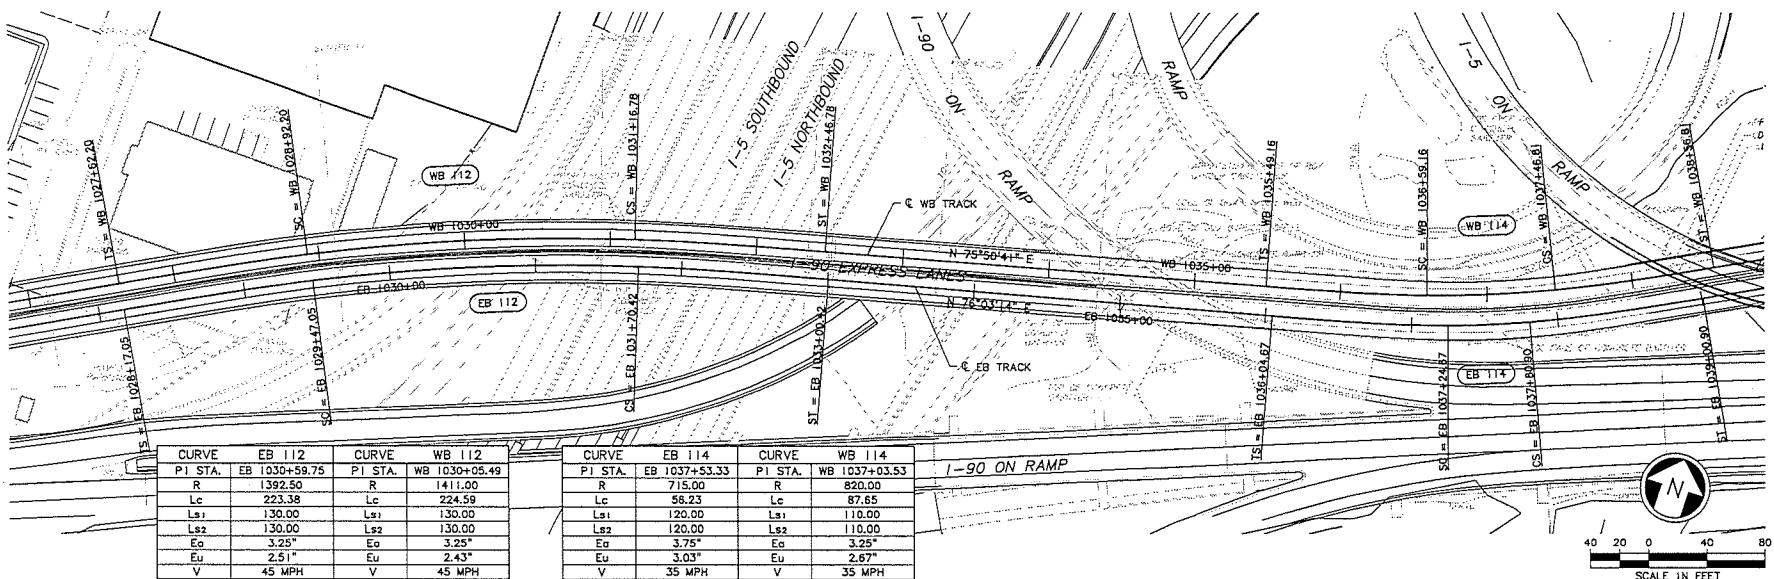



SEE DWG L60-KP006



SEE DWG L60-KP005

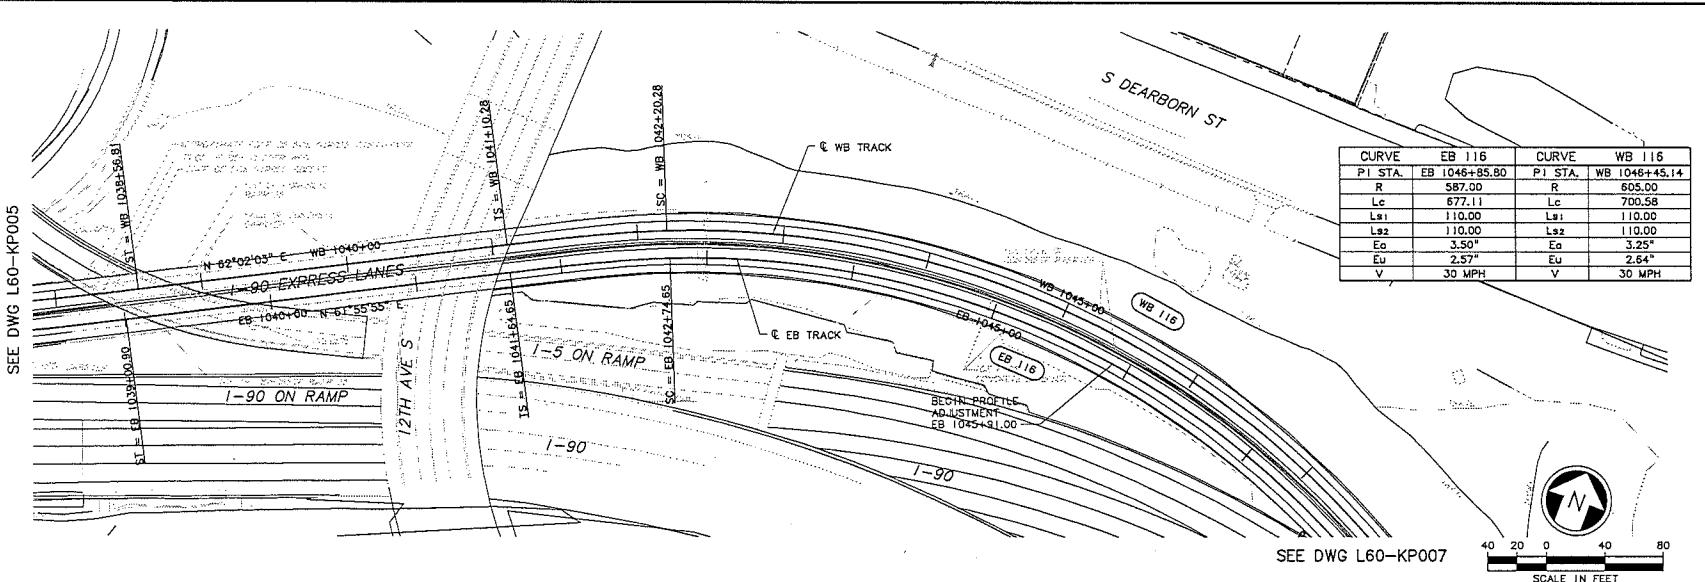

DRC_LNDS
LPSCALC
1=1
XREFS
-Allies
-Cobalt
ELA_160_KA
KA-160
KA-160_ZONE

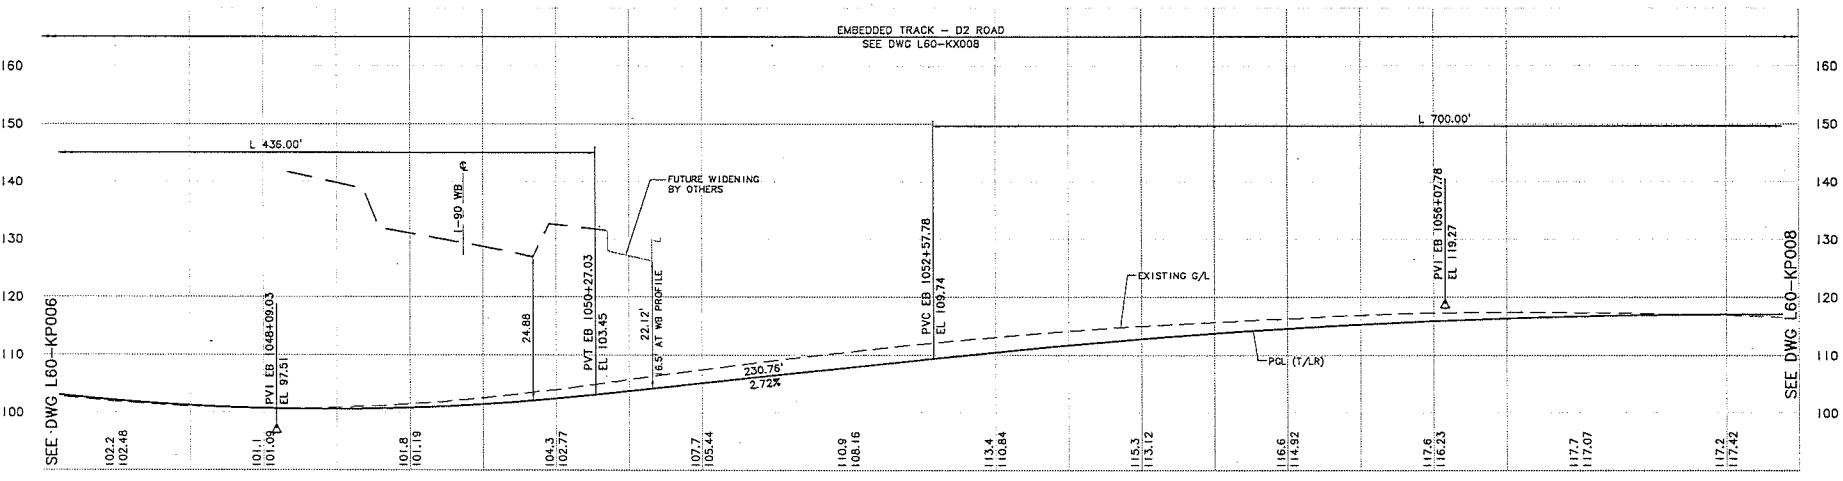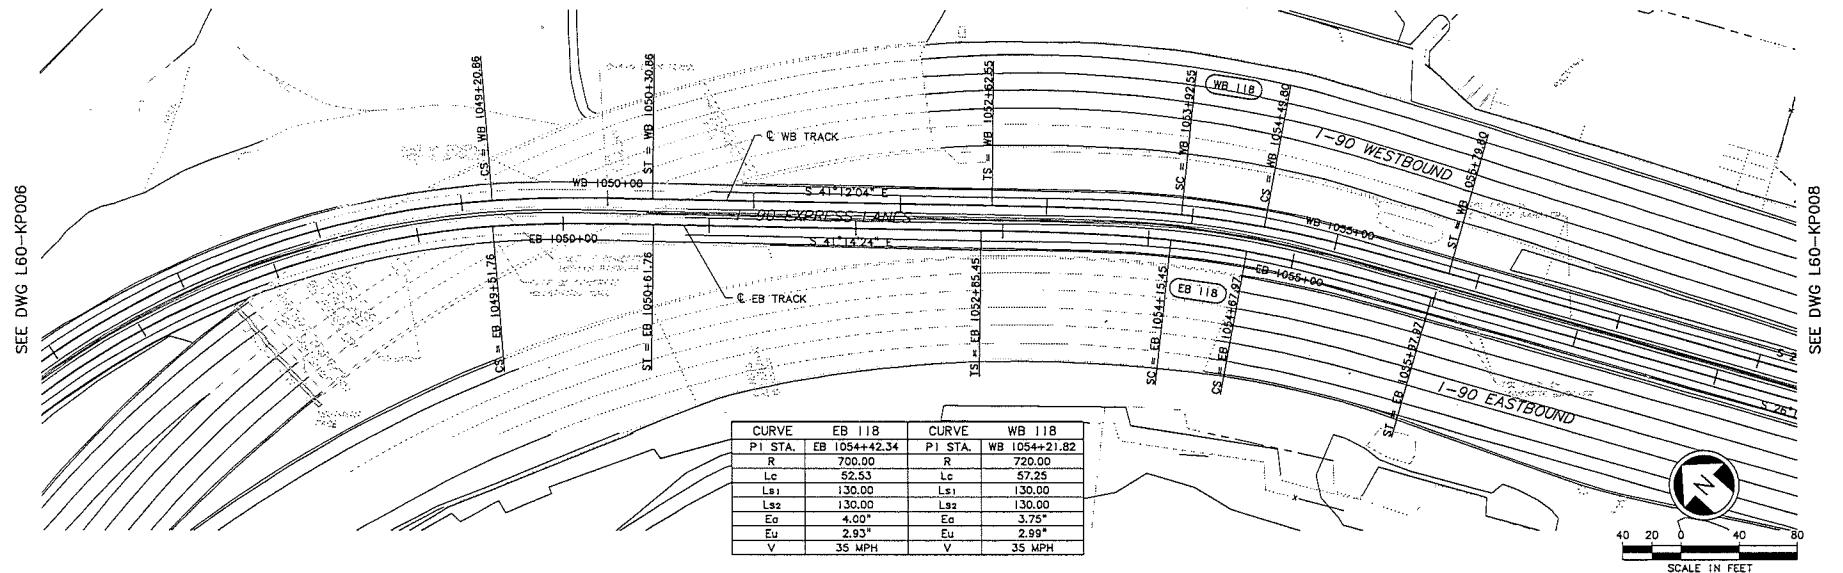

No	Date	Drawn	Chk.	App.	Revisions	Designed By: A. BASTASCH Drawn By: F. BOLIMA Checked By: S. NETZ Approved By: T. MUDAYANKAVIL	CH2MHILL  FINAL PE	BOLIMA DRAFTING & DESIGN INC.	SOUNDTRANSIT	Scale: H: 1" = 40'; V: 1" = 10' Planname: ELA_160_KP007.dwg Contract No.: 1/28/11	LINK LIGHT RAIL PROJECT EAST CORRIDOR SEGMENT A TRACK PLAN & PROFILE STA EB 1047+00 TO STA EB 1058+00	Drawing No.: L60-KP007 Sheet No.: 99 Rev:



REC_INFO
LISCALE
1-1
XRTA
-Attach
-Dissociate
EIA_160_
REC-TVM
SUD-INTR
Ig-2234h
Zg-q20002
z7519rx
z7519zf
z7522rx
z7522zf
-Unselected
Curve10s
EIA_160_

SEE DWG L60-KP007

I-90 WESTBOUND

I-90 EXPRESS LANES

I-90 EASTBOUND

**END PROFILE ADJUSTMENT
EB 1069+58.00**

**EMBEDDED TRACK D2 ROAD
SEE DWG 160-KX008**

**PVT EB 1054+57.78
EL 116.59
END PROFILE ADJUSTMENT**

PGL (T/LR)

EXISTING G/L

874.04'


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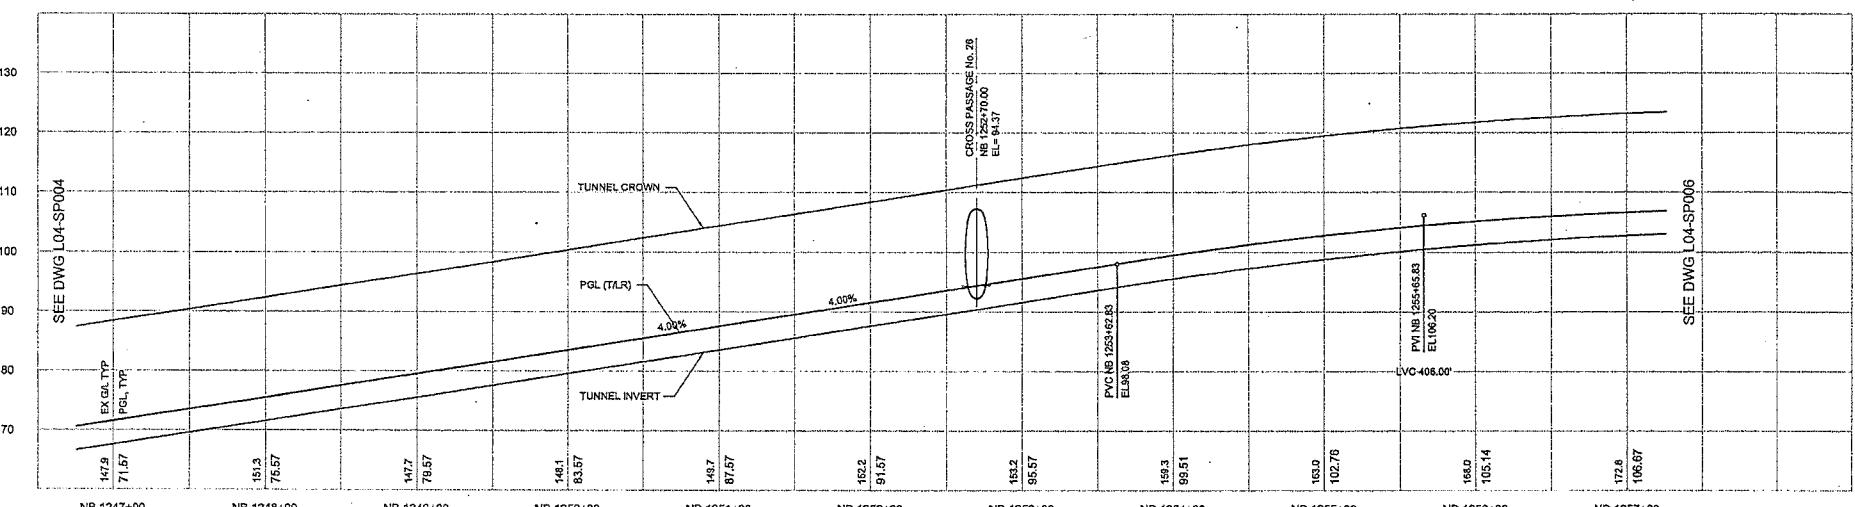
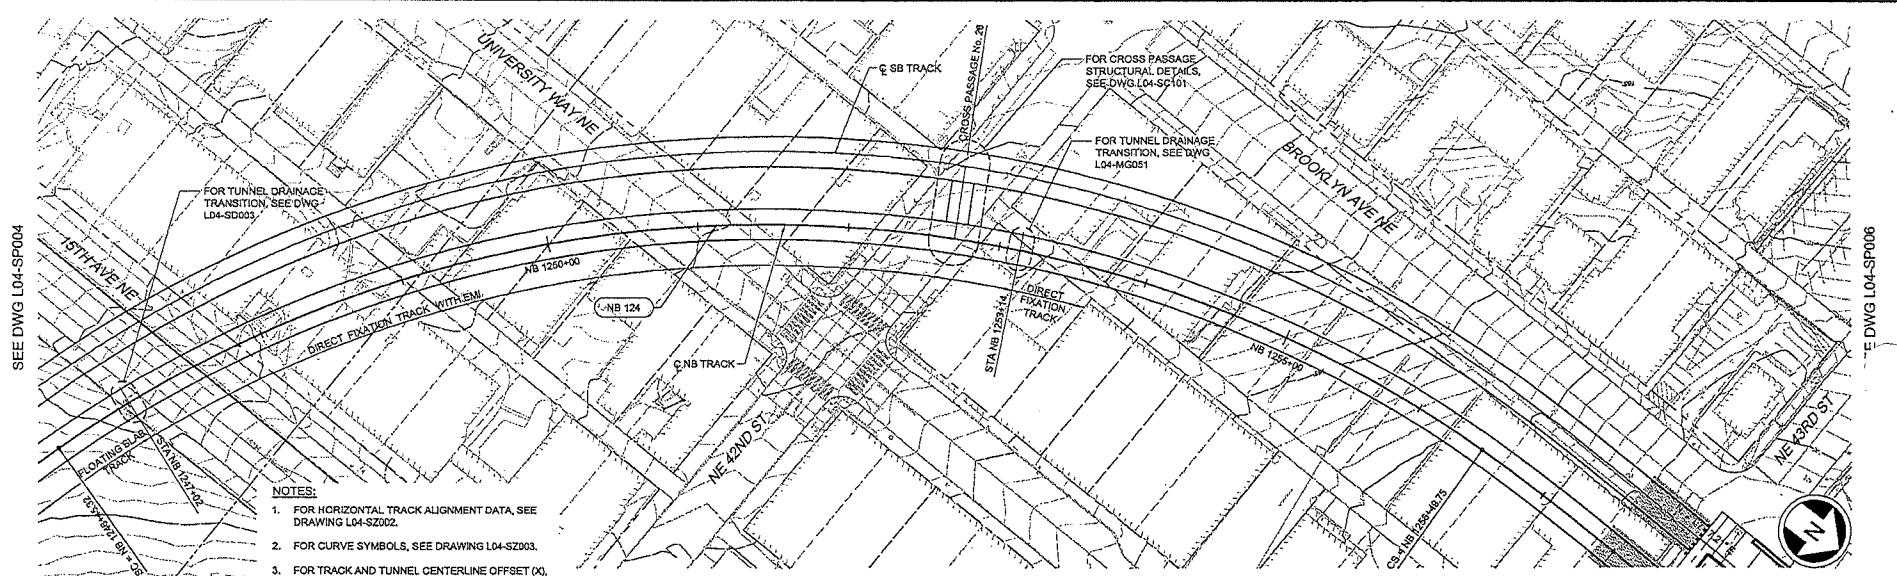
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R 1000.00 R 990.00
Lc 974.26 Lc 1004.17
Ls1 130.00 Ls1 130.00
Ls2 130.00 Ls2 130.00
Eo 3.50° Eo 3.50°
Eu 2.84° Eu 2.90°
V 40 MPH V 40 MPH**

SCALE IN FEET

SEE DWG 160-KP009







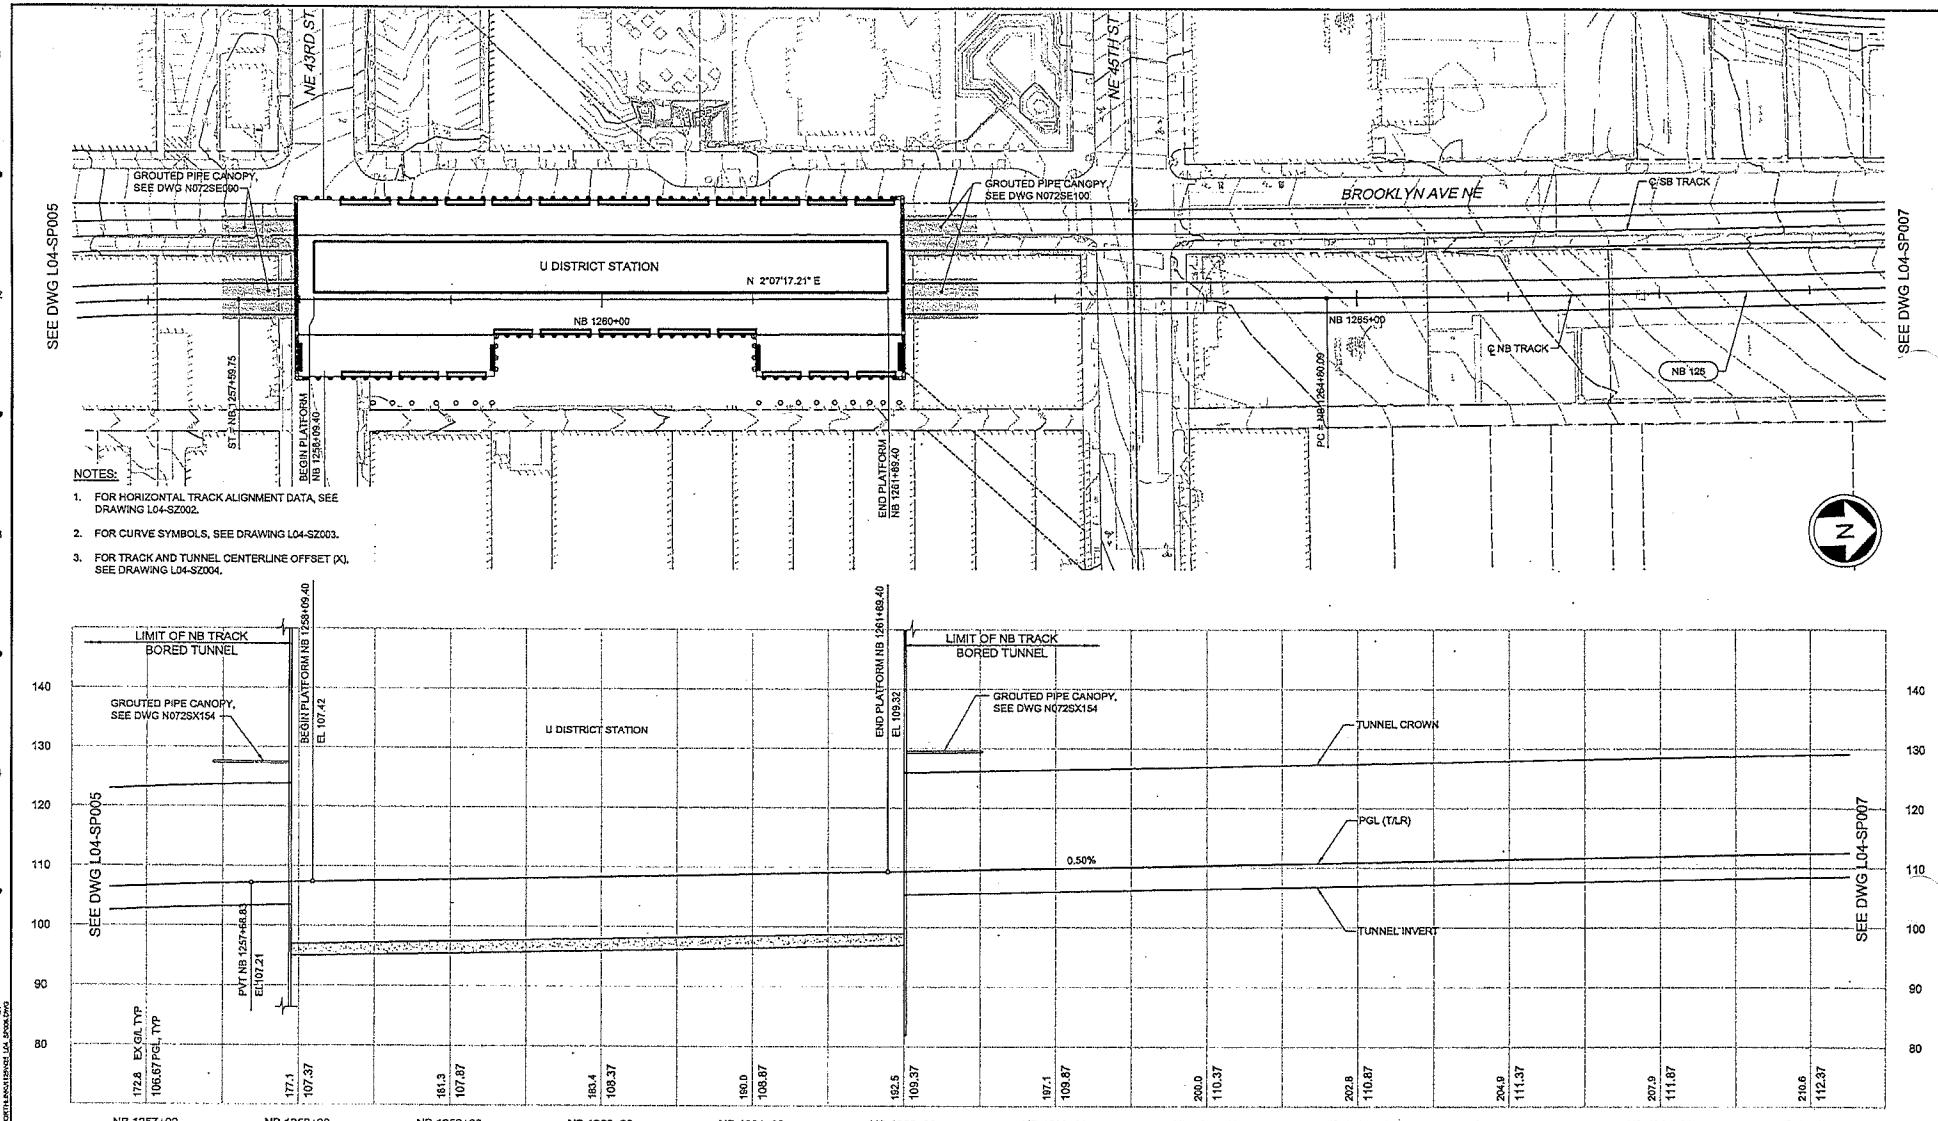



City of Seattle		Designed By: S. NIJOLOMA	Approved By: A. BYERS	JACOBS ASSOCIATES Engineers/Consultants	Scale: H:1"=40' V:1"=10'	LINK CONTRACT N125 TUNNELS, PORTAL AND STATION EXCAVATIONS		Drawing No. L04-SP005	
Work Order No.	Approved:	Drawn By:	Permit No.: Inspector's Book:	BOLIMA DRAFTING & DESIGN INC.	Plan No.: N25_L04_SP005.dwg	Contract No.: N125	Vault Part No.		
			Received:	Submitted By: I. LAMB	Date:	Date:			
			Revised As Built:	Approved By: A. MENCKE	Approved:	Approved:			
No.	Date	Drawn	Clerk	App.	Revisions				
SDOT:		Approved By: A. MENCKE		90% SUBMITTAL	I. LAMB	09/06/12	S. AL-TAMIMI	09/06/12	09/06/12



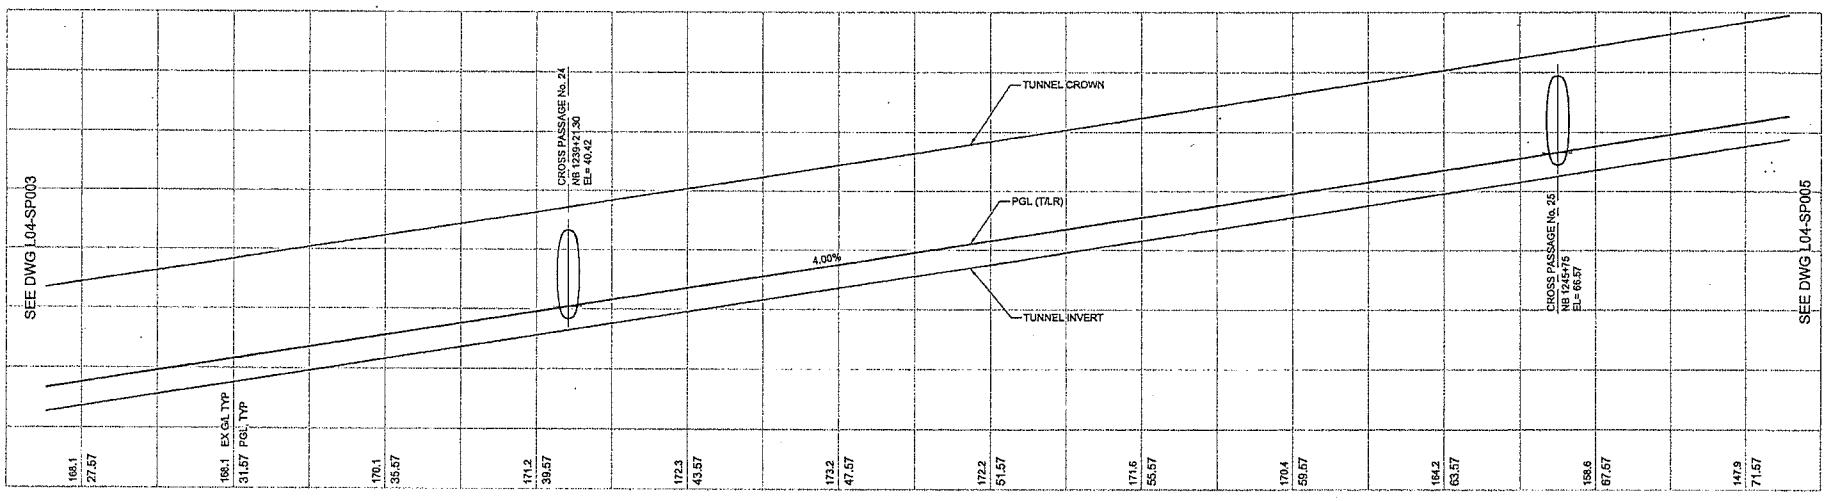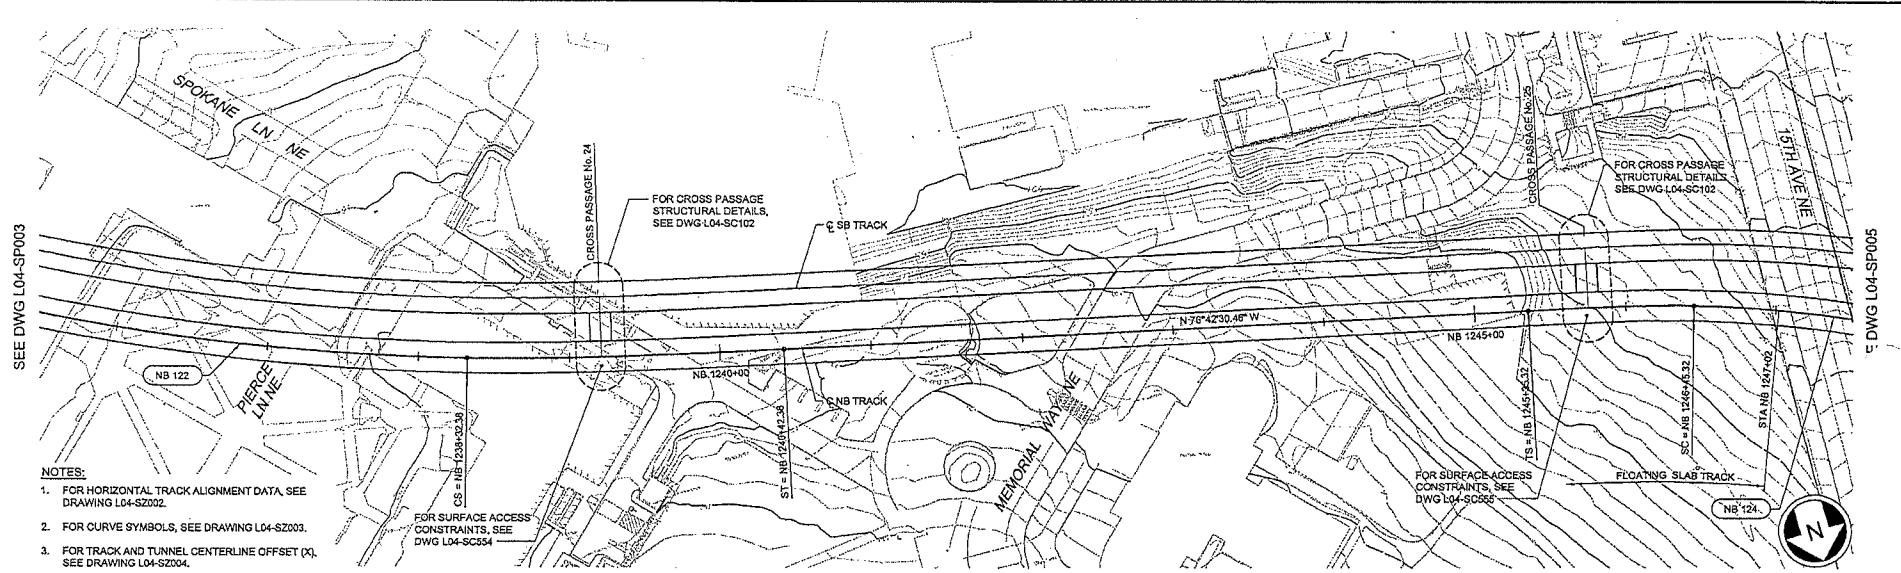


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Work Order No.	Approved:			Permit No.	Inspector's Book:	Received:	BOLIMA DRAFTING & DESIGN INC.	Floor Plan:	N125_L04_SP004.dwg	TUNNELS, PORTAL AND STATION EXCAVATIONS	L04-SP004
Permit No.	Inspected by:			Received:	Checked by:	Reviewed As Built:	Approved by:	Contract No.:	N125	TUNNEL STRUCTURE	Vault Plan No.
Date	Date	Drawn	Check	Received	Reviewed	Approved	Submitted	Date	Approved	Date	Date
No.	Date	Drawn	Check	Received	Reviewed	Approved	Submitted	Date	Approved	Date	Date
							I. LAMB	09/06/12	S. AL-TAHINI	09/06/12	09/06/12
										STA NB 1238+00 TO STA NB 1247+00	
											Sheet No. 20 Rev. No. 0




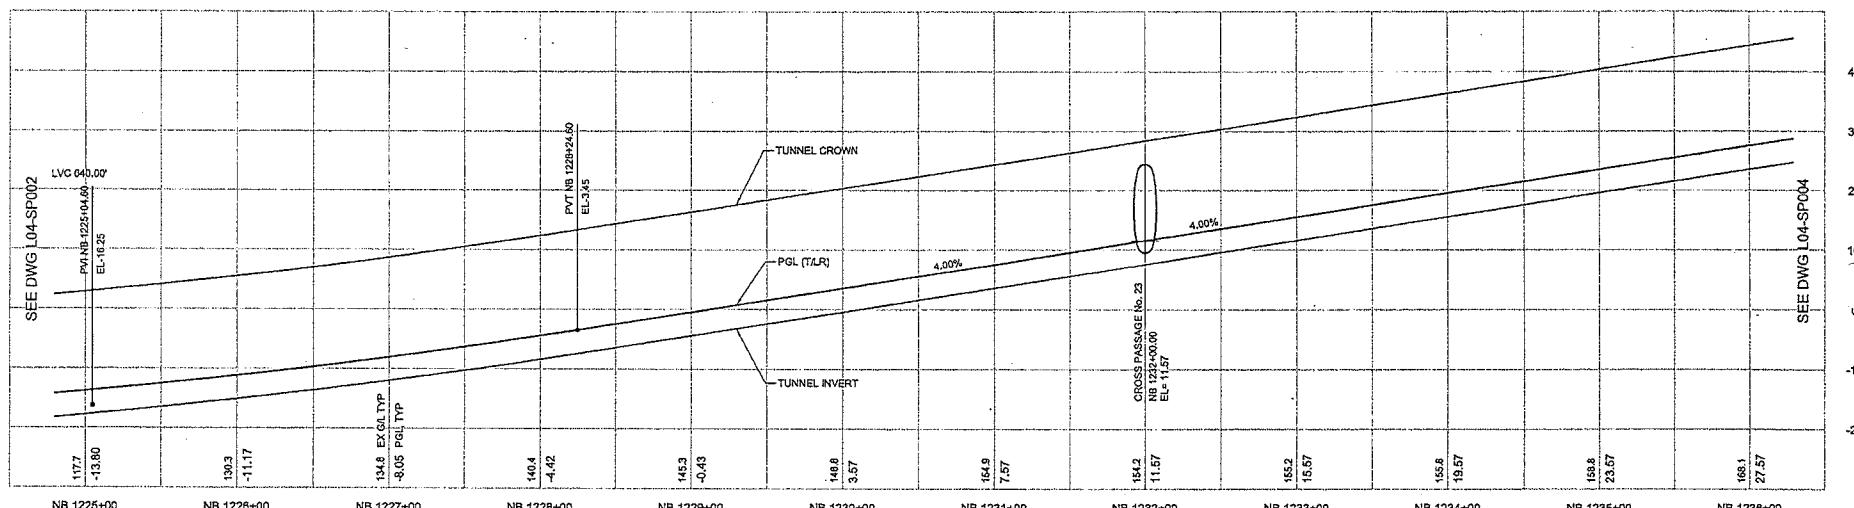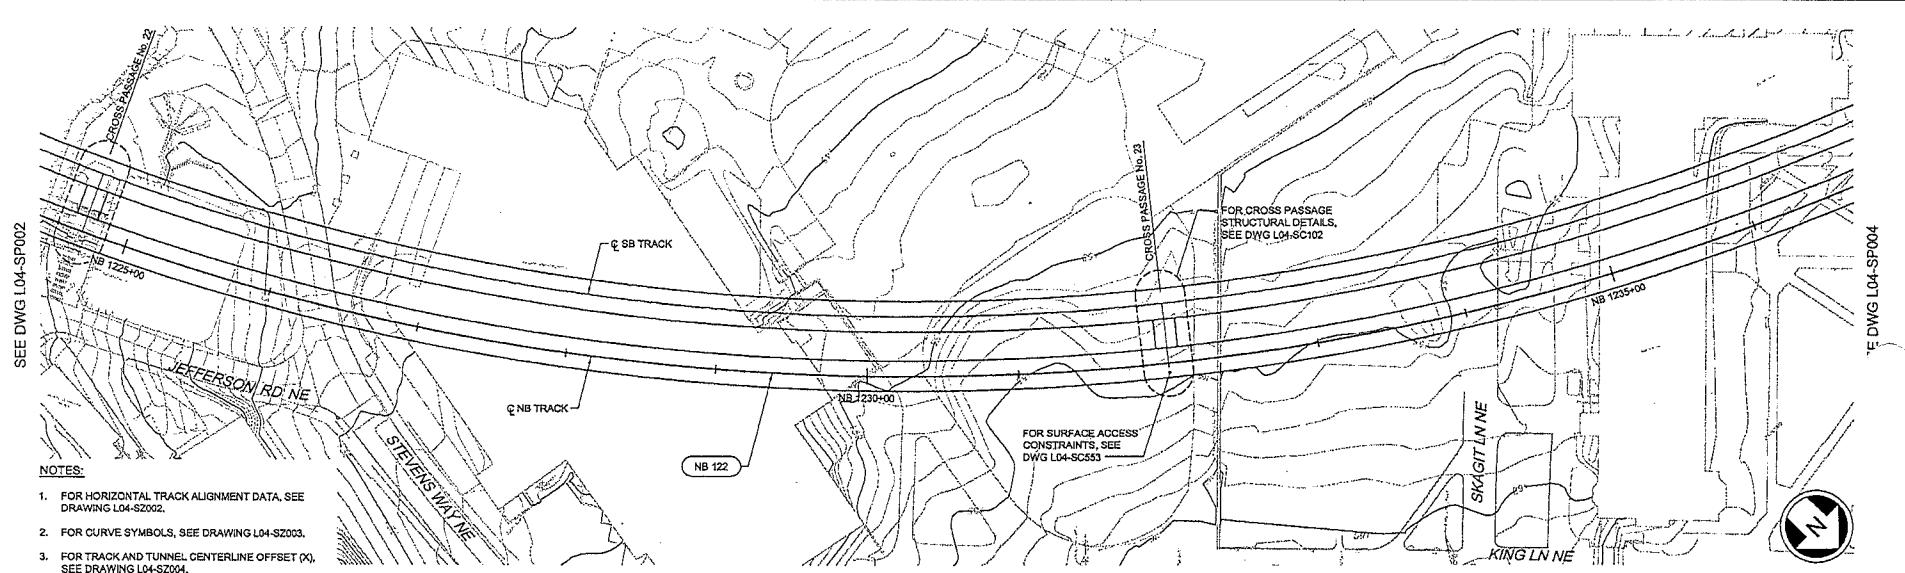

<p style="text-align: center;">City of Seattle</p> <p>Designed By: S. NIJOLOMA Approved: A. BYERS Drawn By: A. BYERS Permit No.: Inspector's Book: A. BYERS Received: Checked By: A. MENCKE Revised As Built: Approved By: A. MENCKE</p> <p>SDOT: Approved By: A. MENCKE</p>												<p>JACOBS ASSOCIATES Engineers/Consultants BOLIMA DRAFTING & DESIGN INC.</p> <p>90% SUBMITTAL</p> <p>Submitted: I. LAMB Date: 09/06/12 Approved: S. AL-TANIMI Date: 09/06/12</p>	<p>Scale: H:1"=40' V:1"=10' FILE NAME: N125_L04_SP003.dwg Contract No: N125</p> <p>SOUND TRANSIT</p>	<p>LINK CONTRACT N125 TUNNELS, PORTAL AND STATION EXCAVATIONS</p> <p>TUNNEL STRUCTURE NB PLAN AND PROFILE STA NB 1225+00 TO STA NB 1236+00</p>	<p>Drawing No: L04-SP003 Vault Plan No. Sheet No: 21 Rev No: 0</p>
REV 12/11 12/14 15 IN THIS DRAWING IS THE PROPERTY OF THE CITY OF SEATTLE. IT IS TO BE RETURNED UPON COMPLETION OF THE PROJECT OR APPROVAL BY THE CITY OF SEATTLE. IT IS NOT TO BE COPIED OR USED FOR ANY OTHER PURPOSE.															



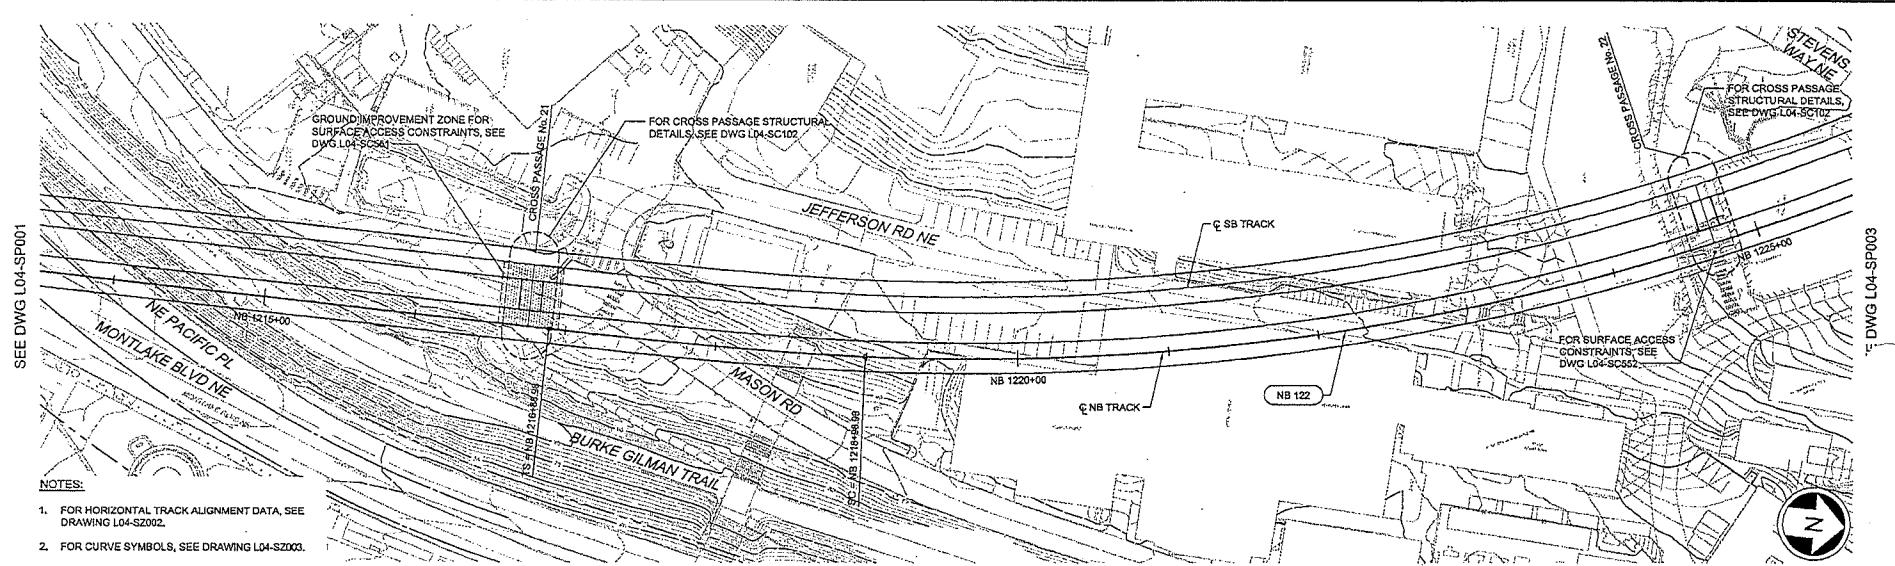

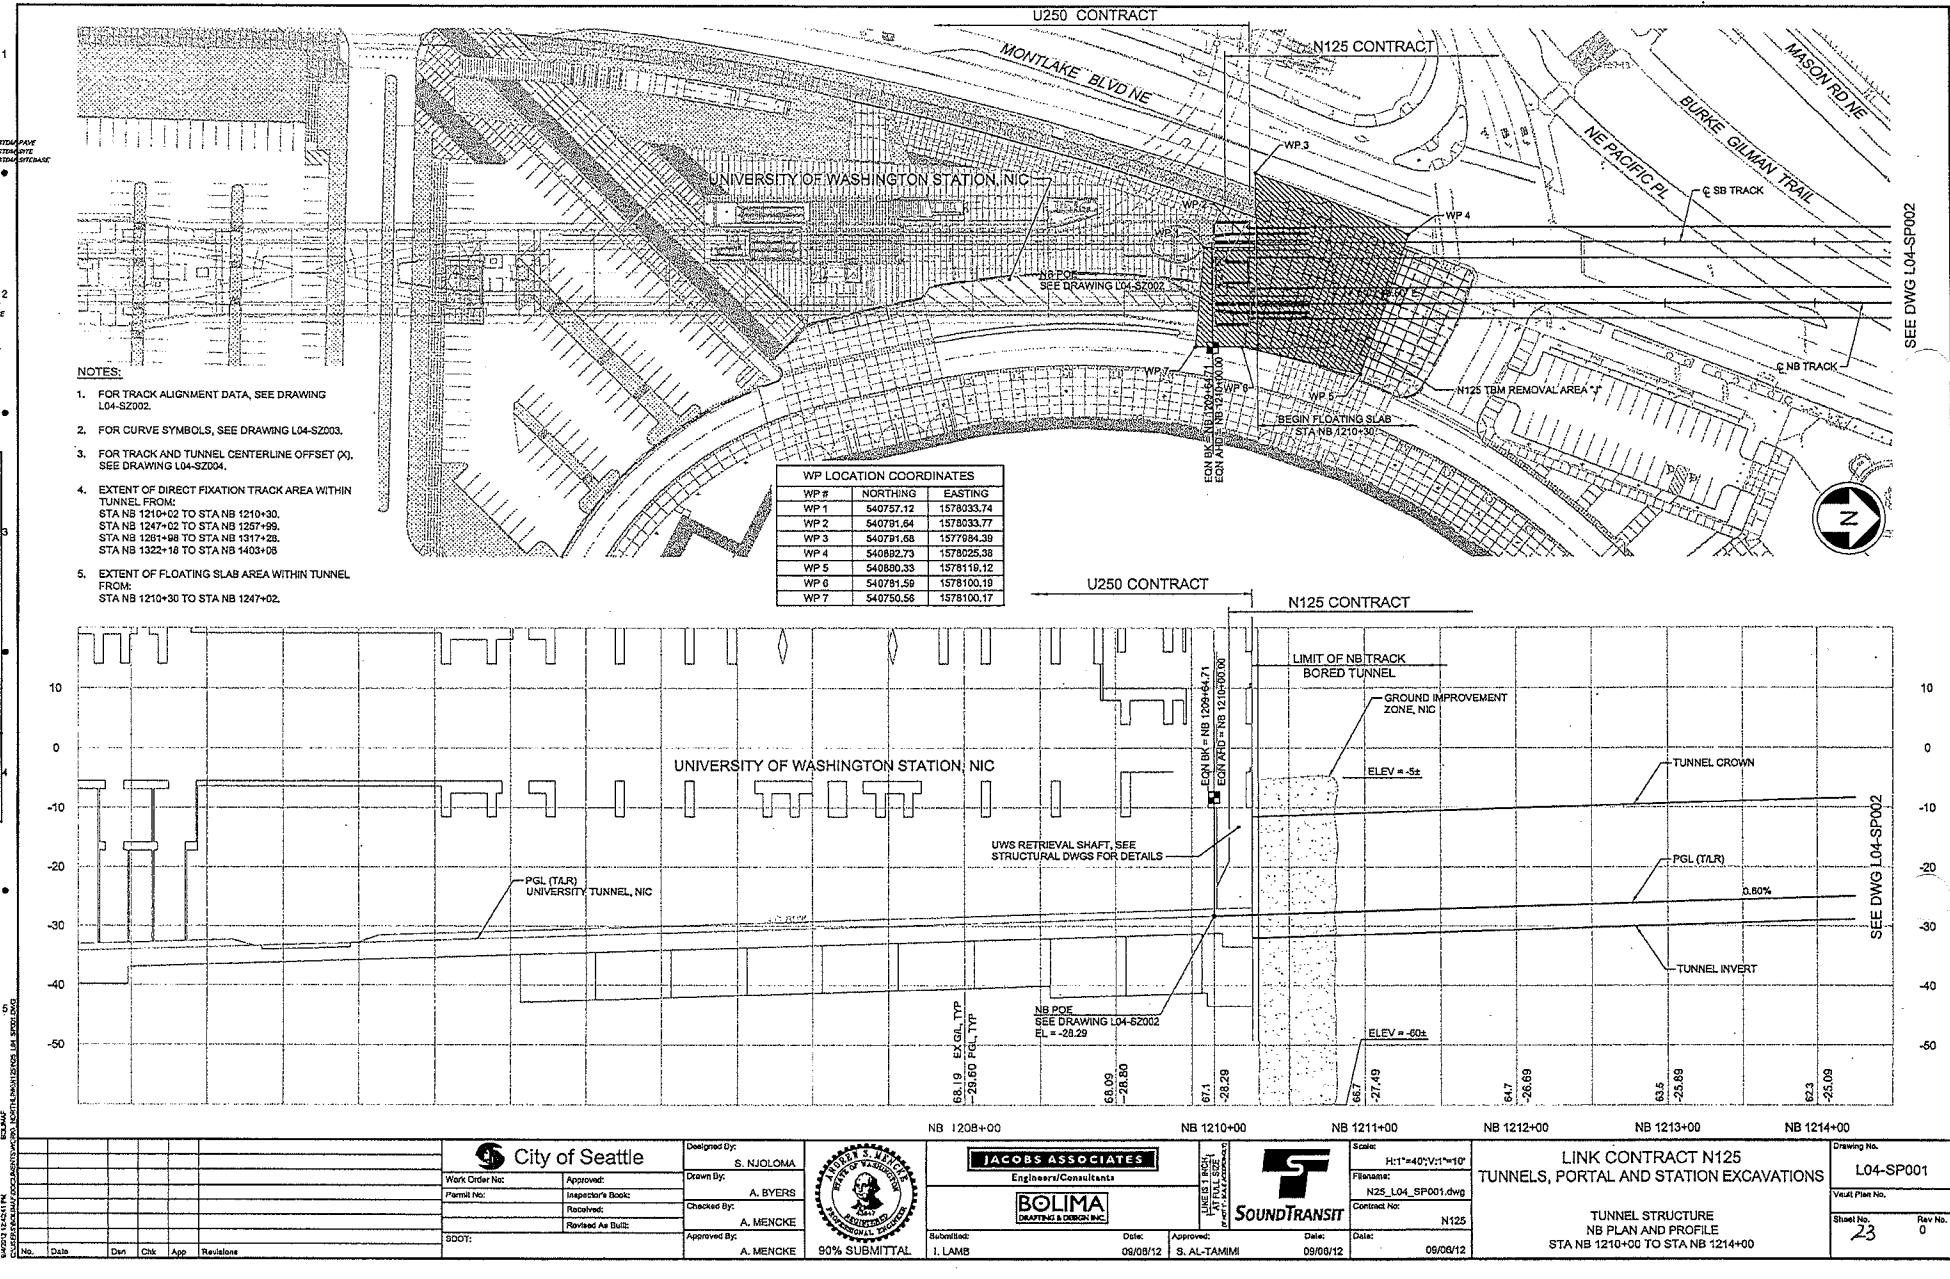

SEE DWG L10-ST114

NOTES:

1. FOR HORIZONTAL TRACK ALIGNMENT TABLES, SEE DRAWING L10-SZ001.
2. FOR CURVE SYMBOLS AND SUPERELEVATION TRANSITION DEVELOPMENT, SEE DRAWING L10-SZ002.
3. FOR TRACK AND TUNNEL CENTERLINE OFFSET, (X) SEE DRAWING L10-SZ003

SCALE IN FEET
40 20 0 40

SEE DWG L10-ST 14

LIMIT OF NB TRACK
BORED TUNNEL

EXISTING G/L

TUNNEL CROWN

PVC NB 119+77.90
EL -40.62

LVC 240.00'

PVT NB 1202+730 NB 1202+06.40
EL -34.56

UNIVERSITY OF WASHINGTON STATION
SEE UW STRUCTURAL SHEETS

NB POB
SEE DRAWING L10-SZ001
EL -26.29

GROUNDS TREATMENT ZONE
FROM EL -5 TO EL -55

+4.50%
-42.90 EX G/L (TP)
-44.13 PGL (TP)
-55.58
-39.66
-34.43
-33.68
-32.80
-31.20
-30.40
-28.90
-26.30

+0.80%

SEE DWG L10-ST112

NOTES

1. FOR HORIZONTAL TRACK ALIGNMENT TABLES, SEE DRAWING L10-SZ001.
 2. FOR CURVE SYMBOLS AND SUPERELEVATION TRANSITION DEVELOPMENT, SEE DRAWING L10-SZ002.
 3. FOR TRACK AND TUNNEL CENTERLINE OFFSET (X), SEE DRAWING L10-SZ003.

CURVE		NB 118
PI STA.	NB	1180+10.
R		7240.00
Lc		3715.01
Ls1		80.00
Ls2		80.00
Eg		0.50"
Eu		1.15"
V		55 MPH

PUMP STATION
SEE R29-CP020, UCG201 UC420
FOR CIVIL SURFACE WORK DETAIL

MONTLAKE BLVD.

DWG L10-ST114

A horizontal scale bar with tick marks at 0, 20, 40, and 80. Below it is the label "SCALE IN FEET".

SEE DWG L10-ST112

NB 1178400

Digitized by Google

NB. 1180+00

卷之三

72
8

PUMP STATION AND RISER
CROSS TASSIE NO. 18
EL = 185.82
EL = 185.64

LVC 2900.00

M/N B 185-2765
-14.88

100

TATION RISE

REFERENCES

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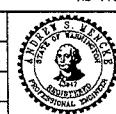
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NB 1185

N

411

B 1188+00





SOUNDTRANS

LINK CONTRACT U220
TBM TUNNELS (UWS TO CHS)

TUNNEL STRUCTURE PLAN & PROFILE


owing No.:
L10-ST113
ult Plan No.
est No.: Rev.:
26 0

NOTES
Reserved
KA-1601
KC-12M2
U10-10
U20-110-SP
G20-110-SV
Unlocked/OKA
J21-OKN
J21-OKX
J21-OKP
J21-OKL
20-222-ASCA
2g-20000
Unlocked
St. Jerome, NL

1/SCALE
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2

SEE DWG L10-ST110

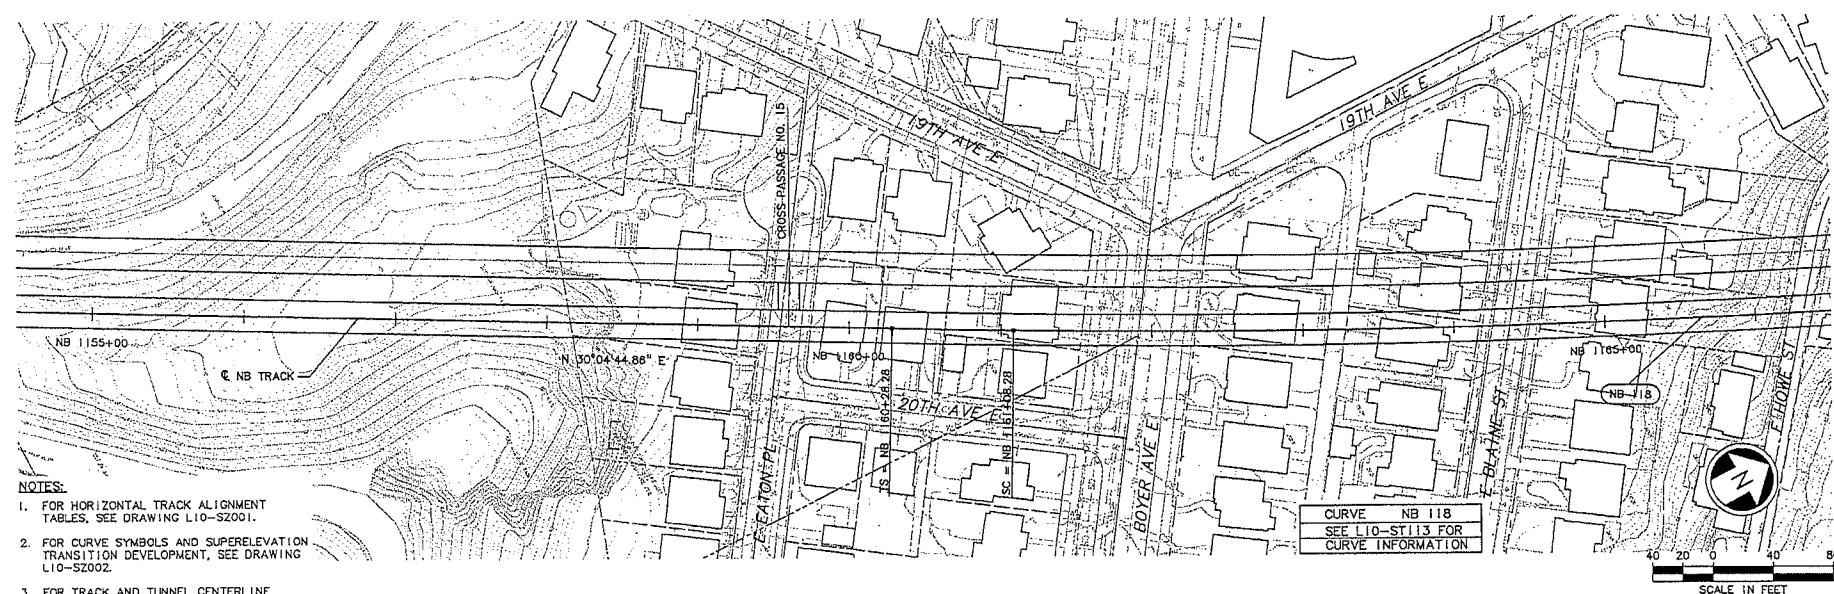


DWG L10-ST112

VALU SERIAL NO. DATE WORK MADE BY DESIGNER

2

- NOTES:
1. FOR HORIZONTAL TRACK ALIGNMENT TABLES, SEE DRAWING L10-SZ001.
2. FOR CURVE SYMBOLS AND SUPERELEVATION TRANSITION DEVELOPMENT, SEE DRAWING L10-SZ002.
3. FOR TRACK AND TUNNEL CENTERLINE OFFSET (X), SEE DRAWING L10-SZ003.

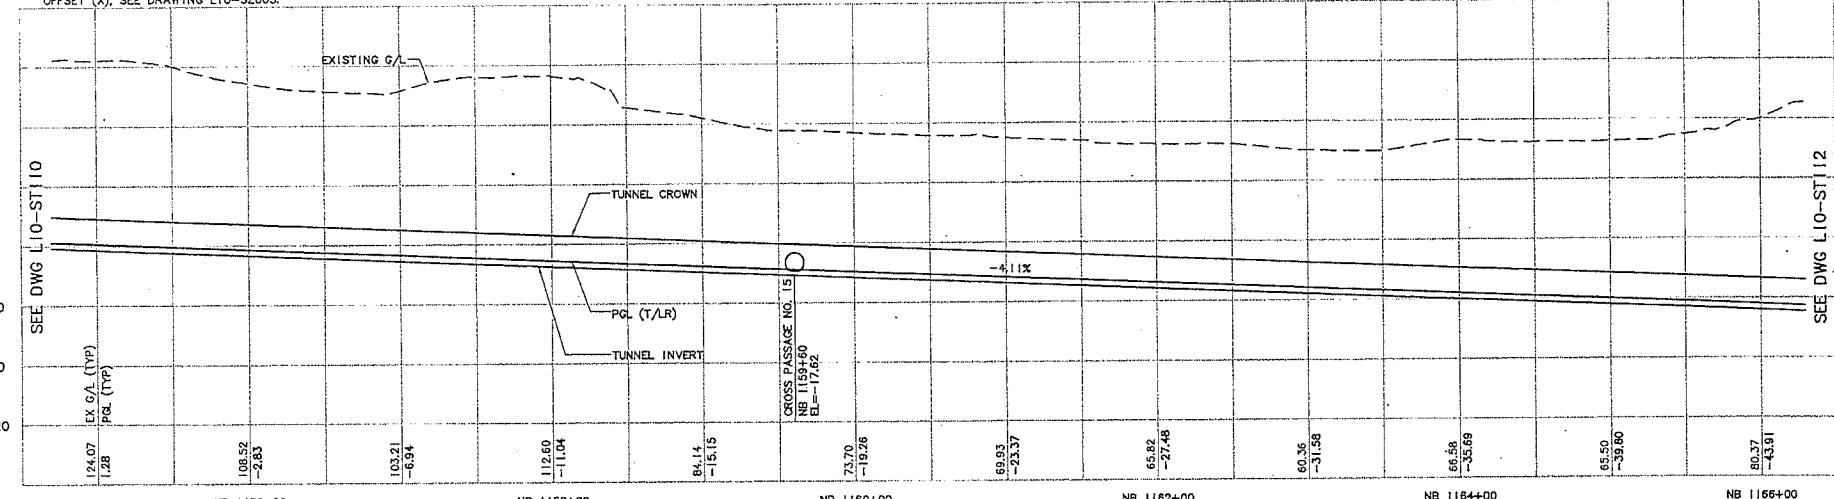

120

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-20

-40

-60

-80

-100

-120

SEE DWG L10-ST112

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04/21/08 09:03

0	05/05/09	Date	Den.	Chk.	App.	Revisions	SDOT:	City of Seattle	Designed By: A. MENCKE	Drawn By: H. JORISSEN	Approved By: A. MENCKE	Submitted By: D. ADAMS	Approved Date: 05/05/09	Approved By: J. SLEAVIN	Approved Date: 05/05/09	Approved Date: 12/29/08	Scale: H: 1'=40'; V: 1'=40' Folio no.: U20-110-ST111.DWG Contract No.: U220	LINK CONTRACT U220 TBM TUNNELS (UWS TO CHS)	Drawing No.: L10-ST111	Vault Plan No.	Sheet No.: 28	Rev.: 0
No.																						



REF ID'S
Received
KA-101
REC-102
U220
U220_L10_SP
U220_L10_SP
U220_L10_SP
X239m
X239n
X239o
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X239q
X239r
X239s
X239t
X239u
X239v
X239w
X239x
X239y
X239z
ZG-224SEA
Zg-22002
Unreviewed
SL_Normex_N

LTS SCALE
1:1000

SEE DWG L10-ST108

CROSS PASSAGE NO. 11

VOLUNTEER PARK RD

GRANDVIEW PL E

16TH AVE E

DWG L10-ST110

N 30°04'44.86"E



NB 1140+00

NOTES:

1. FOR HORIZONTAL TRACK ALIGNMENT TABLES, SEE DRAWING L10-SZ001.
2. FOR CURVE SYMBOLS AND SUPERELEVATION TRANSITION DEVELOPMENT, SEE DRAWING L10-SZ002.
3. FOR TRACK AND TUNNEL CENTERLINE OFFSET (X), SEE DRAWING L10-SZ003.

EXISTING G/L

SCALE IN FEET

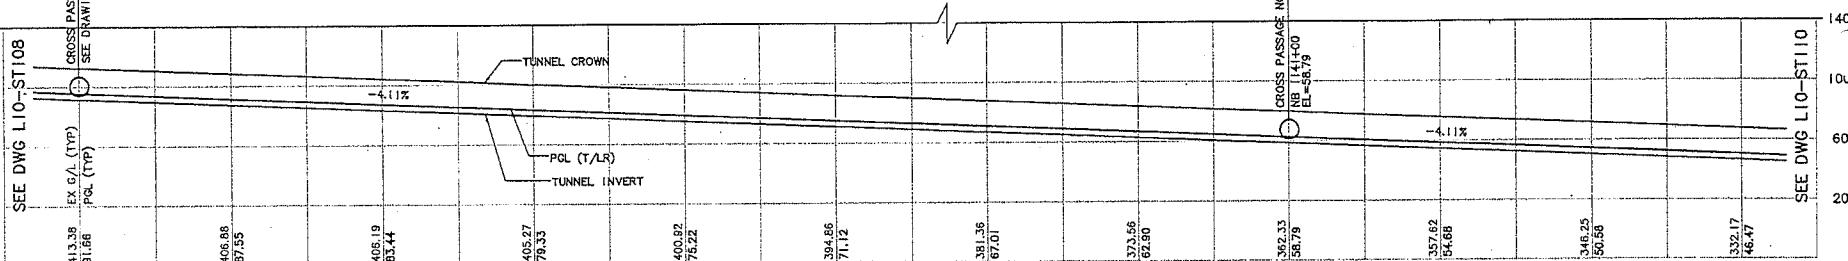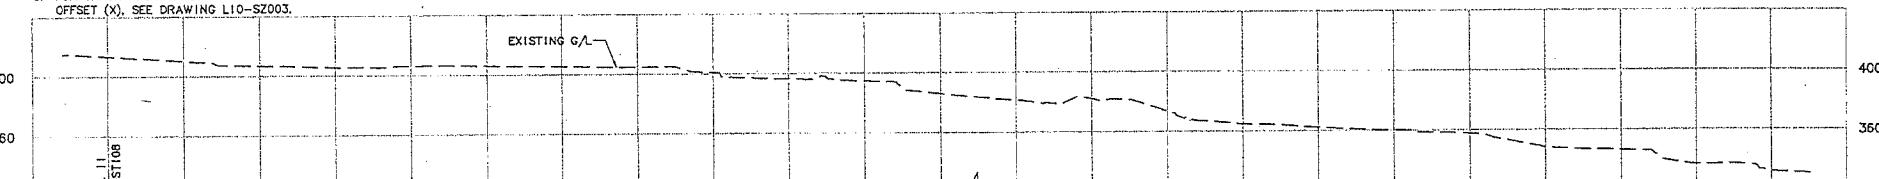

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0 05/05/09	ISSUED FOR CONSTRUCTION	SDOT:	Designed By: A. MENCKE	Drawn By: H. JORISSEN	Approved By: S. SWARTZ	Submitted: D. ADAMS	Date: 05/05/09	Approved: J. SLEAVIN	Date: 12/29/08	Scale: H: 1'=40'; V: 1'=40'	LINK CONTRACT U220 TBM TUNNELS (UWS TO CHS)	Drawing No.: L10-ST109
No. Date	Des. Chk. App. Revisions		Approved By: A. MENCKE	NDT International Partners	SOUNDTRANSIT	Filomatex U20_L10_ST109.DWG	Contract No.: U220	TUNNEL STRUCTURE PLAN & PROFILE	STA NB 1133+00 TO STA NB 1144+00	Vault Plan No.	Sheet No.: 50	Rev.: 0



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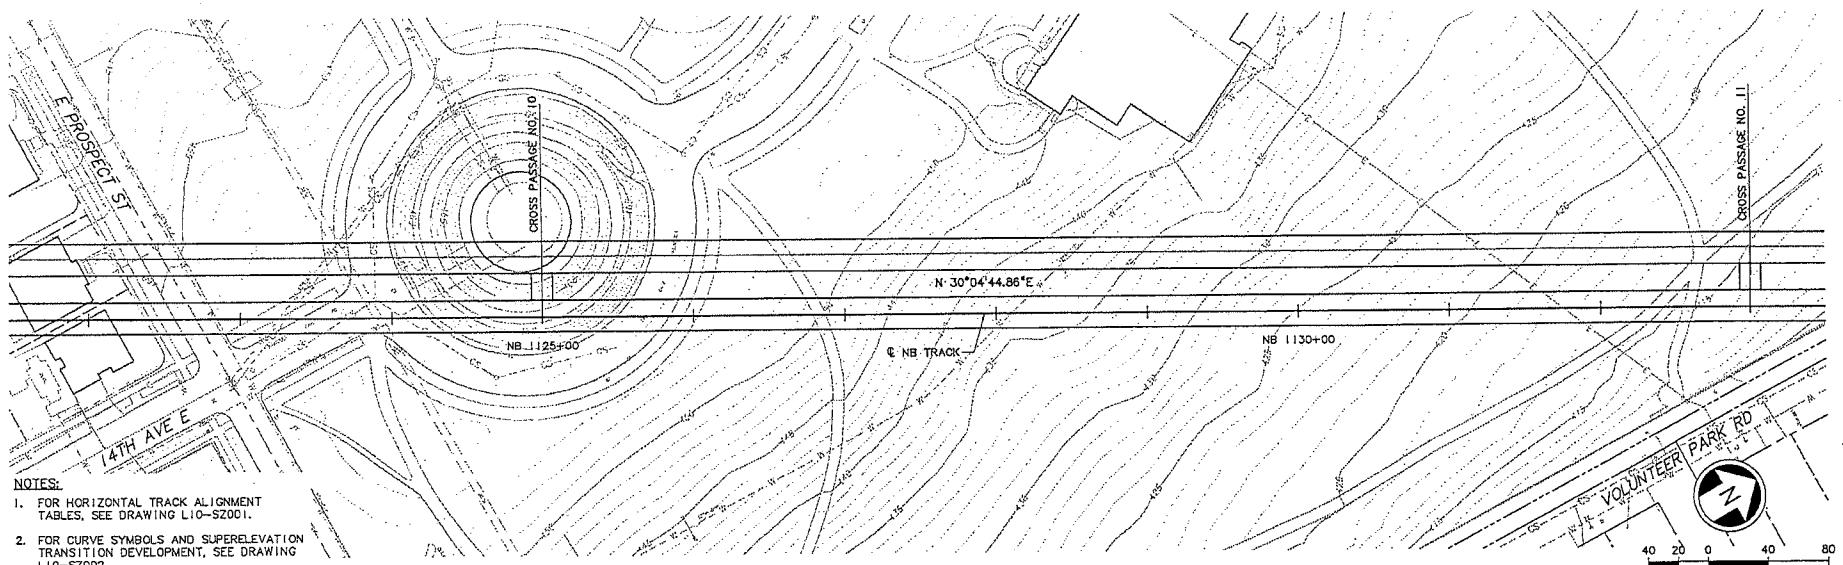
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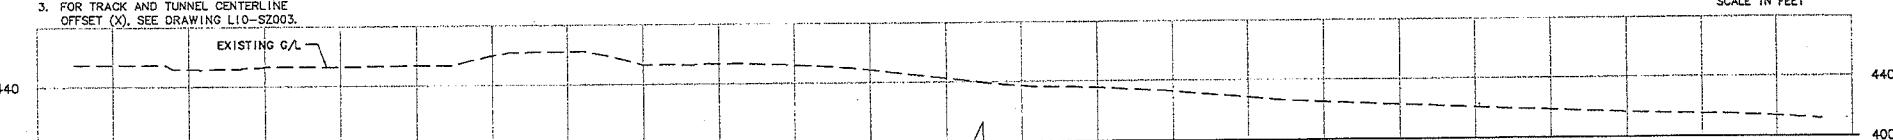
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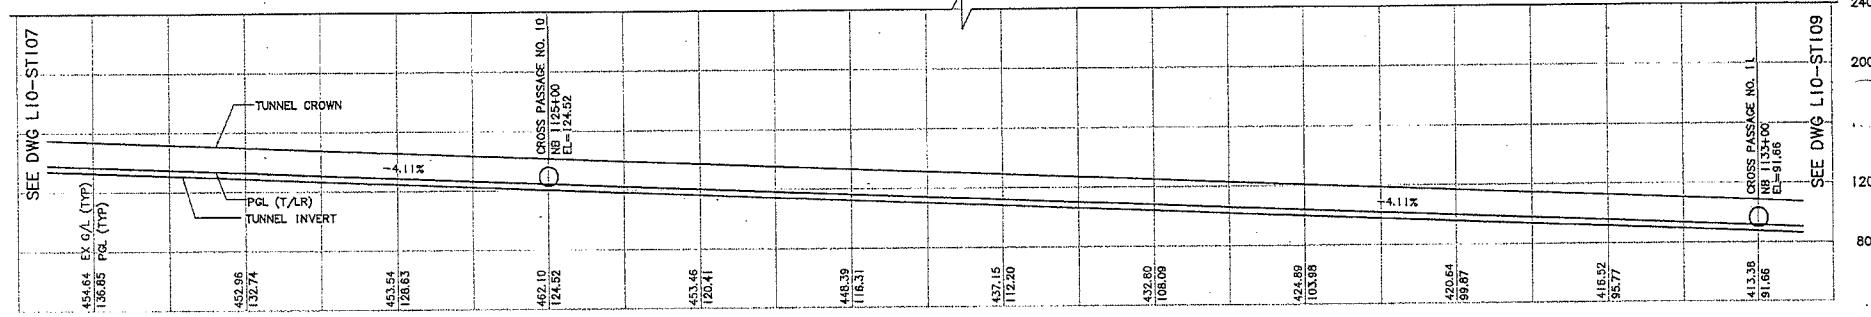
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1. FOR HORIZONTAL TRACK ALIGNMENT TABLES, SEE DRAWING L10-SZ001.
2. FOR CURVE SYMBOLS AND SUPERELEVATION TRANSITION DEVELOPMENT, SEE DRAWING L10-SZ002.
3. FOR TRACK AND TUNNEL CENTERLINE OFFSET (X), SEE DRAWING L10-SZ003.

EXISTING G/L




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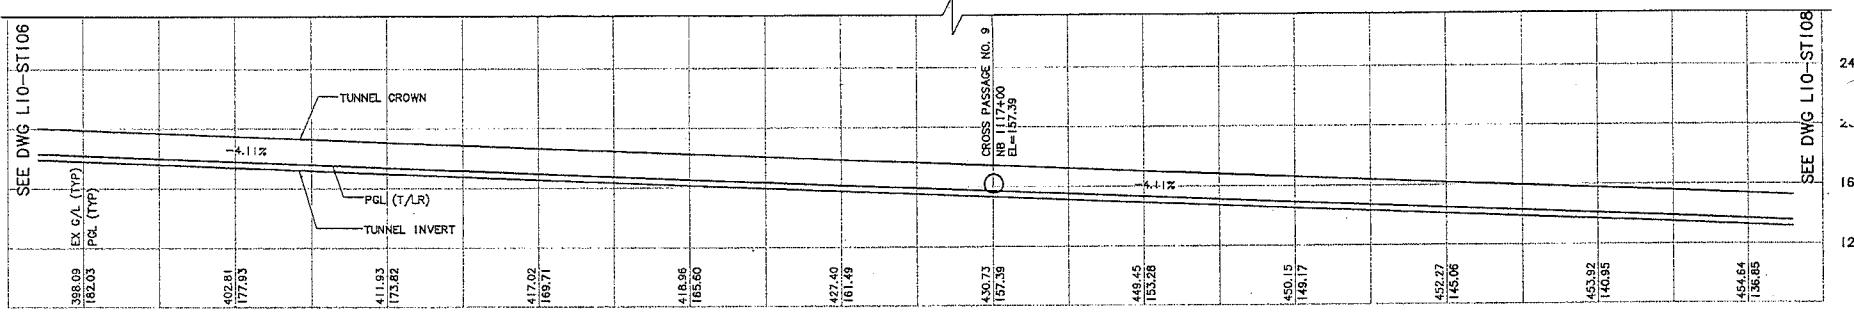
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Work Order No.	Approved:	Drawn By:	Inspector's Book:	Checked By:	Approved:	Date:	TUNNEL STRUCTURE PLAN & PROFILE	Vault Plan No.
Permit No.						05/05/09	STA NB 1122+00 TO STA NB 1133+00	Sheet No.: 31



SEE DWG L10-ST106



DWG L10-ST108

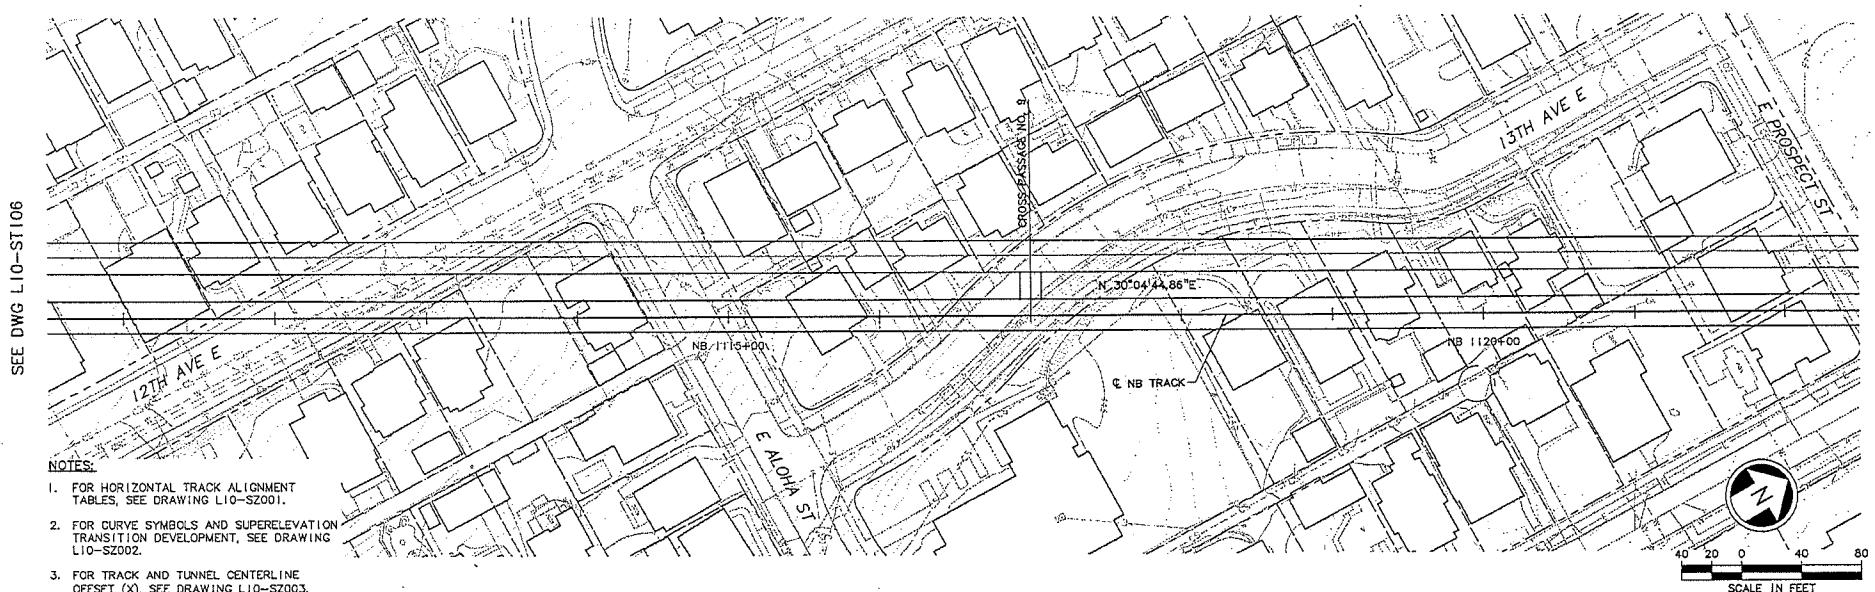

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No.	Date	Den.	Chk.	App.	Revisions
0	05/05/09				ISSUED FOR CONSTRUCTION

City of Seattle

Work Order No. Approved:
 Permit No. Inspector's Book:
 Received: Checked By:
 Revised As Built: Approved By:
 S. SWARTZ
 A. MENCKE




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 Date: 05/05/09
 Date: 12/29/08


LINK CONTRACT U220
 TBM TUNNELS (UWS TO CHS)
 TUNNEL STRUCTURE
 PLAN & PROFILE
 STA NB 1111+00 TO STA NB 1122+00

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 Sheet No.: 32 Rev: 0




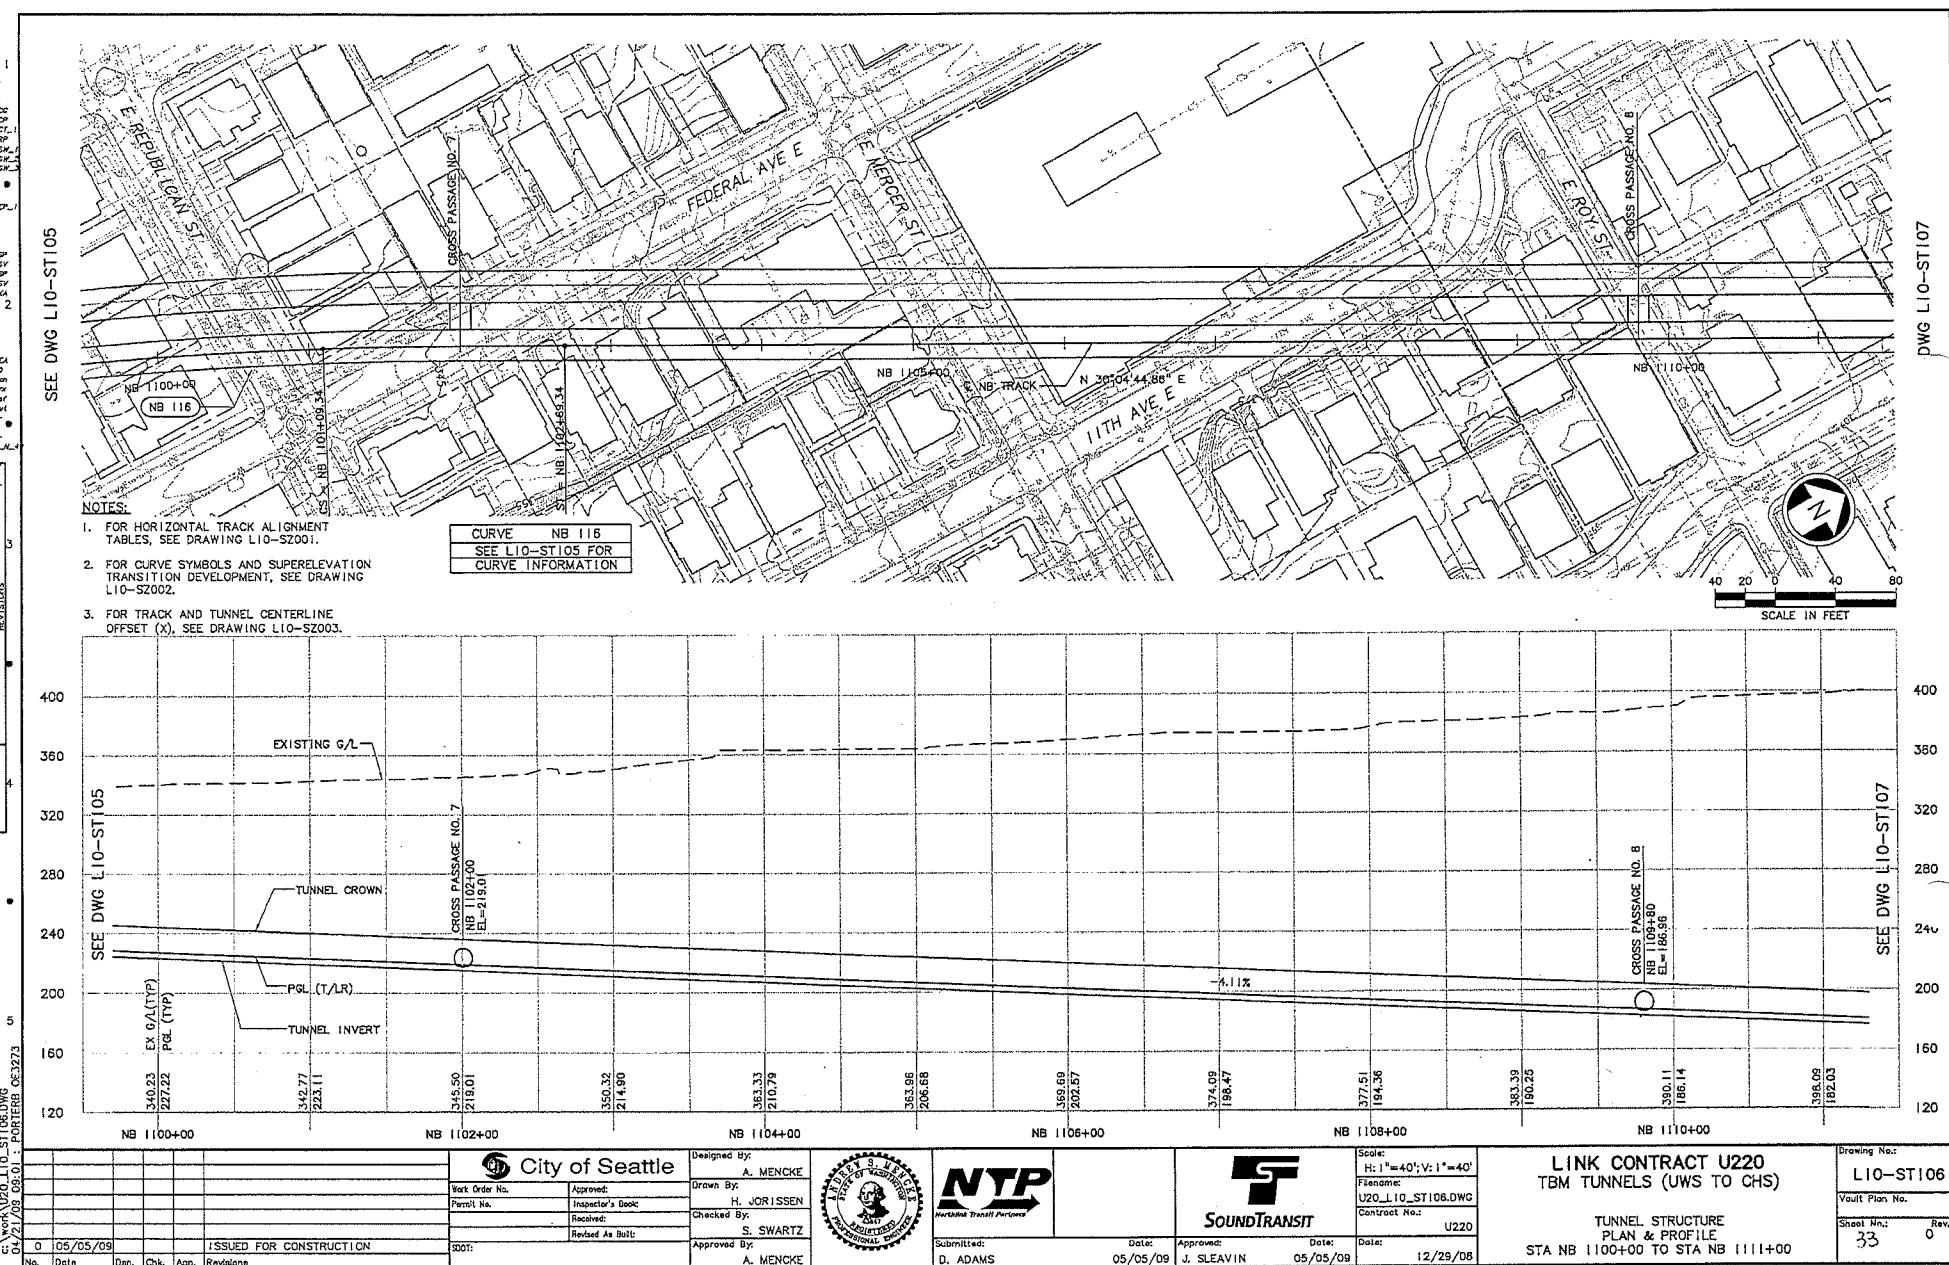

SEE DWG L10-ST104

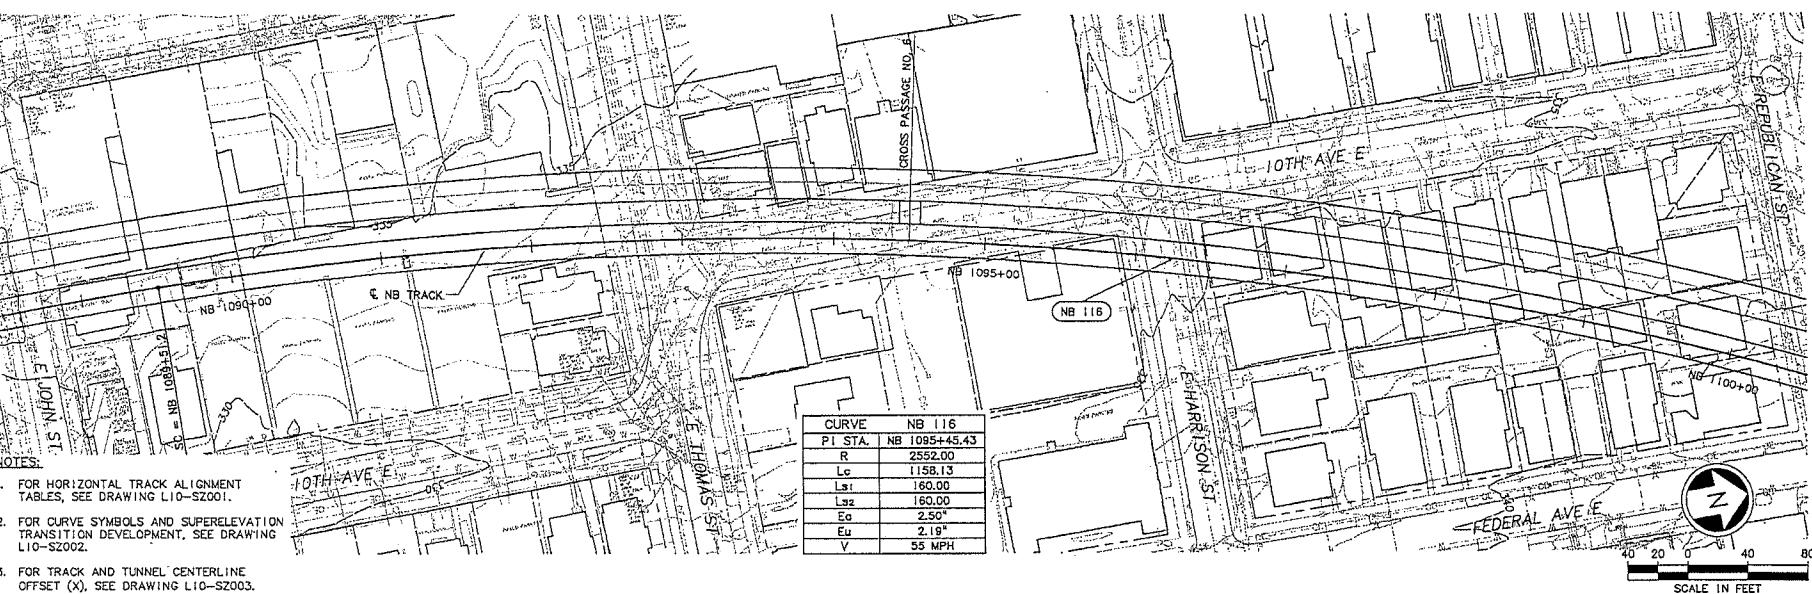

DWG L10-ST106

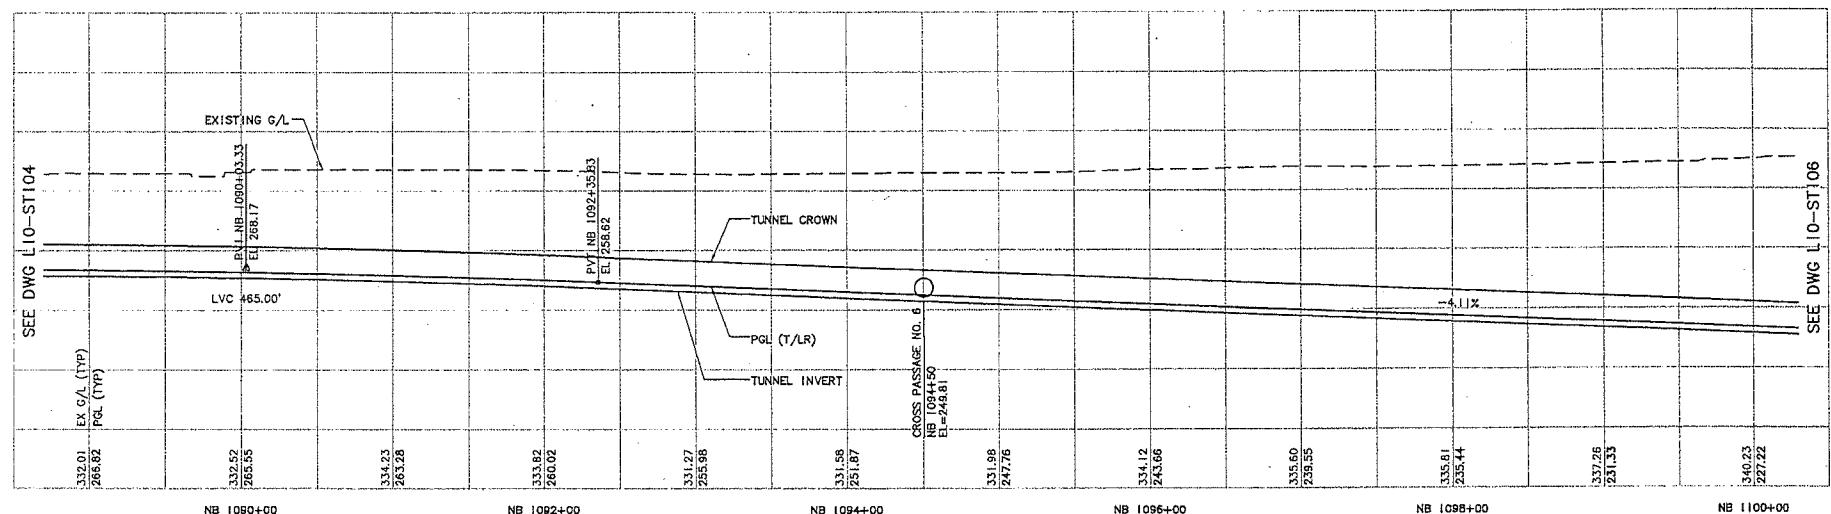


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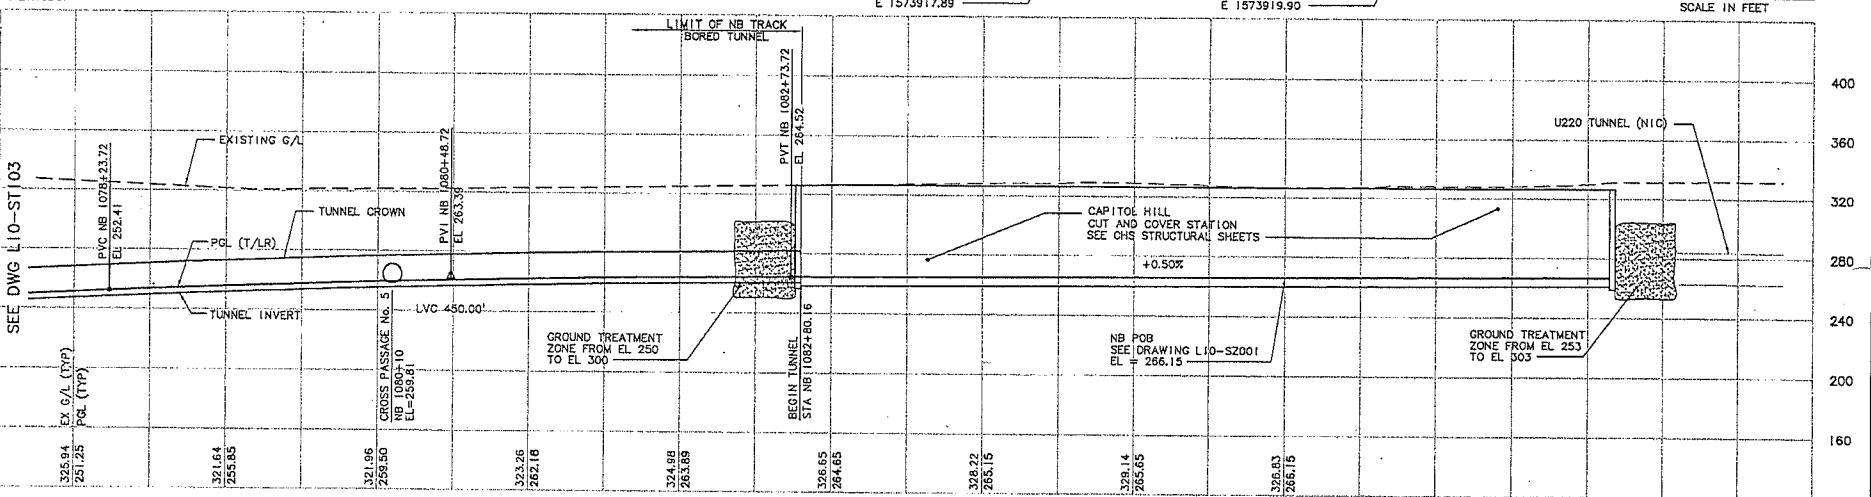
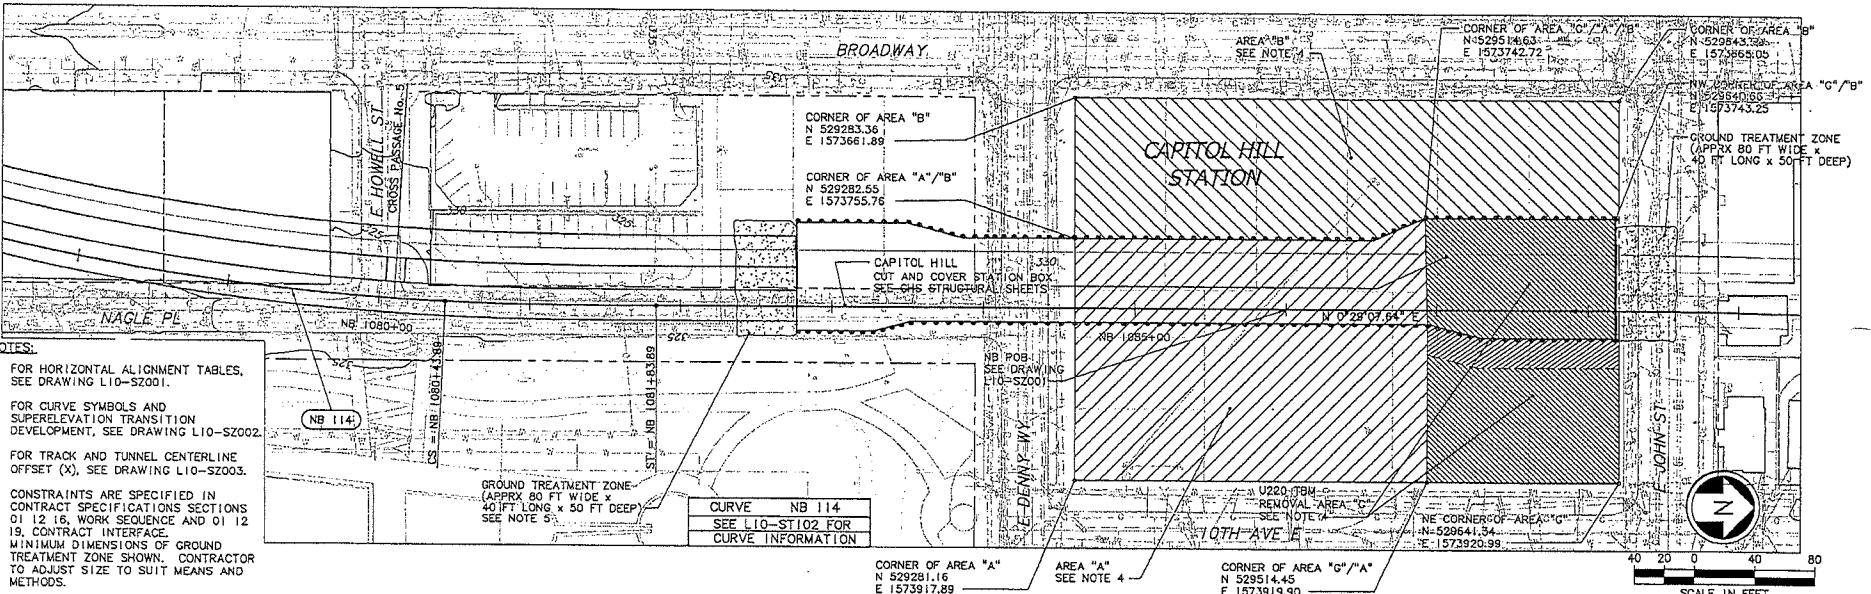
City of Seattle		Designed By: A. MENCKE	Drawn By: H. JORISSEN	Approved By: S. SWARTZ	Submitted By: D. ADAMS	Date: 05/05/09	Approved By: J. SLEAVIN	Date: 05/05/09	Approved By: A. MENCKE	Date: 12/29/08	LINK CONTRACT U220 TBM TUNNELS (UWS TO CHS)	Drawing No.: L10-ST105
Work Order No.	Approved:	Drawn By:	Inspector's Book:	Checked By:	Submitted:	Contract No.:	Contract No.:	Contract No.:	Contract No.:	Contract No.:	TUNNEL STRUCTURE PLAN & PROFILE	Vault Plan No.
Permit No.	Revised:	Revised:	Revised:	Revised:	Approved:	U220	U220	U220	U220	U220	STA NB 1089+00 TO STA NB 1100+00	Sheet No.: 34 Rev.: 0
Date: 05/05/09	Issued For Construction	SDOT:	SDOT:	SDOT:	SDOT:	Date: 05/05/09	Date: 05/05/09	Date: 05/05/09	Date: 05/05/09	Date: 12/29/08		



City of Seattle		Designed By: A. MENCKE	Drawn By: H. JORISSEN	Approved By: S. SWARTZ	Submitted By: D. ADAMS	Date: 05/05/09	Approved By: J. SLEAVIN	Date: 05/05/09	Date: 12/29/08	Scope: H: 14' = 40'; V: 14' = 40' File name: U20_L10_ST104.DWG Contract No.: U220	LINK CONTRACT U220 TBM TUNNELS (UWS TO CHS) TUNNEL STRUCTURE PLAN & PROFILE STA NB 1088+15.65 TO STA NB 1089+00	Drawing No.: L10-ST104 Vault Plan No. Sheet No.: 35 Rev.: 0
No.	Date	Bsn.	Chk.	App.	Revisions	SDOT:	Approved By: A. MENCKE					
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SEE DWG L10-ST03

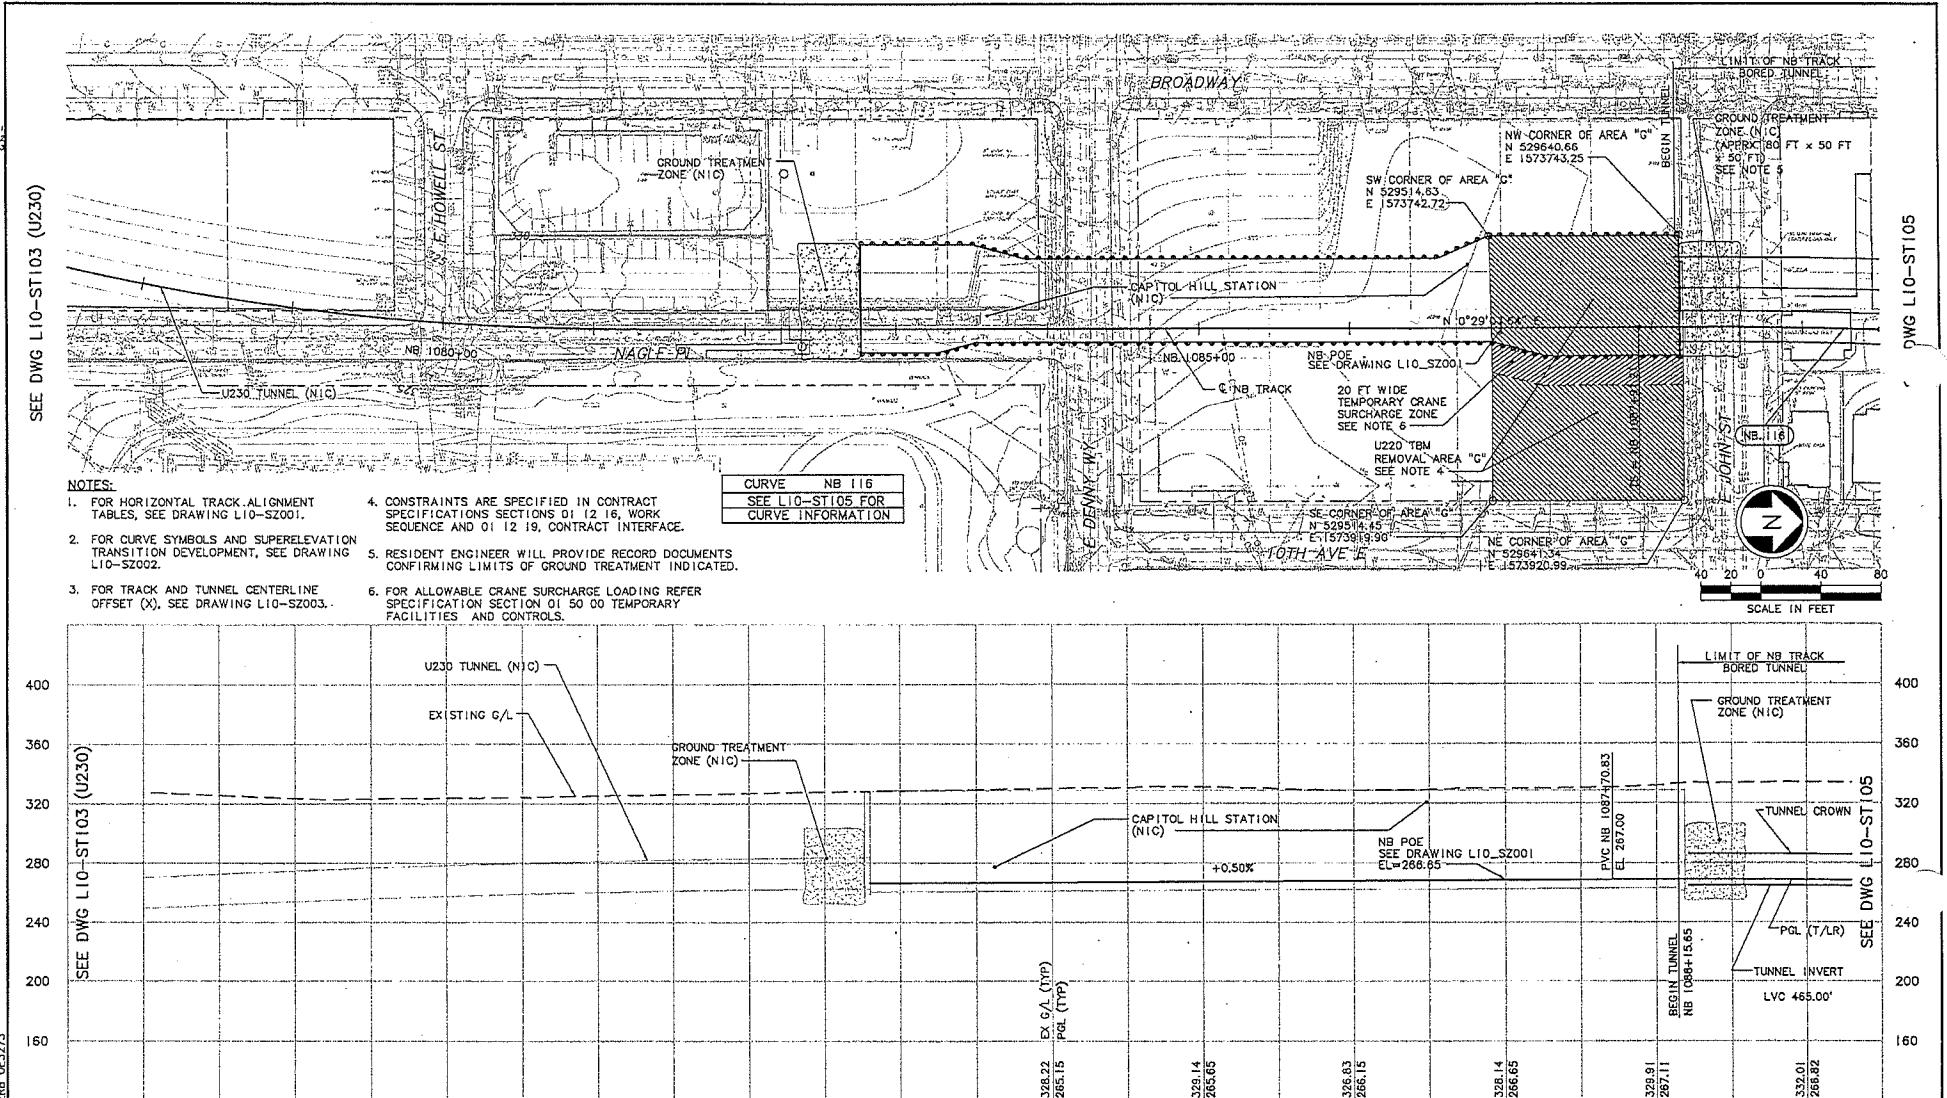

City of Seattle		Designed By: A. MENCKE	Drawn By: H. JORISSEN	Approved By: D. ADAMS	Submitted By: J. SLEAVIN	Contract No.: U230	Link Contract U230 TBM TUNNELS (CHS TO PSST)	Drawing No.: L10-ST104
Work Order No.	Approved:							
Permit No.	Inspector's Book:							
Received:	Checked By:	S. SWARTZ						
Revised As Built:	Approved By:	A. MENCKE						
Date: 01/11/09	Date: 11/06/09	Date: 11/06/09	Date: 11/06/09	Date: 01/20/09				
Issued For Construction	SDOT:							
No. Date: 01/11/09	Don. City. App. Revisions							



PIERS

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X1431UJ

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UDC-L10-SP

UDC-L10-SV

UDC-L10-M4

X1430P

X1430X

X1431M

ZC-223-42A

Zp-p300070

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XREF'S
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X344UT
X344UT
X344UT
Zg-9200
Unresolved
LTSICAL
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RECEIVED IN LIBRARY OF THE UNIVERSITY OF TORONTO LIBRARIES
SERIAL NO. DATE ISSUED DATE DUE

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SEE DWG L10-ST1101

NOTES:


1. FOR HORIZONTAL ALIGNMENT TABLES, SEE DRAWING L10-SZ001.
 2. FOR CURVE SYMBOLS AND SUPERELEVATION TRANSITION DEVELOPMENT, SEE DRAWING L10-SZ002.
 3. FOR TRACK AND TUNNEL CENTERLINE OFFSET (X), SEE DRAWING L10-SZ003.

CURVE	NB 114
PI STA.	NB 1072+34.89
R	1635.00
Lc	2813.07
Ls1	140.00
Ls2	140.00
Ea	2.50"
Eu	2.40"
V	45 MPH

DONG LIO-ST103



SCALE IN FEET

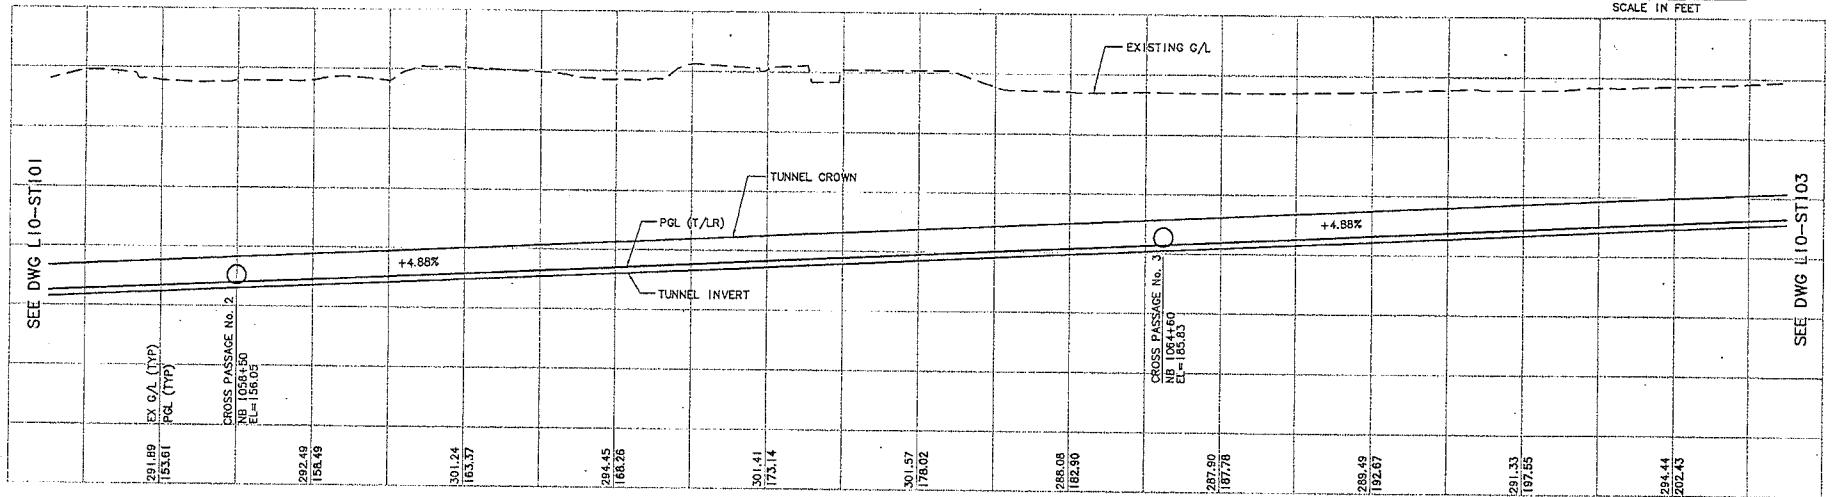

 City of Seattle

Order No.	Approved:
No.	Inspector's Book
	Received:
	Revised As Built:



 SOUNDTRANSIT

LINK CONTRACT U230
TBM TUNNELS (CHS TO PSST)

TUNNEL STRUCTURE
PLAN & PROFILE

Drawing No.:	L10-ST102
Vault Plan No.:	
Sheet No.:	Rev.:
38	0

<u>XRD's</u>
<u>Resolved</u>
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U15_R05_SF
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X344EF
X346UT
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RDC-ASW
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1	2	4	8
1	2	4	8

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SEE DWG L10-ST100

CURVE NB 114
SEE L10-ST102 FOR
CURVE INFORMATION

BOREN AVE

MINOR AVE

BELIEVE AVE E

CRAWFORD PL

UNION ST

SUMMIT AVE

CROSS BLOCKAGE No. 1

EXISTING T-5 CONSTRUCTION SHAFT (N/C) SEE NOTE 4

NOTES:

1. FOR HORIZONTAL ALIGNMENT TABLES, SEE DRAWING L10-SZ001.
2. FOR CURVE SYMBOLS AND SUPERELEVATION TRANSITION DEVELOPMENT, SEE DRAWING L10-SZ002.
3. FOR TRACK AND TUNNEL CENTERLINE OFFSET (X), SEE DRAWING L10-SZ003.
4. T-5 CONSTRUCTION SHAFT COMPLETED AS PART OF THE U215 CONTRACT AS-BUILTS TO BE PROVIDED TO U730 CONTRACTOR AS

ST 1047+21.38

ST 1047+21.39

ST 1050+00.82

ST 1052+36.81

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40 20 0 40 80

 City of Seattle

Order No.	Approved:
Alt. No.	Inspector's Book:
	Received:
	Revised As Built:



The SoundTransit logo consists of a stylized 'S' icon above the word "SOUNDTRANSIT".

LINK CONTRACT U230
TBM TUNNELS (CHS TO PSST)

TUNNEL STRUCTURE

PLAN & PROFILE

Drawing No.:

L10-ST101


ERIC 016161

Yacht Plan No.

Sheet No.: Rev.: 3A 9

33

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FISCAL NOTE FOR NON-CAPITAL PROJECTS

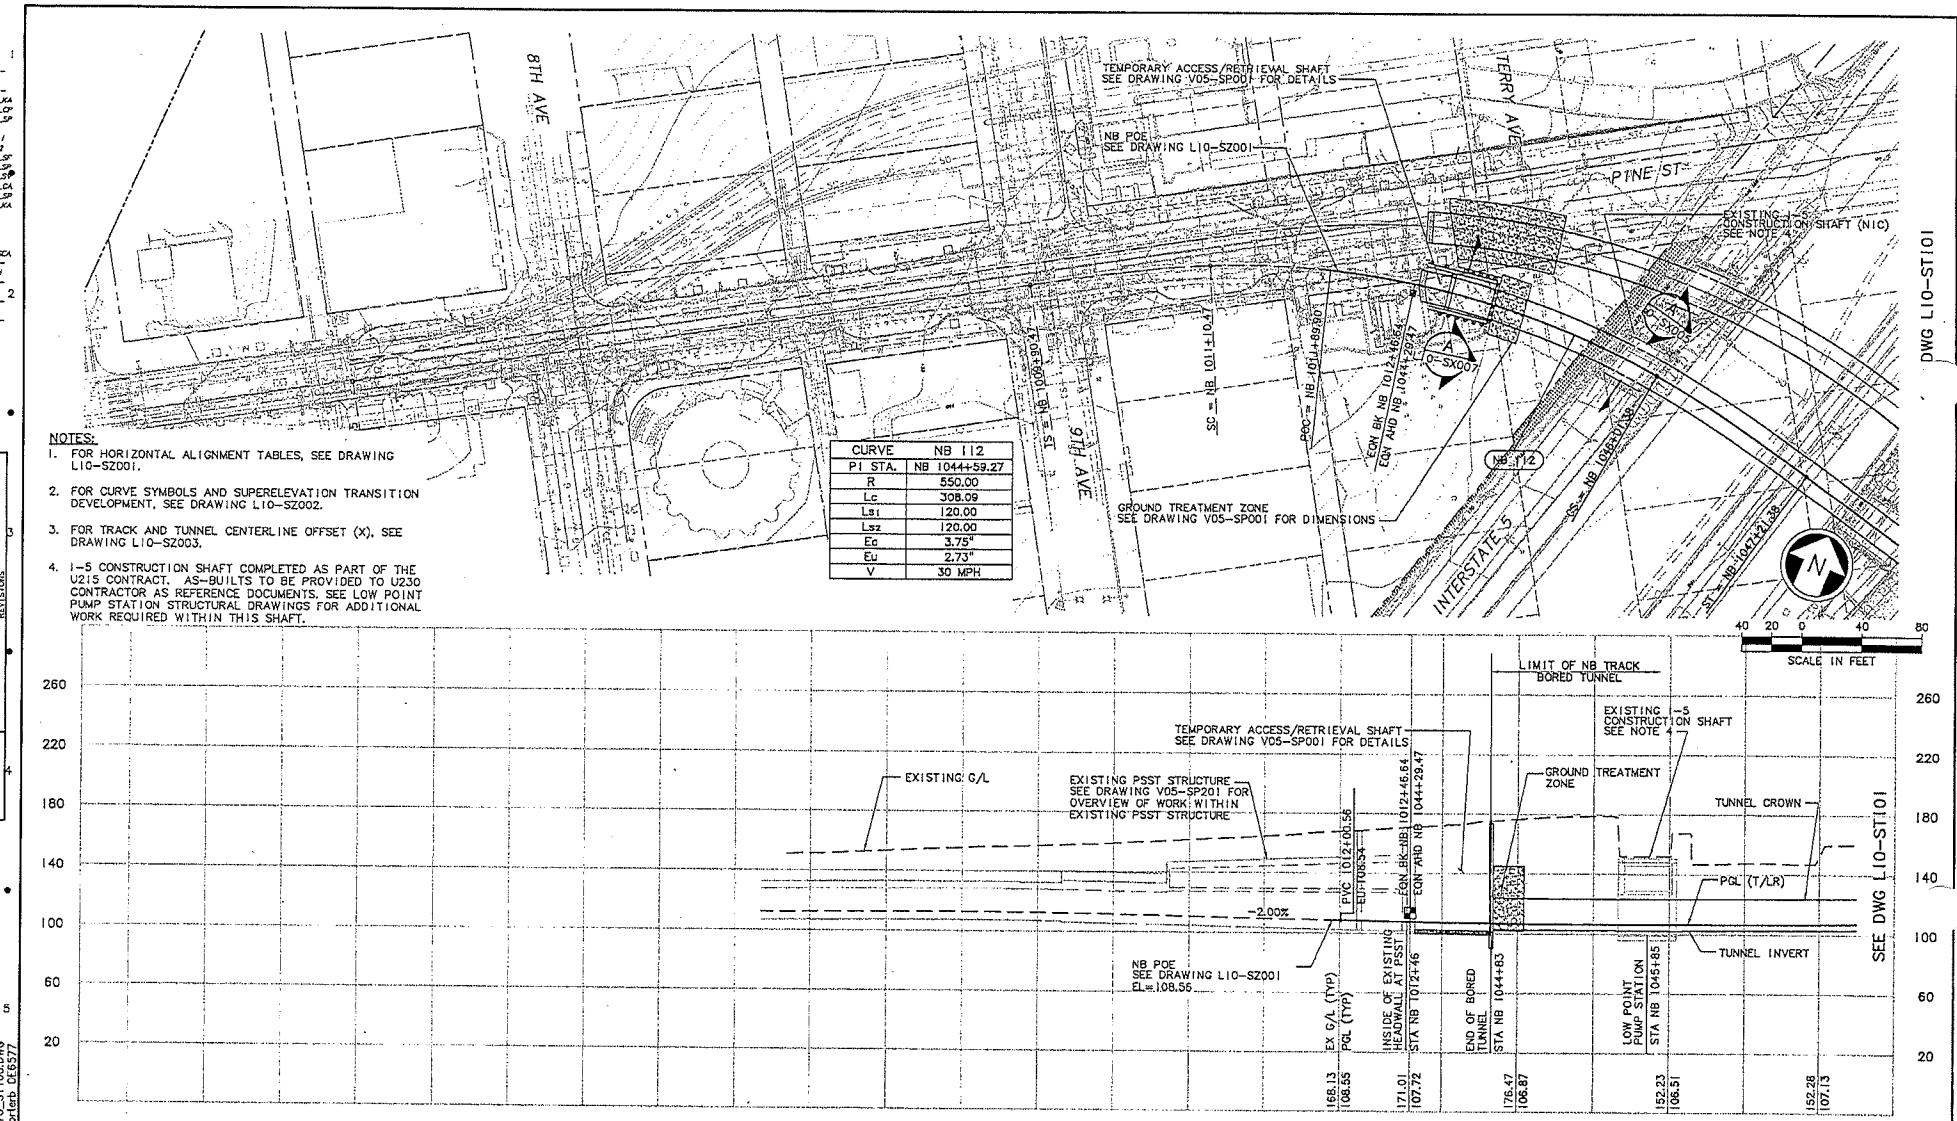Department:	Contact Person/Phone:	CBO Analyst/Phone:
Seattle Department of Transportation	Ethan Melone/684-8066	Anthony Colelo/684-5292

Legislation Title:

AN ORDINANCE related to the Central Puget Sound Regional Transit Authority (“Sound Transit”) authorizing the Director of the Seattle Department of Transportation to execute an amendment to the Agreement between the City of Seattle and Sound Transit for Grant of Non-Exclusive Use of a Light Rail Transit Way as related to the Central Link Light Rail Transit Project to reflect the approved alignment for the Link Light Rail Transit Project, including the revised Northgate Link Extension and portion of the East Link segment located within the City of Seattle.

Summary of the Legislation:

The City and Sound Transit have entered into a Transit Way Agreement which authorizes non-exclusive use of the City right-of-way for the Link Light Rail System. The Northgate Link and East Link extensions have now reached the point in project development at which the alignment has been finalized and the Transit Way Agreement can be amended to incorporate these project alignments. All other terms of the Agreement will remain unchanged.

Background:

The City authorizes the construction of Sound Transit’s Link Light Rail transit facilities within City right-of-way through the execution of a Transit Way Agreement and subsequent permitting activities. The alignment ordinance provides an approval of the alignment and locations of these facilities, providing the policy context for the permitting of the facilities.

Please check one of the following:

This legislation does not have any financial implications.

This legislation has financial implications.



Other Implications:

a) Does the legislation have indirect financial implications, or long-term implications?

No; any City actions related to the Light Rail system will be addressed in separate agreements and legislation. This action only grants a right of use.

b) What is the financial cost of not implementing the legislation?

Not Applicable.

c) Does this legislation affect any departments besides the originating department?

No.

d) What are the possible alternatives to the legislation that could achieve the same or similar objectives?

There is no other means of granting use of the right-of-way for the light rail system.

e) Is a public hearing required for this legislation?

No.

f) Is publication of notice with *The Daily Journal of Commerce* and/or *The Seattle Times* required for this legislation?

No.

g) Does this legislation affect a piece of property?

No, the legislation only affects right-of-way, as shown in the exhibits.

h) Other Issues:

None.

List attachments to the fiscal note below:





City of Seattle
Office of the Mayor

July 9, 2013

Honorable Sally J. Clark
President
Seattle City Council
City Hall, 2nd Floor

Dear Council President Clark:

I am pleased to transmit the attached proposed Council Bill that authorizes the Department of Transportation Director, Peter Hahn, to execute an amendment to the Agreement between the City of Seattle and the Central Puget Sound Regional Transit Authority ("Sound Transit") for Grant of Non-Exclusive Use of a Light Rail Transit Way as related to the Central Link Light Rail Transit Project to reflect the approved alignment of the Link Light Rail Transit Project, including the revised Northgate Link Extension and portion of the East Link segment located within the City of Seattle.

The City and Sound Transit have entered into a Transit Way Agreement as the means of granting non-exclusive use of City right-of-way for implementation of the regional Light Rail system. The Northgate Link and East Link projects have now reached the point in project development at which the alignments are finalized and these projects can be incorporated into the agreement by amendment.

Approval of this legislation will help Sound Transit to proceed with its work to improve transportation and support growth management within our city and region. Thank you for your consideration of this legislation. Should you have questions, please contact Ethan Melone at 206-684-8066.

Sincerely,

A handwritten signature of Michael McGinn.

A handwritten signature of Ethan Melone.

Michael McGinn
Mayor of Seattle

cc: Honorable Members of the Seattle City Council

Michael McGinn, Mayor
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STATE OF WASHINGTON -- KING COUNTY

--ss.

303313

No.

CITY OF SEATTLE, CLERKS OFFICE

Affidavit of Publication

The undersigned, on oath states that he is an authorized representative of The Daily Journal of Commerce, a daily newspaper, which newspaper is a legal newspaper of general circulation and it is now and has been for more than six months prior to the date of publication hereinafter referred to, published in the English language continuously as a daily newspaper in Seattle, King County, Washington, and it is now and during all of said time was printed in an office maintained at the aforesaid place of publication of this newspaper. The Daily Journal of Commerce was on the 12th day of June, 1941, approved as a legal newspaper by the Superior Court of King County.


The notice in the exact form annexed, was published in regular issues of The Daily Journal of Commerce, which was regularly distributed to its subscribers during the below stated period. The annexed notice, a

CT:124272-290 TITLE ONLY

was published on

10/09/13

The amount of the fee charged for the foregoing publication is the sum of \$321.75 which amount has been paid in full.

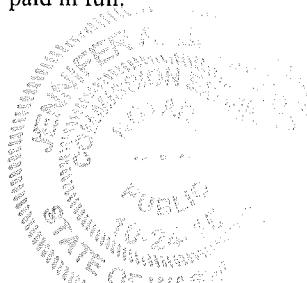

Mel
Subscribed and sworn to before me on
10/09/2013
Melinda Bea

Notary public for the State of Washington,
residing in Seattle

Affidavit of Publication

City of Seattle

The full text of the following legislation, passed by the City Council on September 16, 2013, and published below by title only, will be mailed upon request, or can be accessed at <http://clerk.seattle.gov>. For information on upcoming meetings of the Seattle City Council, please visit <http://www.seattle.gov/council/calendar>. Contact: Office of the City Clerk at (206) 684-8344.

ORDINANCE NO. 124272

AN ORDINANCE relating to land use and zoning; amending the Official Land Use Map to rezone properties located at 525 Northeast Northgate Way from Neighborhood Commercial 3 with a 65 foot height limit (NC3-65) to NC3 with an 85 foot height limit (NC3-85) and accepting a Property Use and Development Agreement in connection with the rezone.

ORDINANCE NO. 124273

AN ORDINANCE relating to the Seattle Building Code, amending Chapter 22.100.010 of the Seattle Municipal Code, and adopting by reference Chapters 2 through 29, Chapters 31 through 33 and Chapter 35 of the 2012 International Building Code, and amending certain of those chapters; adopting a new Chapter 1 related to administration, permitting and enforcement; adopting a new Chapter 30 related to elevators and conveying systems, and repealing Sections 2-33 of Ordinance 123384.

ORDINANCE NO. 124274

AN ORDINANCE relating to the Seattle Plumbing Code, repealing Section 22.500.010 of the Seattle Municipal Code, amending Section 22.502.016 of the Seattle Municipal Code; and adopting by reference Chapter 51-56 of the Washington Administrative Code, and amending certain of those chapters; adopting a new Chapter 1 related to administration, permitting and enforcement; and repealing Sections 2-46 of Ordinance 119774.

ORDINANCE NO. 124275

AN ORDINANCE relating to the Seattle Mechanical Code, amending Chapter 22.400.010 of the Seattle Municipal Code, and adopting by reference Chapters 2 through 9, and Chapters 11 through 15 of the 2012 International Mechanical Code, and amending certain of those chapters; adopting a new Chapter 1 related to administration, permitting and enforcement; and repealing Sections 2-13 of Ordinance 123380.

ORDINANCE NO. 124276

AN ORDINANCE relating to the Seattle Fuel Gas Code amending Section 22.420.010 and adopting by reference Chapters 2 through 8 of the 2012 International Fuel Gas Code, and amending certain of those chapters; adopting a new Chapter 1 for the Seattle Fuel Gas Code related to administration, permitting and enforcement; and repealing Sections 2-7 of Ordinance 123381.

ORDINANCE NO. 124277

AN ORDINANCE accepting for general street purposes 13 deeds and one correction deed conveyed to the City of Seattle by the Central Puget Sound Regional Transit Authority ("Sound Transit") in connection with the Central Link Light Rail Transit Project as agreed to in a Property Acquisition and Transfer Procedures Agreement between the City of Seattle and Sound Transit, dated August 12, 2003 ("Property Transfer

Agreement"); laying off, opening, widening, extending, and establishing portions of the rights-of-way located on Martin Luther King Jr. Way South between South Holly Street and South Othello Street; placing the real property conveyed by the deeds under the jurisdiction of the Seattle Department of Transportation; and ratifying and confirming certain prior acts.

ORDINANCE NO. 124278

AN ORDINANCE vacating the south 240 feet of the alley adjacent to Lots 4-11 in Block 33, D.T. Denny's Home Addition to the City of Seattle, on the petition of the Burkheimer Family Limited Liability Company, a Washington limited liability company, and accepting a Property Use and Development Agreement as reflected in Clerk File 309868.

State of Washington, King County

ORDINANCE NO. 124279

AN ORDINANCE authorizing the acceptance of a conditional gift of funds from the Mark and Susan Torrance Foundation and Rails to Trails Conservancy to be applied towards the purchase of automated bicycle and pedestrian counters, the installation of said counters, the posting of data collected by some of these counters on a public facing website, expressing the City's gratitude for the gift, and ratifying and confirming prior acts.

ORDINANCE NO. 124280

AN ORDINANCE relating to the City Light Department, authorizing the General Manager and Chief Executive Officer to execute an amendment to an agreement with the Sacramento Municipal Utility District.

ORDINANCE NO. 124281

AN ORDINANCE appropriating money to pay certain audited claims and ordering the payment thereof.

ORDINANCE NO. 124282

AN ORDINANCE relating to the Seattle Residential Code, amending Section 22.150.010, and adopting by reference Chapters 2 through 10, 12 through 24, Section P2904, 44, and Appendices F and G of the 2012 International Residential Code, and amending certain of those chapters; adopting a new Chapter 1 related to administration, permitting and enforcement; and repealing Sections 2-18 of Ordinance 123383.

ORDINANCE NO. 124283

AN ORDINANCE relating to the Seattle Existing Building Code, amending Chapter 22.110 of the Seattle Municipal Code and adopting by reference Chapters 2 through 5, 7 through 11, 13 through 16, A1, and A3 through A6 of the 2012 International Existing Building Code; amending certain of those chapters, and adopting a new Chapter 1 related to administration, permitting and enforcement; and repealing Sections 2-12 of Ordinance 123379.

ORDINANCE NO. 124284

An Ordinance relating to the Seattle Energy Code, amending Section 22.700.010 of the Seattle Municipal Code; and adopting by reference Chapters 51-11C and 51-11R of the Washington Administrative Code, and amending certain of those chapters; and repealing Sections 2-18 of Ordinance 123430.

ORDINANCE NO. 124285

AN ORDINANCE related to establishing a Local Infrastructure Project Area for Downtown and South Lake Union; authorizing the Mayor to execute an interlocal agreement with King County.

ORDINANCE NO. 124286

AN ORDINANCE accepting an allocation of transferrable development rights and adopting an infrastructure funding plan to support the creation of a Landscape Conservation and Local Infrastructure Program.

ORDINANCE NO. 124287

AN ORDINANCE creating a Local Infrastructure Project Area and amending Sections 23.48.011, 23.49.011, and 23.58A.044 of the Seattle Municipal Code to implement a Landscape Conservation and Local Infrastructure Program.

ORDINANCE NO. 124288

AN ORDINANCE relating to the Seattle Fire Code, adopting as the Seattle Fire Code the 2012 edition of the International Fire Code with some exceptions, amending and adding various provisions to that code; amending Section 22.600.020 of the Seattle Municipal Code; and repealing Sections 2-44 of Ordinance 123393.

ORDINANCE NO. 124289

AN ORDINANCE related to the Central Puget Sound Regional Transit Authority ("Sound Transit") authorizing the Director of the Seattle Department of Transportation to execute an amendment to the Agreement between the City of Seattle and Sound Transit for Grant of Non-Exclusive Use of a Light Rail Transit Way as related to the Central Link Light Rail Transit Project to reflect the approved alignment for the Link Light Rail Transit Project, including the revised Northgate Link Extension and portion of the East Link segment located within the City of Seattle.

ORDINANCE NO. 124290

AN ORDINANCE relating to grant funds from non-City sources; authorizing the Director of Transportation (Director) to accept specified grants and execute related agreements for and on behalf of the City; changing appropriations in the 2013 Adopted Budget for the Seattle Department of Transportation (SDOT); adding a new project; revising allocations for certain projects in the 2013-2018 CIP; and ratifying and confirming certain prior acts.

Date of publication in the Seattle Daily Journal of Commerce, October 9, 2013.
10/9/303313